
# City of Glendale Community Development Department Design Review Staff Report – Single Family

Meeting/Decision Date: April 15, 2019	Address: 1325 Sonora Avenue
Review Authority: □DRB ⊠ADR □HPC □CC	APN: 5622-022-032
Case Number: PDR1828390	Applicant: Aram Mnatsakanian
Prepared By: Cassandra Pruett	Owner: Yervand Minasyan
Project Summary The applicant is proposing a 332 square-foot (SF), o existing one-story, 1,523 SF single-family house (built in the story).	
Existing Property/Background The subject property is a 9,576 SF interior lot on the we shape and relatively flat. The property is improved with with a detached two-car garage. The proposed project District I and complies with all current Zoning Code regratio, parking, and landscaping.	an existing one-story, 1,523 SF single-family house is in the R1-I (Residential) Zone, Floor Area Ratio
Staff Recommendation  ☐ Approve ☐ Approve with Conditions ☐	Return for Redesign Deny
Last Date Reviewed / Decision  ☐ First time submittal for final review. ☐ Other:	
Zone: R1 FAR District: I Although this design review does not convey final zonic consistency with the applicable Codes and no inconsis	
Active/Pending Permits and Approvals  ☑ None ☐ Other:	
CEQA Status:  ☑ The project is exempt from CEQA review as a Class 15301 of the State CEQA Guidelines because the puthat will not result in an increase of more than 50 percesquare feet, whichever is less.  ☐ The project is exempt from CEQA review as a Class Structures" exemption pursuant to Section 15303 of Other:	proposed project is an addition to an existing structure ent of the floor area before the addition, or 2,500 as 3 "New Construction or Conversion of Small
Site Slope and Grading  ☑ None proposed ☐ Less than 50% current average slope and less than and/or fill); no additional review required. ☐ 1500 cubic yards or greater of earth movement:	n 1500 cubic yards of earth movement (cut
☐ 50% or greater current average slope:	

## Comparison of Neighborhood Survey:

	Average of Properties within 300 linear feet of subject property	Range of Properties within 300 linear feet of subject property	Subject Property Proposal
Lot size	9,271	7,030-11,732 SF	9,576
Setback	40'	27'-7" - 58'-3"	35'
House size	1,654 SF	960 - 2,758 SF	1,855
Floor Area Ratio	18%	8 - 29%	20%
	1.2	1 - 2	1
Number of stories	13 one-story houses		
	3 two-story houses		

Number of stories	13 one-story houses		
-	3 two-story houses		9
DESIGN ANALYSIS	<b>;</b>		
Site Planning Are the following items	satisfactory and compatib	ole with the project site and	surrounding area?
Building Location ⊠ yes ☐ n/a ☐	n ⊒ no		
If "no" select from be □Setbacks of buil □Prevailing setba □Building and de	ldings on site		
Garage Location ∈	and Driveway ]no		
If "no" select from be  ☐Predominant pa ☐Compatible with ☐Permeable pavi ☐Decorative pavi	nttern on block n primary structure ng material		
Landscape Desig ☐ yes  ⊠ n/a  □			
	to building designing trees when possible neable surfaces		
Walls and Fences ☐ yes  ⊠ n/a □	s ] no		
If "no" select from be  □Appropriate style □Perimeter walls □Retaining walls	e/color/material treated at both sides		

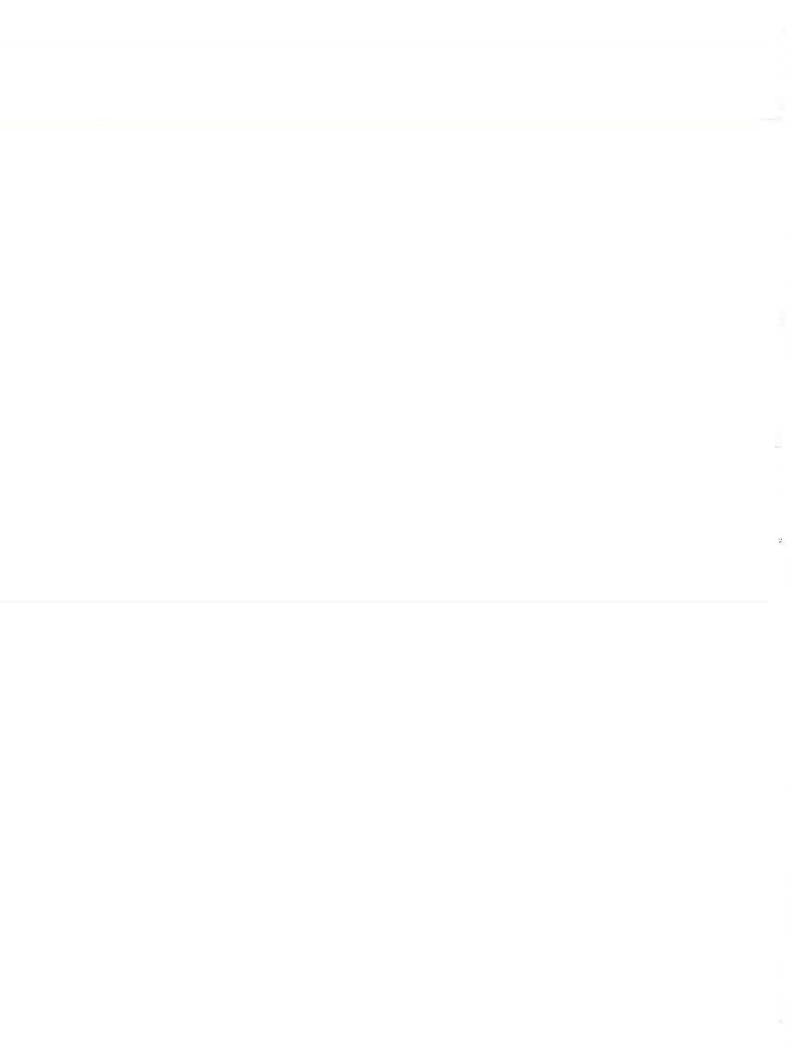

□ Appro	priately	sized	and	Incated
m, MAIO	PLICTOLA	SIZCU	anu	IUGGEU


☐Roof reinforces design concept ☐Configuration appropriate to context

## **Determination of Compatibility: Site Planning**

The proposed site planning is appropriate, as modified by any proposed conditions, to the site and its surroundings for the following reasons:

- The 332 SF addition is an up to nine-foot wide addition for the length of the existing house that maintains the required four-foot interior setback.
- The addition maintains the prevailing street-front setback, and its placement is consistent with neighboring houses that have front facades extending the full width of the property.

	-	
Massing and Scale Are the following items satisfactory and compatible w	vith the proje	ect site and surrounding area?
Building Relates to its Surrounding Context ⊠ yes ☐ n/a ☐ no		
If "no" select from below and explain:  □Appropriate proportions and transitions □Relates to predominant pattern □Impact of larger building minimized		
Building Relates to Existing Topography ⊠ yes ☐ n/a ☐ no		
If "no" select from below and explain:  □Form and profile follow topography □Alteration of existing land form minimized □Retaining walls terrace with slope		
Consistent Architectural Concept ⊠ yes ☐ n/a ☐ no		
If "no" select from below and explain: Concept governs massing and height		
Scale and Proportion ⊠ yes □ n/a □ no		
If "no" select from below and explain:  □Scale and proportion fit context □Articulation avoids overbearing forms □Appropriate solid/void relationships □Entry and major features well located □Avoids sense of monumentality		
Roof Forms ⊠ yes ☐ n/a ☐ no		
If "no" select from below and explain:		

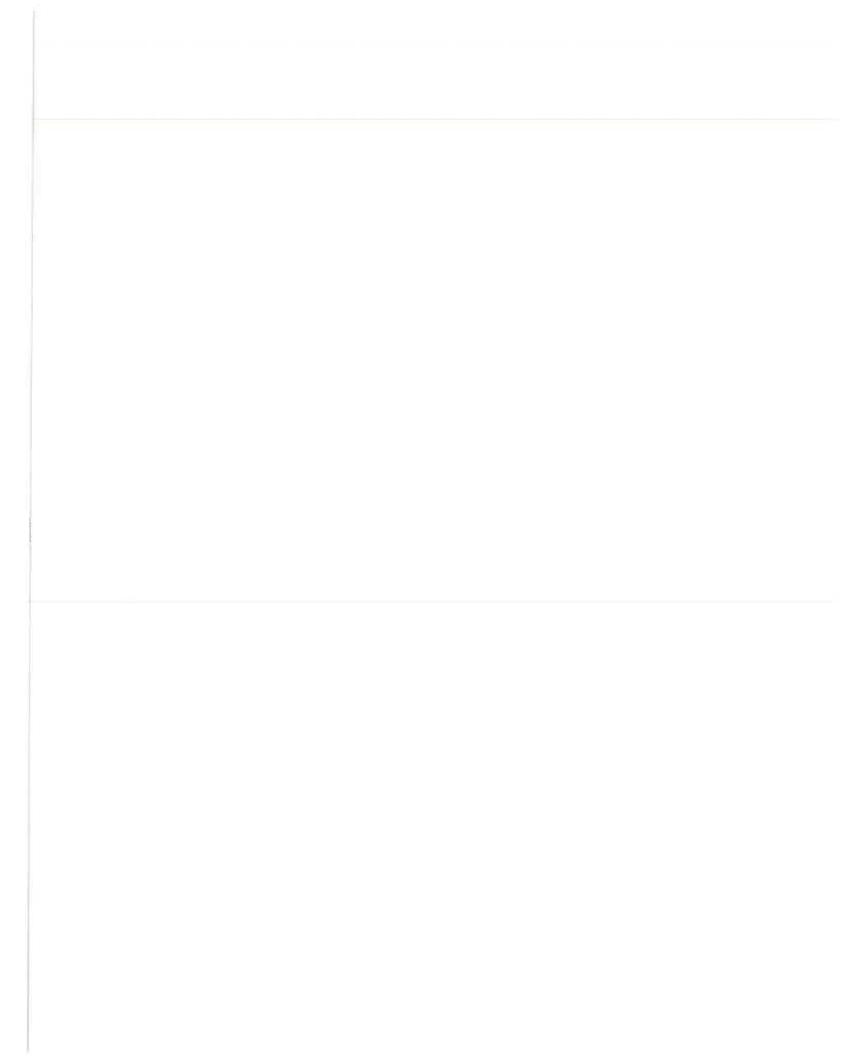


## **Determination of Compatibility: Mass and Scale**

□Natural colors used in hillside areas

The proposed massing and scale are appropriate, as modified by any proposed conditions, to the site and its surroundings for the following reasons:

- The minor addition consists of an extension of the front façade by approximately five feet.
  The addition continues the existing roof and wall line at the front and the decorative roof and wing wall forms at the location of the addition. These roof and wall forms break up the massing and are consistent with the existing Spanish Revival style.
- The addition on the southwest façade (facing the neighbor) maintains a variation in planes to help break up the massing.

	ign and Detailing the following items satisfactory and compatible with the project site and surrounding area?
	Overall Design and Detailing ⊠ yes
	Entryway □ yes  ⊠ n/a  □ no
.I.	f "no" select from below and explain:  □Welt integrated into design □Avoids sense of monumentality □Design provides appropriate focal point □Doors appropriate to design
	Mindows ⊠ yes     □ n/a     □ no
h	f "no" select from below and explain:  □Appropriate to overall design □Placement appropriate to style □Recessed in wall, when appropriate
	Privacy ⊠ yes  □ n/a  □ no
fi	f "no" select from below and explain:  □Consideration of views from "public" rooms and balconies/decks  □Avoid windows facing adjacent windows
22	Finish Materials and Color ☑ yes  ☐ n/a ☐ no
H	f "no" select from below and explain:  Textures and colors reinforce design High-quality, especially facing the street Respect articulation and façade hierarchy Wrap corners and terminate appropriately

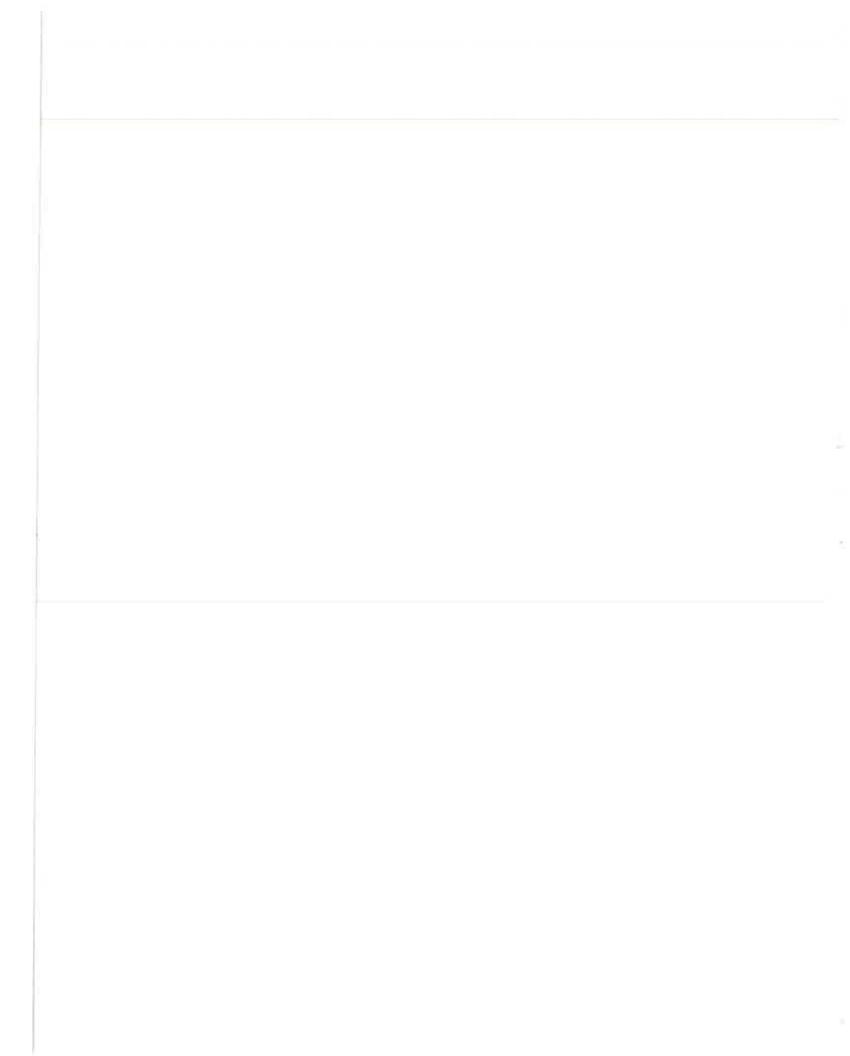

Paving Materials  ☐ yes ☑ n/a ☐ no
If "no" select from below and explain:  □Decorative material at entries/driveways □Permeable paving when possible □Material and color related to design
Equipment, Trash, and Drainage  ☐ yes ☑ n/a ☐ no
If "no" select from below and explain:  □ Equipment screened and well located  ⊠ Trash storage out of public view  □ Downspouts appropriately located  □ Vents, utility connections integrated with design, avoid primary facades
Ancillary Structures ☐ yes  ☑ n/a  ☐ no
If "no" select from below and explain:  □Design consistent with primary structure  □Design and materials of gates complement primary structure

## **Determination of Compatibility: Design and Detailing**

The proposed design and detailing are appropriate, as modified by any proposed conditions, to the site and its surroundings for the following reasons:

- The proposed modifications are consistent with the existing Spanish Revival style house. The stucco
  on the entire house is being updated to a smooth finish with a light gray color which, along with the
  Spanish tile roofing on the parapet, will continue onto the addition.
- The new front façade window duplicates the existing adjacent window in style and appearance, including the arched stucco imprint above the window which is a common Spanish Revival feature.
- All new and replacement windows visible from the street are recessed with wood trim and sill to match the original windows on the house.
- New window locations are staggered from windows on the adjacent house to preserve privacy.

## Recommendation / Draft Record of Decision


Based on the above analysis, staff recommends approval of the project with conditions, as follows:

### Conditions

 Replace any existing windows visible from the street that are sliding, or have internal grids, in order to comply with the Window Replacement Design Guidelines. Maintain window operation of all existing double casement windows visible from street, unless required by Building Code to be single casement.

### **Attachments**

- 1. Location Map
- 2. Neighborhood Survey
- 3. Photos of Existing Property
- 4. Reduced Plans

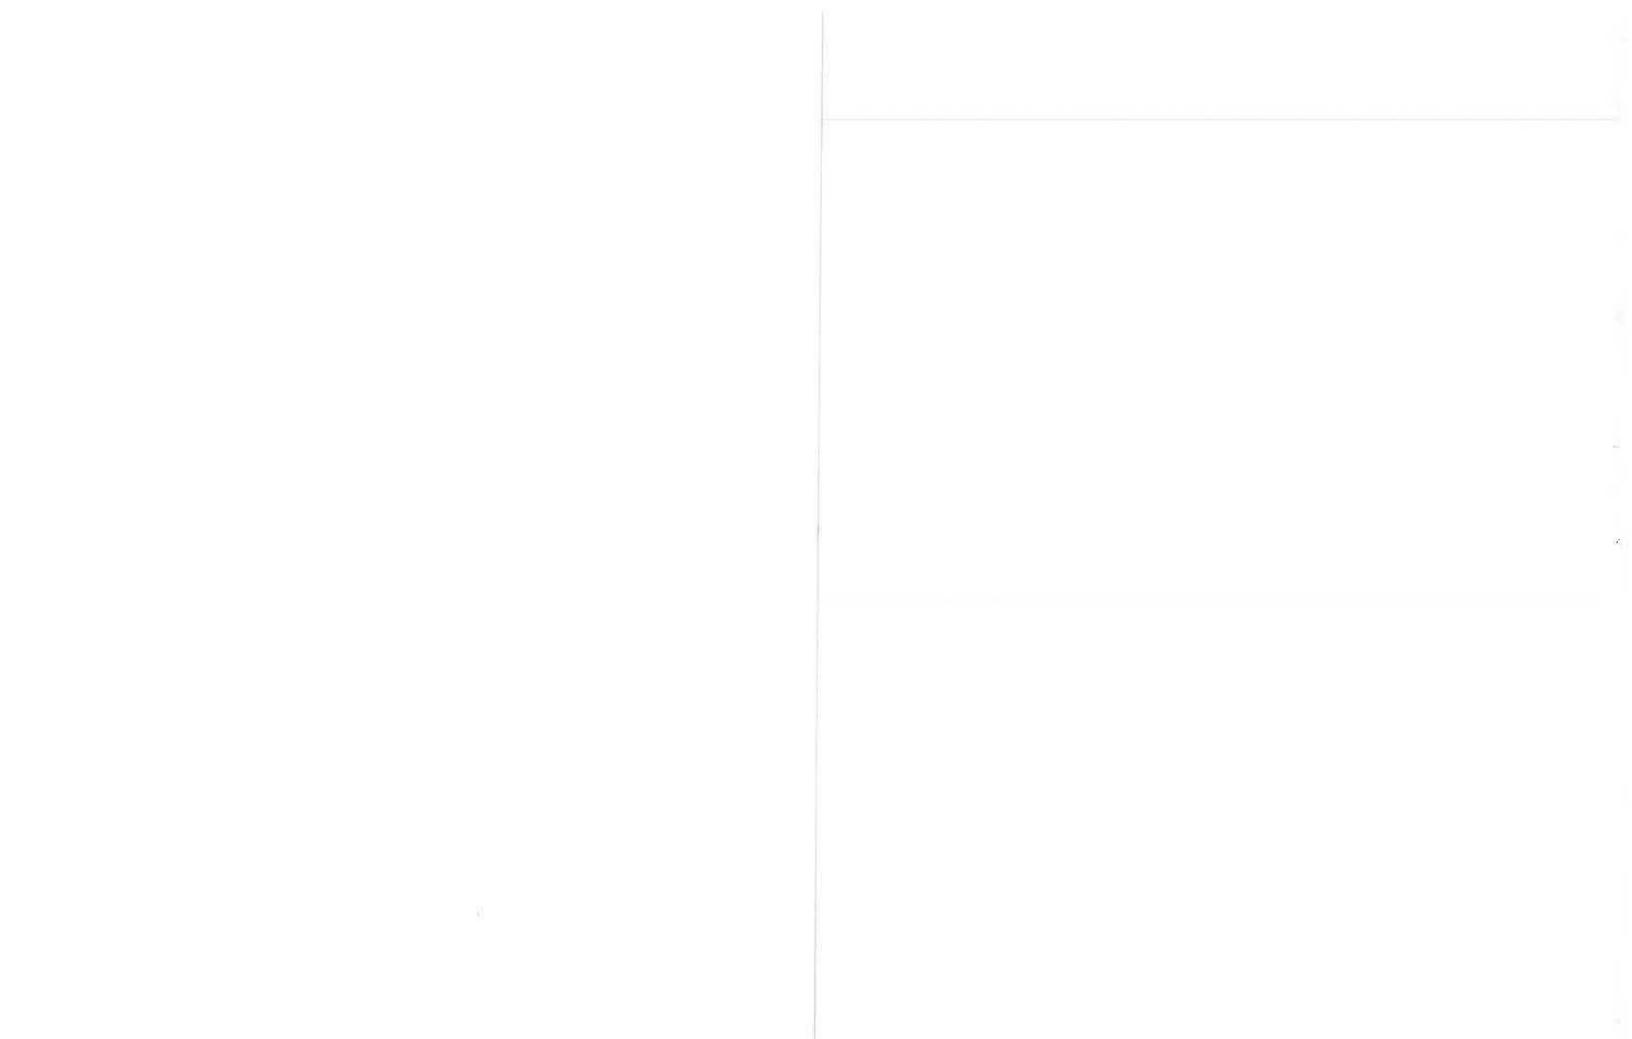

# LOCATION MAP SCALE: 1"=200'



# **SURVEY LIST**

	ADDRESS	HEIGHT (STORIES)	FAR	SETBACK	HOUSE SIZE (SQFT.)	LOT SIZE (\$QFT.)
1	1501 W. KENNETH RD.	1	0.16	50′-9"	1,749	10,754
2	1315 SONORA AVE.	1	0.17	42'-11"	1,580	9,189
3	1321 SONORA AVE.	1	0.19	41′-1"	1,819	9,562
4	1329 SONORA AVE.	1	0.13	42'-10"	1,268	9,574
5	1335 SONORA AVE.	1	0.18	40'-8"	1,713	9,549
6	1339 SONORA AVE.	٦ ،	0.16	41′-2″	1,534	9,564
7	1343 SONORA AVE.	2	0.15	41′-5″	1,482	9,653
8	1347 SONORA AVE.	2-	0.29	38′-7″	2,758	9,453
9	1348 SONORA AVE.	1	0.23	27'-7"	1,248	5,525
10	1342 SONORA AVE.	1 .	0.27	27'-10"	1,928	7,030
11	1338 SONORA AVE.	1	0.21	36'-6"	1,584	7,611
12	1332 SONORA AVE.	1	0.20	37′-3″	1,742	8,555
13	1328 SONORA AVE.	1	0.16	46'-5"	1,566	9,502
14	1322 SONORA AVE.	Ĵ	0.16	35'-9"	1,548	9,857
15	1318 SONORA AV.E	2	0.18	38′-6″	1,987	11,229
16	1314 SONORA AVE.	1.	0.08	58'-3"	960	11,732
17	1 435 KENNETH RD. (NON RESIDENTIAL)	1	0.09	0'-0"	640	7,464

AVB

1- 博2-3

401

1654

9271



SUBJECT PROPERTY FROM SONORA AVE.



**ENTRY VIEW** 












WEST ELEVATION



EAST ELEVATION

ARCHDESIGN
& CONSTRUCTION

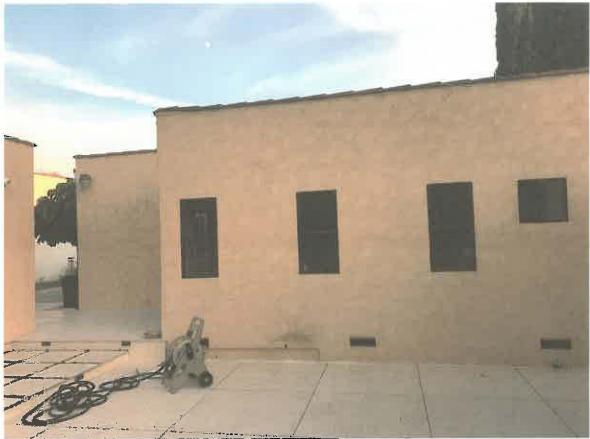


BACKYARD\_1



BACKYARD\_2



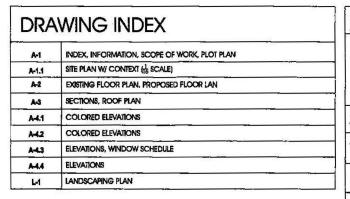

# LEGAL DESCRIPTION

TRACT # LOT: ZONE:

## SCOPE OF WORK

332 S.F. ADDITION TO EX. SFD

5622022032 04045 APN: TAX RATE AREA (TRA): 6165 84 R1 1

## **BUILDING TYPE**

TYPE V-B MAX HEIGHT 15'-0" Y.B. 1925/1935

## **BUILDING USE**

SINLGE FAMILY RESIDENTIAL R-3

## FAR CALCULATION

PROPERTY
EX. HOUSE
EX. FROMT PORCH
EX. GARAGE
PROPOSED ADDITION
TOTAL HOUSE 9,576 S.F. 1,523 S.F. 113 S.F. 539 S.F. 332.2 S.F.


MAX FAR ALLOWABLE: 9,576 \* 30% = 2,872.8 S,F. {1855.2 + 539 - 500} = 1894.2/9576 = 19,8% 1894.2 < 2,872.8

## LOT COVERAGE

9,576 \* 40% = 3,830 S.F. 1855,2 + 113 + 539 = 2507,2 2507,2 < 3,830

## LANDSCAPING

9,576 \* 40% = 3,830 S.F. LANDSCAPING : A = 1793.7 S.F. B = 2347.5 S.F. C = 106 S.F. 1793.7+2347.5+106 = 4247.2 S.F. 4247.2 > 3830

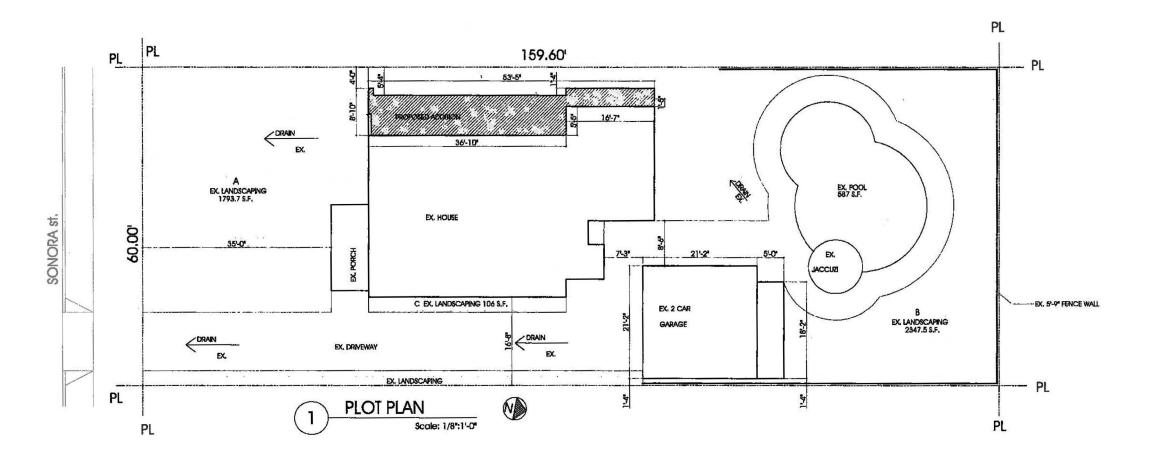

ARCH-DESIGN & CONSTRUCTION CO., INC

TEL (818) 517-5224

409 IRVING DR. BURBANK, CA 91504


YERVAND MINASYAN 818-631-6008	
PROJECT	
ADDITION TO EXISTING 1 STORY S.F.D.	
1325 SONORA AVE., GLENDALE, CA 91201	

CONNECTION WITH ANY WORK OR PROJECT ON BERTHAN THE SPECIFIC PROJECT FOR WHICH THEY HAVE BEEN INTERPARED AND DEVELOPED WITHOUT THE WRITTEN CONSENT OF ARCHODISCHOOL WITHOUT CONTACT WITH THESE DRAWMINGS SHALL CONSTITUTE CONCUSTING PRODUCE OF THESE ESTIMICTURES. RESTRICTIONS,

CONTRACTOR TO VERIFY ALL DIMENSIONS, CONDITIONS, ETC., PERTAINING TO THE WORK AT THE SITE BEFORE PROCEEDING WITH WORK.

1
Y
W

DRAWN BY	_
	1046161
CHECKED BY	ALDANA INI,
DESIGN BY	ARAM M.
SCALE	
DATE	
JOS NO.	8.
Α	-1

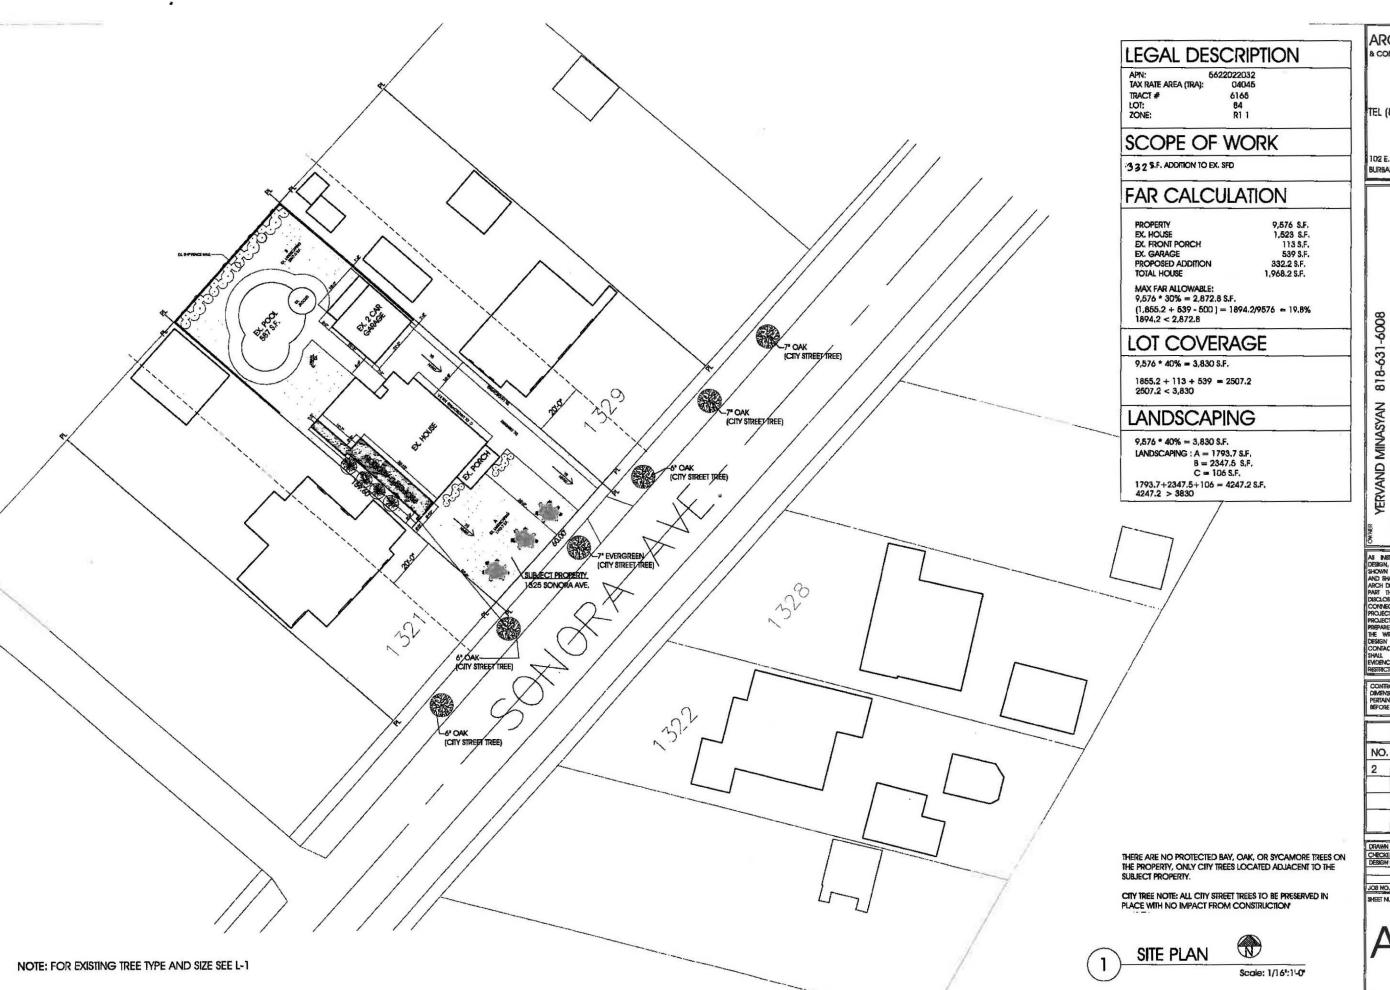

ARCH-DESIGN

& CONSTRUCTION CO., INC.

TEL (818) 517-5224

102 E. PROSPECT AVE., BURBANK, CA 91502


CA 91 ADDITION TO EXISTING 1 STORY S.F.D. 1325 SONORA AVE., GLENDALE,


AS INSTRUMENT OF SETMOE, ALL DESIGN, DEAS AND REFORMATION SHOWN ON THESE DRAWNINGS ARE AND SHALL REMAIN THE PROPERTY OF ARCH DESIGN & CONSTILLION, NO PART THEREOF SHALL BE COPPED, DISCLOSED TO CHIEFS, OR USED IN CONNECTION WITH ANY WORK OR PROJECT OTHER THAN THE SPECIFIC PROJECT ON STRUMENT OF ARCH DESIGN BE CONSTITUTION. WISIAL CONTACT WITH THESE DRAWNINGS SHALL CONSTITUTE CONCLUSIVE EVIDENCE OF ACCEPTANCE OF THESE RESTRICTIONS.


CONTRACTOR TO VERBY ALL DEVENSIONS, CONDITIONS, ETC., PERTANNAG TO THE WORK AT THE STE BEFORE PROCEEDING WITH WORK.

REVISIONS						
NO.	ISSUE	BY				
2	02.13.19	AM				
-						

JOB NO.

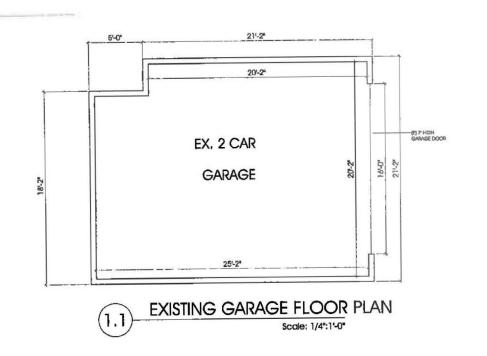

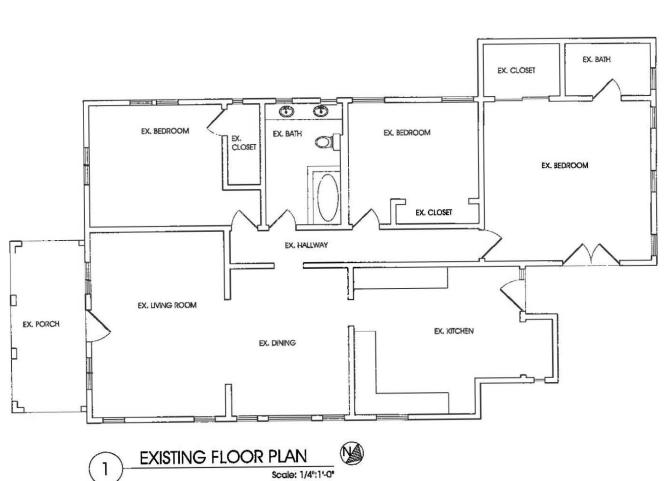

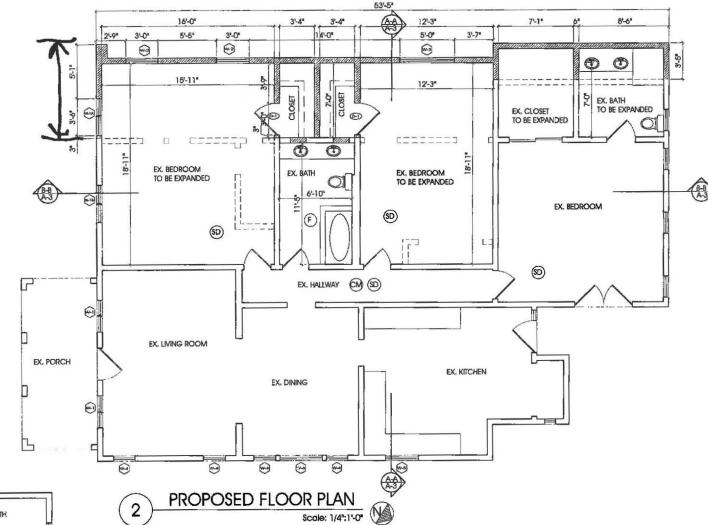



EX. WALL TO REMAIN

PROPOSED WALL

EX, WALL TO BE REMOVED

- (SD) HARD-WIRED SMOKE DETECTOR WITH BATTERY BACK UP. A SMOKE DETECTOR SHALL BE INSTALLED IN EACH SLEEPING ROOM AND AT A POINT CENTRALLY (JOCATED IN THE CORRIDOR OR AREA GIVING ACCESS TO EACH SLEEPING AREA, BATTERY OPERATED SMOKE DETECTOR PERMITTED IN EXISTING CONSTURCTION.
- (F) ELECTRICAL FAN WITH MIN. 5 AIR CHANGE PER HOUR TO OUTSIDE, ELECTRICAL FAN MUST BE CONNECTED TO THE LIGHT SWITCH.
- CARBON MONOXIDE DETECTOR

[N-] PROVIDE 72\* NON-ABSORBENT WALL SURFACE IN ALL BATHTUB AND SHOWER COMPARTMENTS,

WINDOW SYMBOL. SEE A-4.3 FOR WINDOW SCHEDULE

DOOR SYMBOL.

# DOOF	DOOR	SIZE	MAT.	TYPE	REMARKS
	WIDTH	HEIGHT	- WALL	INC.	KEIVIAKKS
1	2'-8"	6'-8"	HOLLOW CORE	SWING	

TEL (818) 517-5224

TEL (8

ARCH-DESIGN

& CONSTRUCTION CO., INC

AS INSTRUMENT OF SERVICE, ALL
DESIGN, DEAS AND INFORMATION
SHOWN ON THESE DRAWNIGS ARE
AND SHALL REMAIN THE PROPERTY OF
ARCH DESIGN & CONSTRUCTION, NO
PART THEREOF SHALL BE COPIED,
DISCLOSED TO OTHERS, OR USED IN
COMNECTION WITH ANY WORK OR
PROJECT OF WHICH THEY HAVE BEEN
PREPARED AND DEVELOPED WITHOUT
THE WARTEN CONSERT OF ARCH
DESIGN & CONSTRUCTION, VENAL
CONSTRUCT WITH THESE DRAWNIGS
SHALL CONSTRUCT CONCLISIVE
ENDERICE OF ACCEPTANCE OF THESE
RESTRICTIONS.


CONTRACTOR TO VERIFY A
DIMENSIONS, CONDITIONS, ETC
PERTAINING TO THE WORK AT THE S
BEFORE PROCEEDING WITH WORK.

	A STATE OF THE STA	VS
NO.	ISSUE	BY
2	02.13.19	AM
3	02.20.19	AM

DRAWN BY	
CHECKED BY	ARAM M.
DESIGN BY	ARAM M.
SCALE	
DATE	
JOB NO.	

A-2

F SHEETS

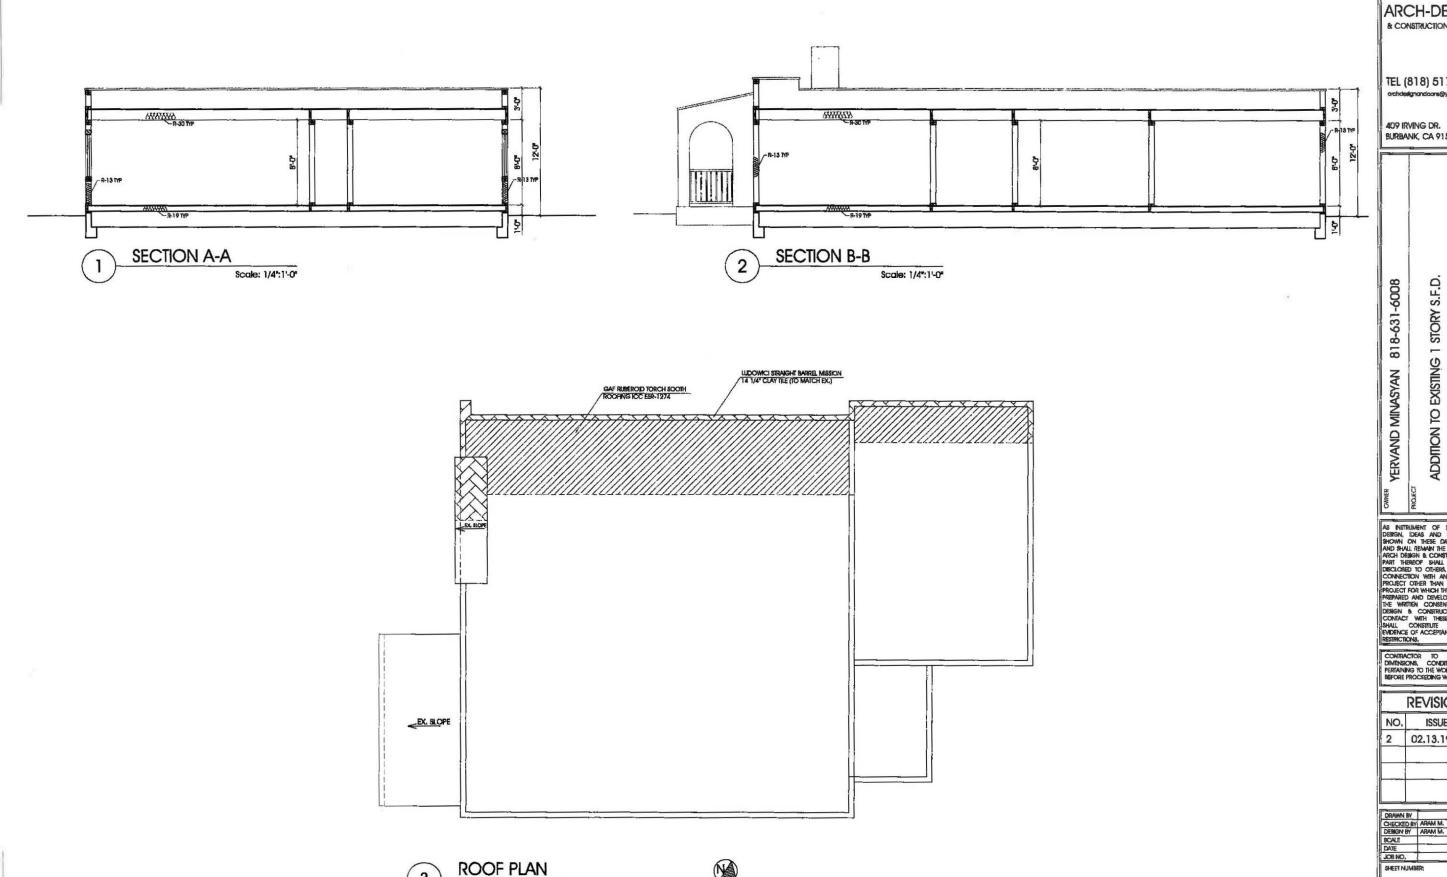

Scale: 1/4":1"-0"

ARCH-DESIGN & CONSTRUCTION CO., INC. TEL (818) 517-5224 BURBANK, CA 91504

> CA 91201 1325 SONORA #"GLENDALE,

AS INSTRUMENT OF SERVICE, ALL DESIGN, IDEAS AND INFORMATION SHOWN ON THESE DRAWNOS ARE AND SHALL REMAIN THE PROPERTY OF ARCH DESIGN IS CONSTITUTION. NO PART THESEOF SHALL BE COPPED, DISCLOSED TO OTH-RES, OR USED IN CONNECTION WITH ANY WORK OR PROJECT OTHER THAN THE SPECTED. OTHER THAN THE SPECTED FROJECT FOR WHICH THEY HAVE BEEN PROJECT FOR WHICH THE PART BEEN AND EXCEPTION. WISHALL CONTACT WITH THESE DRAWNOSS SHALL CONSTITUTE CONCLUSIVE EVORENCE OF ACCEPTANCE OF THESE RESTRICTIONS.

CONTRACTOR TO VERBY ALL DIMENSIONS, CONDITIONS, ETC., PERTAINING TO THE WORK AT THE SITE BEFORE PROCEEDING WITH WORK.

REVISIONS						
NO.	ISSUE	BY				
2_	02.13.19	AM				
	_					

DRAWN BY	
CHECKED BY	ARAM M
DESIGN BY	ARAM M
SCALE	
DATE	
JOB NO.	



PROPOSED SOUTH ELEVATION

Scale: 1/4":1"-0"

15-0

Ş

^

YERVAND MINASYAN 818-631-6008

ADDITION TO EXISTING 1 STORY S.F.D.

1325 SONORA \$1, GLENDALE, CA 91201


AS INSTRUMENT OF SERVICE, ALL
DESIGN, DEAS AND INFORMATION,
SHOWN ON THESE CRAIMINGS ARE
AND SHALL BEHAIN HE PROPERTY OF
ARCH DESIGN IS CONSTITUCTION, NO.
PART INSERCE SHALL BE COPTED,
DECLOSED TO CHIEFES, OR LIETE IN
CONNECTION WITH ARM HER PROPERTY OF
PROJECT FOR WHICH THEY HAVE BEEN
PREPARED AND DEVELOPED WITHOUT
THE WINTER COMMENT OF RICH,
DESIGN IS CONSTITUTION, VISIAL
CONNECT WITH THESE DRAIMINGS.
SHALL CONSTITUTION VISIAL
CONNECT WITH THE ENTRY
PROPERTY WITH THE CONSTITUTION
PROPERTY OF ACCOUNTS
SHALL CONSTITUTION
PROPERTY OF THE PROPERTY OF THESE
RESERVICIONS.

CONTRACTOR TO VERTY ALL.
DIMENSIONS, CONDITIONS, ETC.,
PREVANTES TO THE WORK AT THE SITE
BEFORE PROCEEDING WITH WORK

REVISIONS						
NO.	ISSUE	ВУ				
2	02.13.19	AM				
3	02.20.19	AM				
4	03.25.19	AM				

CHECKED 88	ARAM M.
DESGN BY	M MASSA
SCALE DATE	
JOB NO.	Lance of the second sec

A-4.1

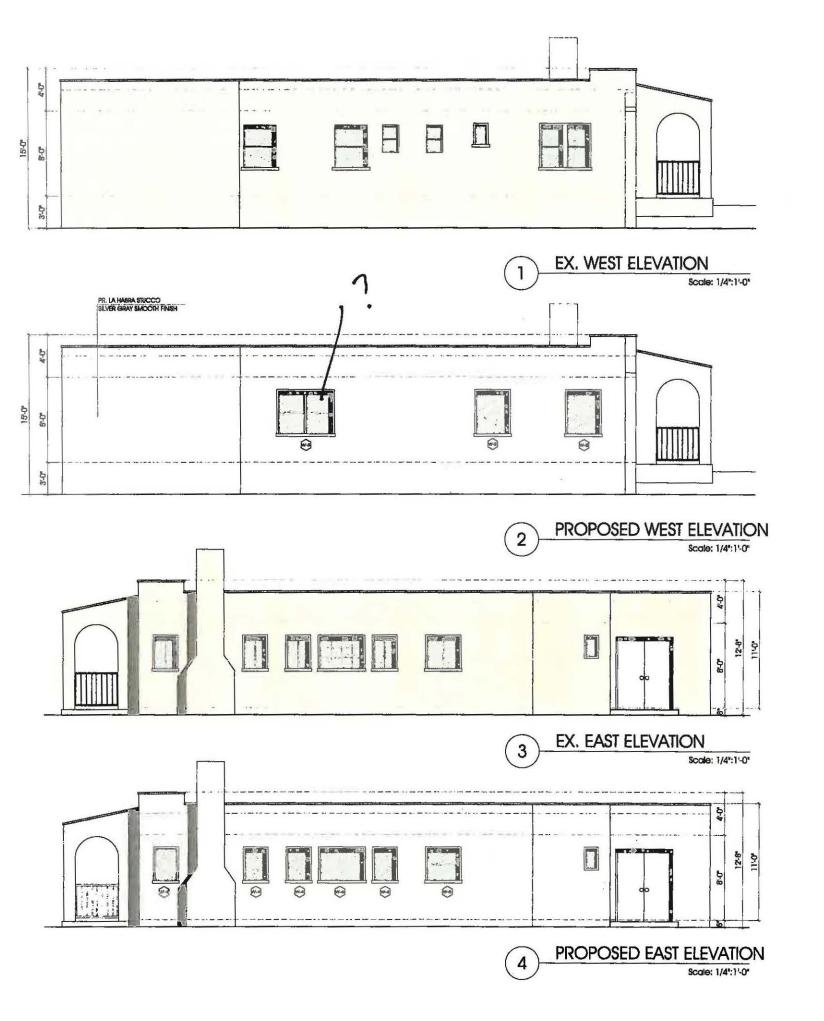

ARCH-DESIGN & CONSTRUCTION CO., INC.

TEL (818) 517-5224

409 IRVING DR. BURBANK, CA 91504

\*\* YERVAND MINASYAN 818-631-6008

\*\*\*ROJECT AND TO EXISTING 1 STORY S.F.D.

\*\*\*LOCATION\*\* TO EXISTING 1 STORY S.F.D.

\*\*\*LOCATION\*\* TO EXISTING 1 STORY S.F.D.

AS ASTRUMENT OF SERMCS, ALL
DESIGN, DEAS AND WFORMATION
NOWN ON THESE DRAWINGS ARE
AND SHALL REMAIN THE PROPERTY OF
ARCH CERSION & CONSTRUCTION, NO
PART THEREOF SHALL SE COPED,
DISCLOSED TO OTHERS, OR USED IN
CONNECTION WITH ANY WORK OR
PROJECT FOR WHICH THEY HAVE SEEN
REPEARED AND DEVELOPED WITHOUT
THE WIGHTEN CONSENT OF ARCH
DESIGN & CONSTRUCTION, WELL,
CONTACT WITH THESE DRAWINGS
SHALL CONSTITUTE CONCLUSIVE
EVIDENCE OF ACCEPTANCE OF THESE
RESTRUCTIONS.

CONTRACTOR TO VERIFY ALL DIMENSIONS, CONDITIONS, ETC., PERMANNING TO THE WORK AT THE SITE BEFORE PROCEEDING WITH WORK.

74	
ISSUE	BY
02.13.19	AM
-	

DRAWN BY
CHECKED BY ARAM M.
DESIGN BY ARAM M.
SCALE
DATE
DATE
JOB NO.
SHEET NUMBER:

NOTE: SEE SHEET A-4.3 FOR WINDOW SCHEDULE

A-4.2





PROPOSED SOUTH ELEVATION Scale: 1/4":1'-0"

O NE	W WIND	OW SCH	EDULE																8
WINDOW NUMBER	QUANTITY	EXISTING WIDTH X HEIGHT	NEW WIDTH X HEIGHT		NEW MATERIAL	VISIBLE FROM STREET?	EXISTING OPERATION	NEW OPERATION	NEW FRAME TYPE	EXTERNAL GRID (SDL)	FXI2IING	BUILD NEW SILL & FRAME?	EXISTING EDGE DETAIL	NEW EDGE DETAIL	BEDROOM EGRESS	ENERGY EFFICIENT	TEMPERED GLASS	FIRE HAZARD ZONE	WINDOW WITHIN 18" OF FLOOR OR 40" OF DOOR
W-1	2	3'-6" X 4'-0"	3'-6" X 4'-0"	VINYL	VINYL	Υ	UNKNOWN	DBL. CASEMENT	BLOCK	N	Υ	N	WOOD	WOOD	N	Y	γ	N	Υ
W-1A	1		3'-6" X 4'-0"	-	VINYL	Υ	-	DBL. CASEMENT	BLOCK	N	-	Y	-	WOOD	Υ	Y	N	N	N
W-1B	1	3'-6"-X 4'-0"	3'-6" X 4'-0"	VINYL	VINYL	Y	UNKNOWN	DBL. CASEMENT	BLOCK	N	Y	N	WOOD	WOOD	Y	Υ	N	N	N
W-2	2		3'-0" X 4'-0"	-	VINYL	Y		CASEMENT	BLOCK	N	-	Y	-	WOOD	Y	Y	N	N	N
W-3	1	-	5'-0" X 4'-0"	-	VINYL	Υ	16	SINGLE HUNG	BLOCK	N	0.5	Y		WOOD	Y	Y	N	N	N
W-4	4	2'-0" X 3'-0"	2'-0" X 3'-0"	VINYL	VINYL	Y	UNKNOWN	CASEMENT	BLOCK	N	Y	N	WOOD	WOOD	N	Y	Y	N	N
W-5	1	3'-0" X 3'-0"	3'-0" X 3'-0"	VINYL	VINYL	Υ	UNKNOWN	SINGLE HUNG	BLOCK	N	Y	N	COOM	WOOD	N	Υ	N	N	N
W-6	1	4'-0" X 3'-0"	4'-0" X 3'-0"	WOOD	VINYL	Υ	FIXED	FIXED	BLOCK	N	Y	N	WOOD	WOOD	N	Y	N	N	N

WINDOW SCHEDULE NOTES:

1. ALL WINDOWS 0.32 MAX U-FACTOR AND 0.25 MAX SHGC

2. FOR WINDOW SECTION DEFAIL FOR ALL WINDOWS SEE DET, 5 ON THIS PAGE

3. NO INTERNAL GRIDS ALLOWED



WINDOW SECTION TYP.

Scale: 1/2":1'-0"

ARCH-DESIGN & CONSTRUCTION CO., INC.

TEL (818) 517-5224

409 IRVING DR, BURBANK, CA 91504

N 818-631-6008	ADDITION TO EXISTING 1 STORY S.F.D.	
YERVAND MINASYAN 818-631-6008	ADDITION TO EXIST	OCATION

AS INSTRUMENT OF SERVICE, ALL DESIGN. IDEAS AND INFORMATION SHOWN ON THESE DRAWINGS ARE AND SHALL REMAIN THE REPORTIY OF ARCH DESIGN & CONSTRUCTION, NO PART HEREOF SHALL BE COPED, DISCLOSED TO OTHERS, OR USED IN CONNECTION WITH ANY WORK OF PROJECT FOR WHICH THEY HAVE BEEN PREPARED AND DEVELOPED WITHOUT THE WRITTEN CONSETT OF ARCH. DESIGN & CONSTRUCTION, VISIAL CONTROL WITH THESE DRAWINGS SHALL CONSTRUCTION.

CONTRACTOR TO VERIFY ALL DAMENSIONS, CONDITIONS, ETC., PERTAINING TO THE WORK AT THE SITE BEFORE PROCEEDING WITH WORK.


REVISIONS					
NO.	ISSUE	BY			
2	02.13.19	AM			
3	02.20.19	AM			
4	03.25.19	AM			

DRAWN BY
CHECKED BY ARAM M,
DESIGN BY ARAM M,
SCALE
DATE
JOB NO,

A-4.3

SHEETS

SHEET NUMBER:

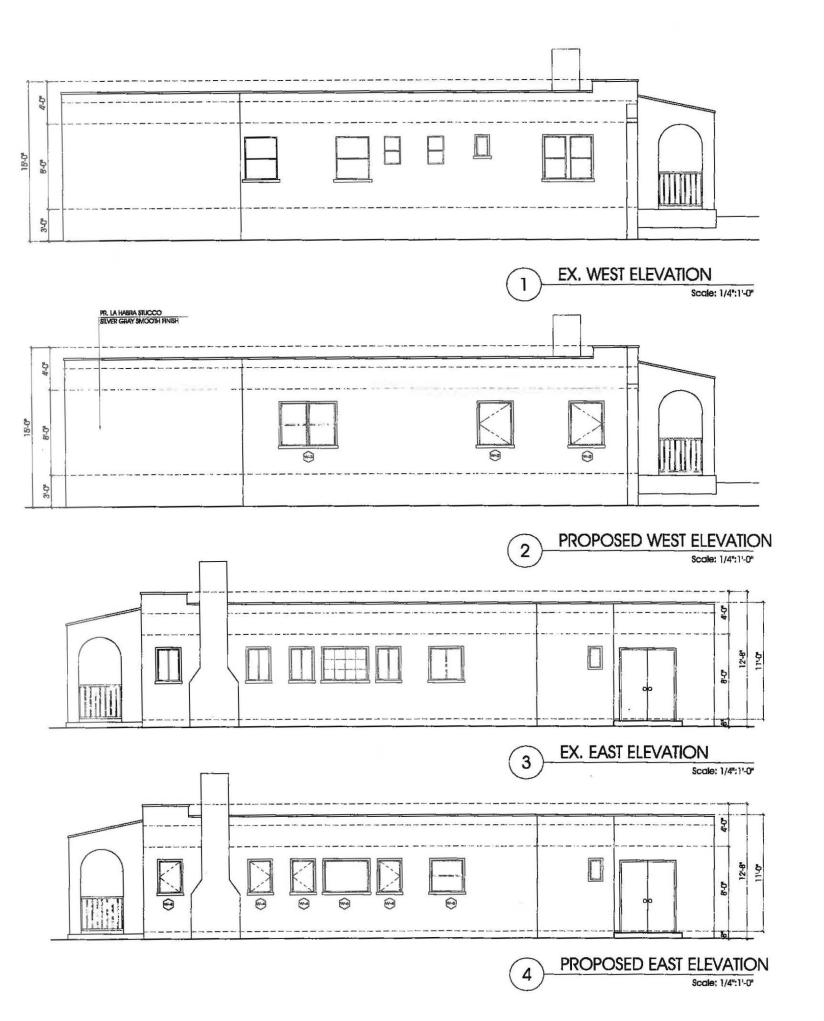

9 9 3	409 KN	ORA ST. D.	TOCIO A CIENDAIE O COLO DA COLO DE COL
-------	--------	------------	--

AS INSTRUMENT OF SERVICE, ALL
DESIGN, DEAS AND INFORMATION
SHOWN ON THESE DRAWINGS ARE
AND SHALL REMAIN THE PROPERTY OF
ARCH DESIGN & COMSTRUCTION, NO
PART THEREOF SHALL BE COPPED,
DISCLOSED TO OTHERS, OR USED IN
CONNECTION WITH ANY WORK OR
PROJECT FOR WHICH THEY HAVE BEEN
RESPACED AND DEVELOPED WITHOUT
THE WRITTEN CONSETT OF ARCH
DESIGN & CONSTRUCTION, VISUAL
CONSTRUCT WITH THESE DRAWINGS
SHALL CONSTRUCT
RESTRICTIONS.

CONTRACTOR TO VERFY ALL DIMENSIONS, CONDITIONS, ETC., PERIANANG TO THE WORK AT THE SITE BEFORE PROCEEDING WITH WORK.

ISSUE	BY
	Di
2.13.19	AM
-	
	2.13.19


DRAWN BY CHECKED BY	ARAM M.	-
DESIGN 8Y	ARAM M.	_
SCALE		
DATE		
JOB NO.		

NOTE; SEE SHEET A-4.3 FOR WINDOW SCHEDULE

A-4.4



NOTE: ALL EXISTING LANDSCAPING TO REMAIN. ( NO CHANGES )

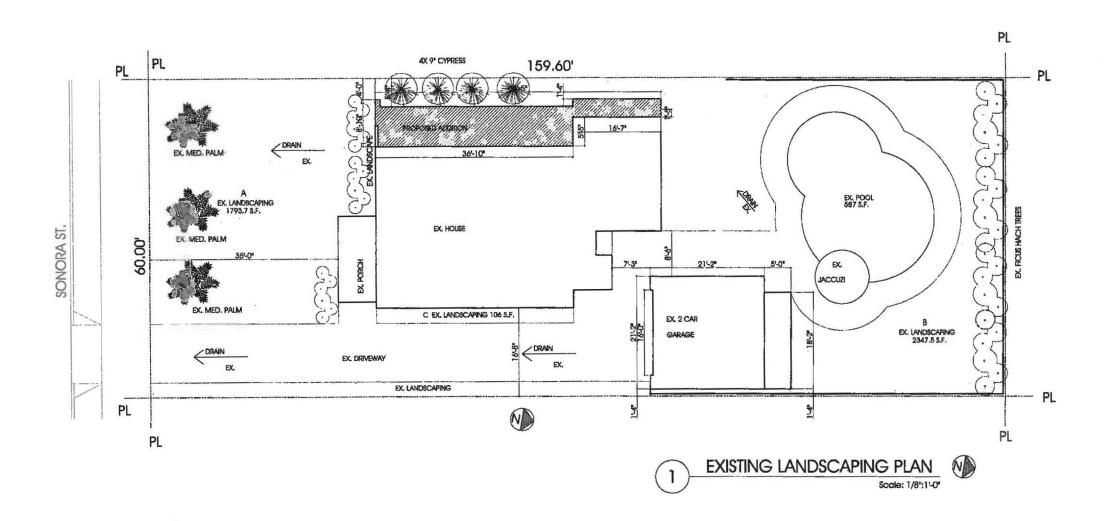

& CONSTRUCTION CO., INC. TEL (818) 517-5224 102 E, PROSPECT AVE., BURBANK, CA 91502 SONOPA M. GLENDALE, CA 91202 PROPOSED ADDITION TO EX. S.F.D. YERVAND MINASYAN

**ARCH-DESIGN** 

AS INSTRUMENT OF SERVICE, ALL
DESIGN, DEAS AND INFORMATION
SHOME ON THESE DRAWNINGS ARE
AND SHALL REMAIN THE PROPERTY OF
ARCH DESIGN & CONSTRUCTION, NO
PRAIT THEREOF SHALL BE COPED,
DISCLOSED TO OTHERS, OR USED IN
CONNECTION WITH ANY WORK OR
PROJECT OTHER THAN THE SPECIFIC. PROJECT FOR WHICH THEY HAVE BEEN PREPARED AND DEVELOPED WITHOUT THE WRITIEN COMERN OF ARCH DESIGN B CONSTITUTION, VISUAL CONTACT WITH THESE DRAWINGS SHALL CONSTITUTE CONCLUSIVE EVIDENCE OF ACCEPTANCE OF THESE REST

NO.	ISSUE	BY
2	02.13.19	AM
_		


DRAWN BY	ANI M.
CHECKED BY	ARAM M.
DESIGN BY	ARAM M.
SCALE	
DATE	
JOB NO.	
SHEET NUMBER	



RENDERED PERSPECTIVE

PROJECT: 1325 SONORA AVE. GLENDALE, CA 91201



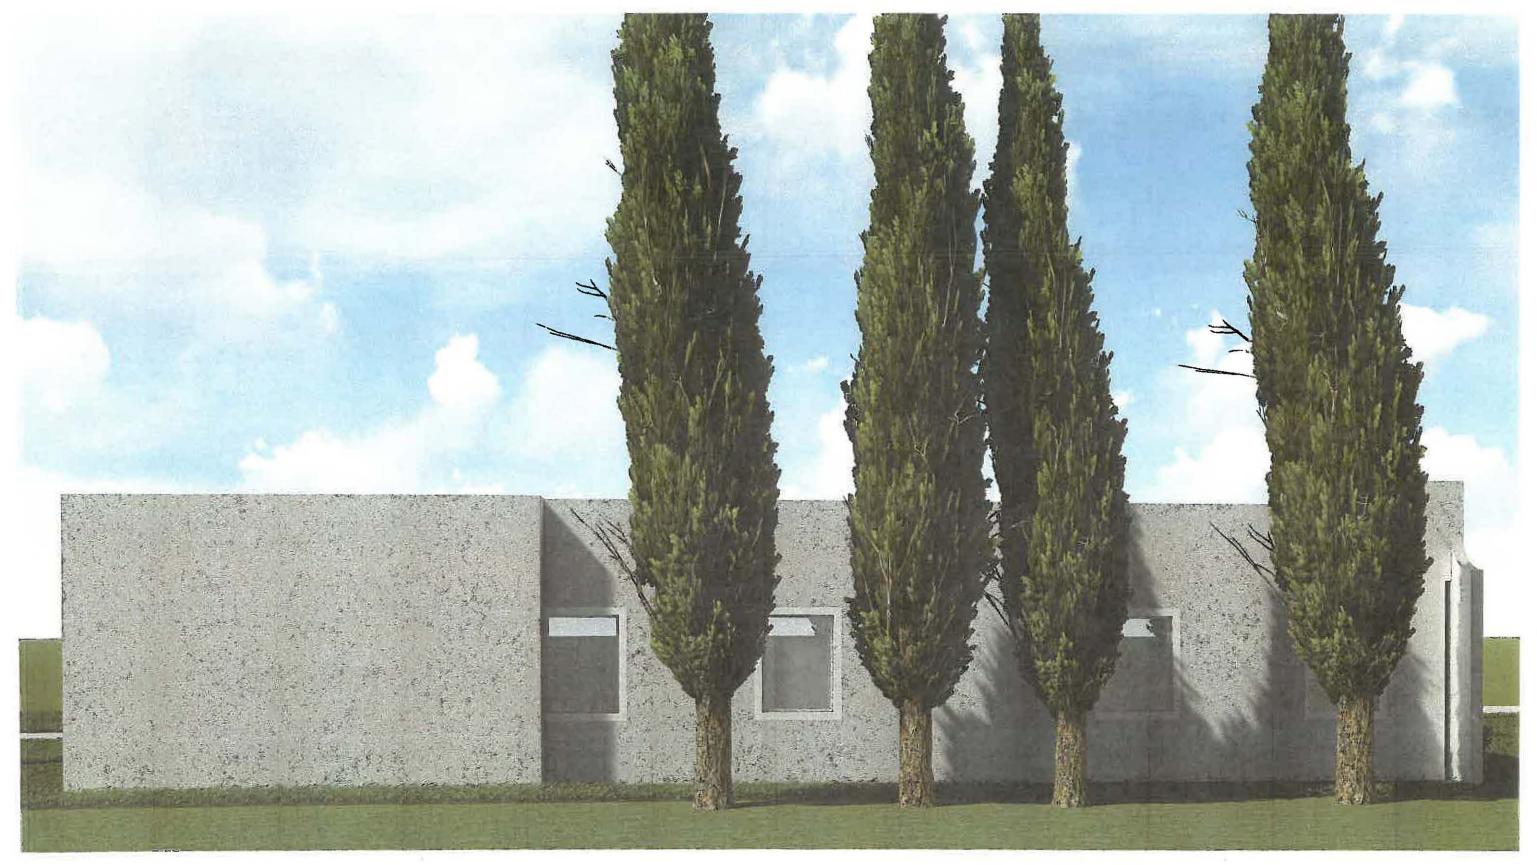

RENDERED PERSPECTIVE

