

CITY OF GLENDALE, CA

DESIGN REVIEW STAFF REPORT - HILLSIDE SINGLE FAMILY

August 4, 2023 3501 Fallenleaf Place

Decision Date Address

Administrative Design Review (ADR) 5660-035-022

Review Type APN

PADR-000576-2022 Sevan Benlian

Case Number Applicant

Deborah Hong, Planning Associate Gegham Petrosyan

Case Planner Owner

Project Summary

The applicant is proposing a 633 square-foot (SF) addition (402 SF on the first-floor, 231 SF on the second-floor) to an existing two-story, 2,498 square-foot single-family residence (originally constructed in 1985) with an attached two-car garage on a 10,653 SFlot located in the R1R (FAR District III) Zone.

Environmental Review

The project is exempt from CEQA review as a Class 1 "Existing Facilities" exemption pursuant to Section 15301 of the State CEQA Guidelines because the proposed addition to the existing structure will not result in an increase of more than 50% of the floor area of the structure before the addition.

Existing Property/Background

Originally developed in 1985, the project site is a 10,653 SF, pie-shaped lot with frontage on two streets: at the end of the cul-de-sac on Fallenleaf Place, and on Dragonfly Street (no site access). The site is currently developed with a 2,498 square-foot, two-story single-family residence with an attached two-car garage, and a swimming pool that will be maintained. Access to the existing garage is from the existing driveway located along Fallenleaf Place that is proposed to remain. The existing development is located on a relatively flat pad lot that slopes down from the rear yard to Dragonfly Street.

Staff Recommendation

Approve

Last Date Reviewed / Decision

First time submittal for final review.

Zone: RIR **FAR District: III**

Although this design review does not convey final zoning approval, the project has been reviewed for consistency with the applicable Codes and no inconsistencies have been identified.

Active/Pending Permits and Approvals

None.

Site Slope and Grading

Less than 50% current average slope and less than 1500 cubic yards of earth movement (cut and/or fill); no additional review required.

Neighborhood Survey

| | Average of Properties within 300 linear feet of subject property | Range of Properties within 300 linear feet of subject property | Subject Property Proposal |
|-------------------|------------------------------------------------------------------|----------------------------------------------------------------------|------------------------------|
| Lot size | 11,162 sq. ft. | 7,590 sq. ft. – 35,231 sq. ft. | 10,653 sq. ft. |
| Setback | 17.7 feet | 11 feet – 31 feet | 18'-10" |
| House size | 2,781 sq. ft. | 2,091 sq. ft. – 3,373 sq. ft. | 3,131 sq. ft. |
| Floor Area Ratio | 0.28 | 0.08 - 0.44 | 0.32 |
| Number of stories | 2 homes are 1-story & 25 homes are 2- stories | 1 to 2-stories | 2-stories |

DESIGN ANALYSIS

Site Planning

Are area

| the following items satisfactory and compatible with the project site and surrounding a? |
|---------------------------------------------------------------------------------------------------------------------------------------------------------------------------------------|
| Building Location ⊠ yes □ n/a □ no |
| If "no" select from below and explain: ☐ Setbacks of buildings on site ☐ Prevailing setbacks on the street ☐ Building and decks follow topography ☐ Alteration of landform minimized |
| Yards and Usable Open Space □ yes 図 n/a □ no |
| If "no" select from below and explain: □ Avoid altering landform to create flat yards □ Outdoor areas integrated into open space |

| ☐ Use of retaining walls minimized ☐ Provide landscaping to reduce visual impact of retaining walls ☐ Decorative material used for retaining walls to blend into landscape and/or complement the building design |
|--------------------------------------------------------------------------------------------------------------------------------------------------------------------------------------------------------------------------------------------------------|
| Garage Location and Driveway □ yes ☑ n/a □ no |
| If "no" select from below and explain: ☐ Consistent with predominant pattern on street ☐ Compatible with primary structure ☐ Permeable paving material ☐ Decorative paving |
| Landscape Design □ yes ⊠ n/a □ no |
| If "no" select from below and explain: ☐ Complementary to building design and surrounding site ☐ Maintains existing trees when possible ☐ Maximizes permeable surfaces ☐ Appropriately sized and located |
| Walls and Fences □ yes ⊠ n/a □ no |
| If "no" select from below and explain: ☐ Appropriate style/color/material ☐ Perimeter walls treated at both sides ☐ Retaining walls minimized ☐ Appropriately sized and located ☐ Stormwater runoff minimized |

Determination of Compatibility: Site Planning

The proposed site planning is appropriate, as modified by any proposed conditions, to the site and its surroundings for the following reasons:

- Overall, the site planning is appropriate and remains relatively unchanged with the 633 SF addition located behind the existing attached garage on the existing flat pad.
- At the first floor, the addition is angled and will run parallel with the easterly interior property line.
- There is no prevailing street-front setback in the immediate neighborhood and no changes are proposed to the existing 18'-10" street-front setback.
- No other site changes are proposed and the existing landscaping and swimming pool will be maintained.

Massing and Scale

Are the following items satisfactory and compatible with the project site and surrounding area?

| Building Relates to its Surrounding Context \boxtimes yes $\ \square$ n/a $\ \square$ no |
|-----------------------------------------------------------------------------------------------------------------------------------------------------------------------------------------------------------------------------------|
| If "no" select from below and explain: ☐ Appropriate proportions and transitions ☐ Impact of larger building minimized |
| Building Relates to Existing Topography □ yes ⊠ n/a □ no |
| If "no" select from below and explain: ☐ Form and profile follow topography ☐ Alteration of existing land form minimized ☐ Retaining walls terrace with slope |
| Consistent Architectural Concept ⊠ yes □ n/a □ no |
| If "no" select from below and explain: ☐ Concept governs massing and height |
| Scale and Proportion ⊠ yes □ n/a □ no |
| If "no" select from below and explain: ☐ Scale and proportion fit context ☐ Articulation avoids overbearing forms ☐ Appropriate solid/void relationships ☐ Entry and major features well located ☐ Avoids sense of monumentality |
| Roof Forms ⊠ yes □ n/a □ no |
| If "no" select from below and explain: ☐ Roof reinforces design concept ☐ Configuration appropriate to context |

Determination of Compatibility: Mass and Scale

The proposed massing and scale are appropriate, as modified by any proposed conditions, to the site and its surroundings for the following reasons:

- Overall, the mass, height, proportions, and architectural concept of the project are consistent with the existing residence and proposed style change.
- The project's mass and scale is appropriate with the first-floor addition setback from the street and behind the existing attached garage, and the second floor expansion appropriately stepping back from the floor below on all sides.

- The neighborhood pattern features predominantly two- story single-family residences, and the applicant's proposal will be consistent with the surrounding development because it is an existing two-story house with the overall 27'-6" height being maintained.
- The existing single-family residence features a hipped roof design at the first floor, and a gable-roof design at the second floor. The proposal will match these existing conditions with the first-floor addition featuring a hipped roof design, and a gable-roof design at the second floor. The proposed 8:12 roof pitch is also consistent with the existing roof.

Design and Detailing

Are the following items satisfactory and compatible with the project site and surrounding area?

| Overall Design and Detailing ☑ yes ☐ n/a ☐ no If "no" select from below and explain: ☐ Consistent architectural concept ☐ Proportions appropriate to project and surrounding neighborhood ☐ Appropriate solid/void relationships |
|------------------------------------------------------------------------------------------------------------------------------------------------------------------------------------------------------------------------------------|
| Entryway □ yes ⊠ n/a □ no If "no" select from below and explain: |
| ☐ Well integrated into design ☐ Avoids sense of monumentality ☐ Design provides appropriate focal point ☐ Doors appropriate to design |
| Windows ☑ yes ☐ n/a ☐ no If "no" select from below and explain: ☐ Appropriate to overall design ☐ Placement appropriate to style ☐ Recessed in wall, when appropriate |
| Privacy ⊠ yes □ n/a □ no |
| If "no" select from below and explain: □ Consideration of views from "public" rooms and balconies/decks □ Avoid windows facing adjacent windows |
| Finish Materials and Color ⊠ ves □ n/a □ no |

| If "no" select from below and explain: |
|--------------------------------------------------------------------------------|
| ☐ Textures and colors reinforce design |
| ☐ High-quality, especially facing the street |
| ☐ Respect articulation and façade hierarchy |
| ☐ Wrap corners and terminate appropriately |
| ☐ Natural colors appropriate to hillside area |
| Paving Materials |
| □ yes ⊠ n/a □ no |
| If "no" select from below and explain: |
| ☐ Decorative material at entries/driveways |
| ☐ Permeable paving when possible |
| ☐ Material and color related to design |
| Lighting, Equipment, Trash, and Drainage □ yes ⊠ n/a □ no |
| If "no" select from below and explain: |
| ☐ Light fixtures appropriately located/avoid spillover and over-lit facades |
| ☐ Light fixture design appropriate to project |
| ☐ Equipment screened and well located |
| ☐ Trash storage out of public view |
| ☐ Downspouts appropriately located |
| · · · · · · · · · · · · · · · · · · · |
| ☐ Vents, utility connections integrated with design, avoid primary facades |
| Ancillary Structures |
| |
| Ancillary Structures ☐ yes ☒ n/a ☐ no If "no" select from below and explain: |
| Ancillary Structures □ yes ⊠ n/a □ no |

Determination of Compatibility: Design and Detailing

The proposed design and detailing are appropriate, as modified by any proposed conditions, to the site and its surroundings for the following reasons:

- Overall, the design and detailing is compatible with the existing traditional style of the house through the use of architectural treatments, materials, windows, and colors.
- The new windows are fiberglass, with a combination of sliding and casement operations to match the existing windows that will be maintained. The nail-on frame type and edge detail will match the existing conditions.
- At the rear a 164 SF uncovered balcony is proposed with access from the existing master bedroom. This new balcony is centered on the second-floor rear façade and is not anticipated to have any privacy impacts with the immediate neighbors.
- The addition will feature an S-tile clay roof and stucco siding to match the existing residence, and the new rear balcony will feature a glass railing.

Recommendation / Draft Record of Decision


Based on the above analysis, staff recommends **Approval.** This determination is based on the implementation of the following recommended conditions:

Conditions

None

Attachments

- 1. Reduced Plans
- 2. Photos of Existing Property
- 3. Location Map
- 4. Neighborhood Survey

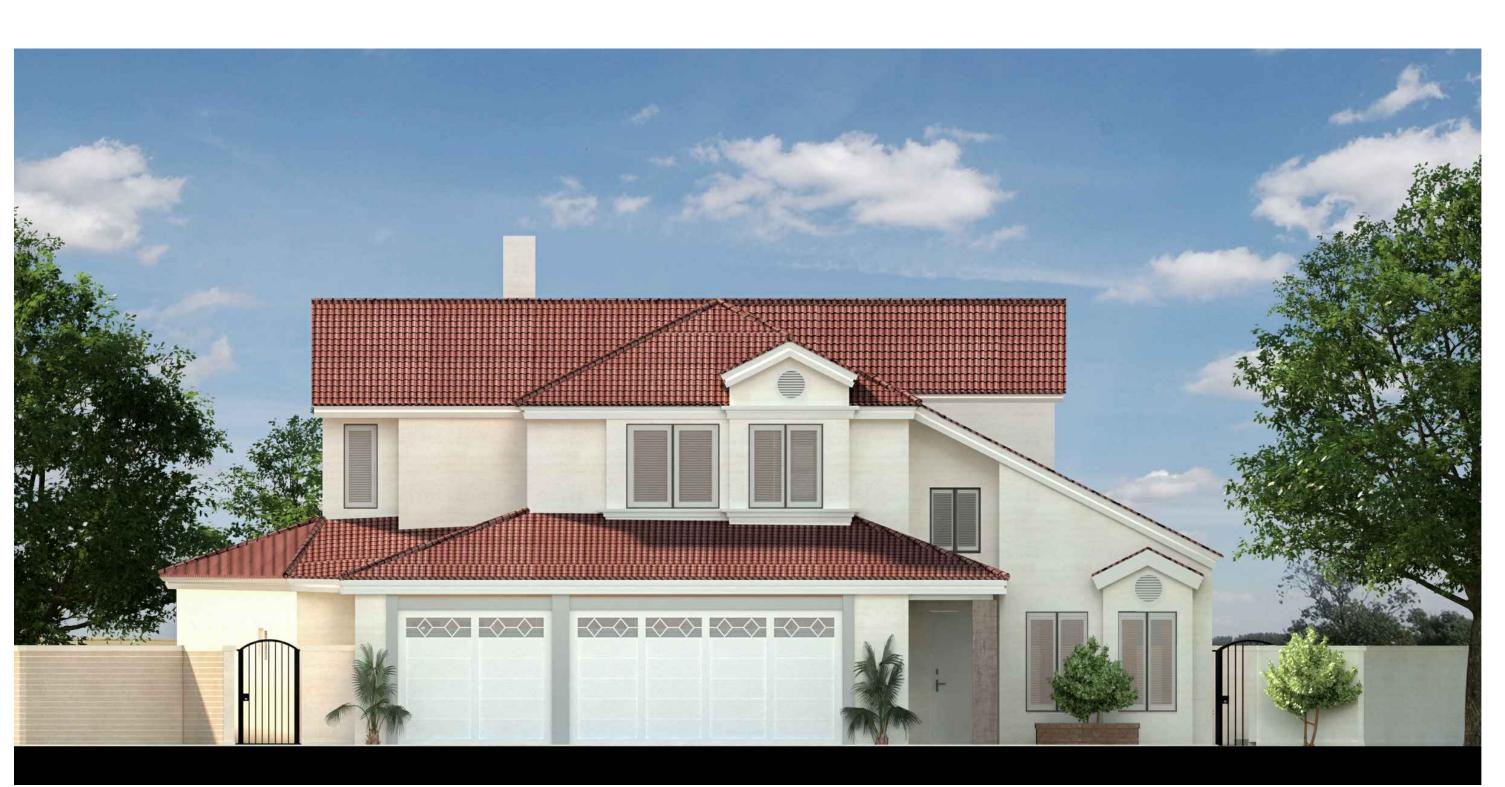

FRONT VIEW



FRONT / SIDE VIEW (EAST CORNER)



REAR VIEW



REAR / SIDE VIEW (SOUTH CORNER)

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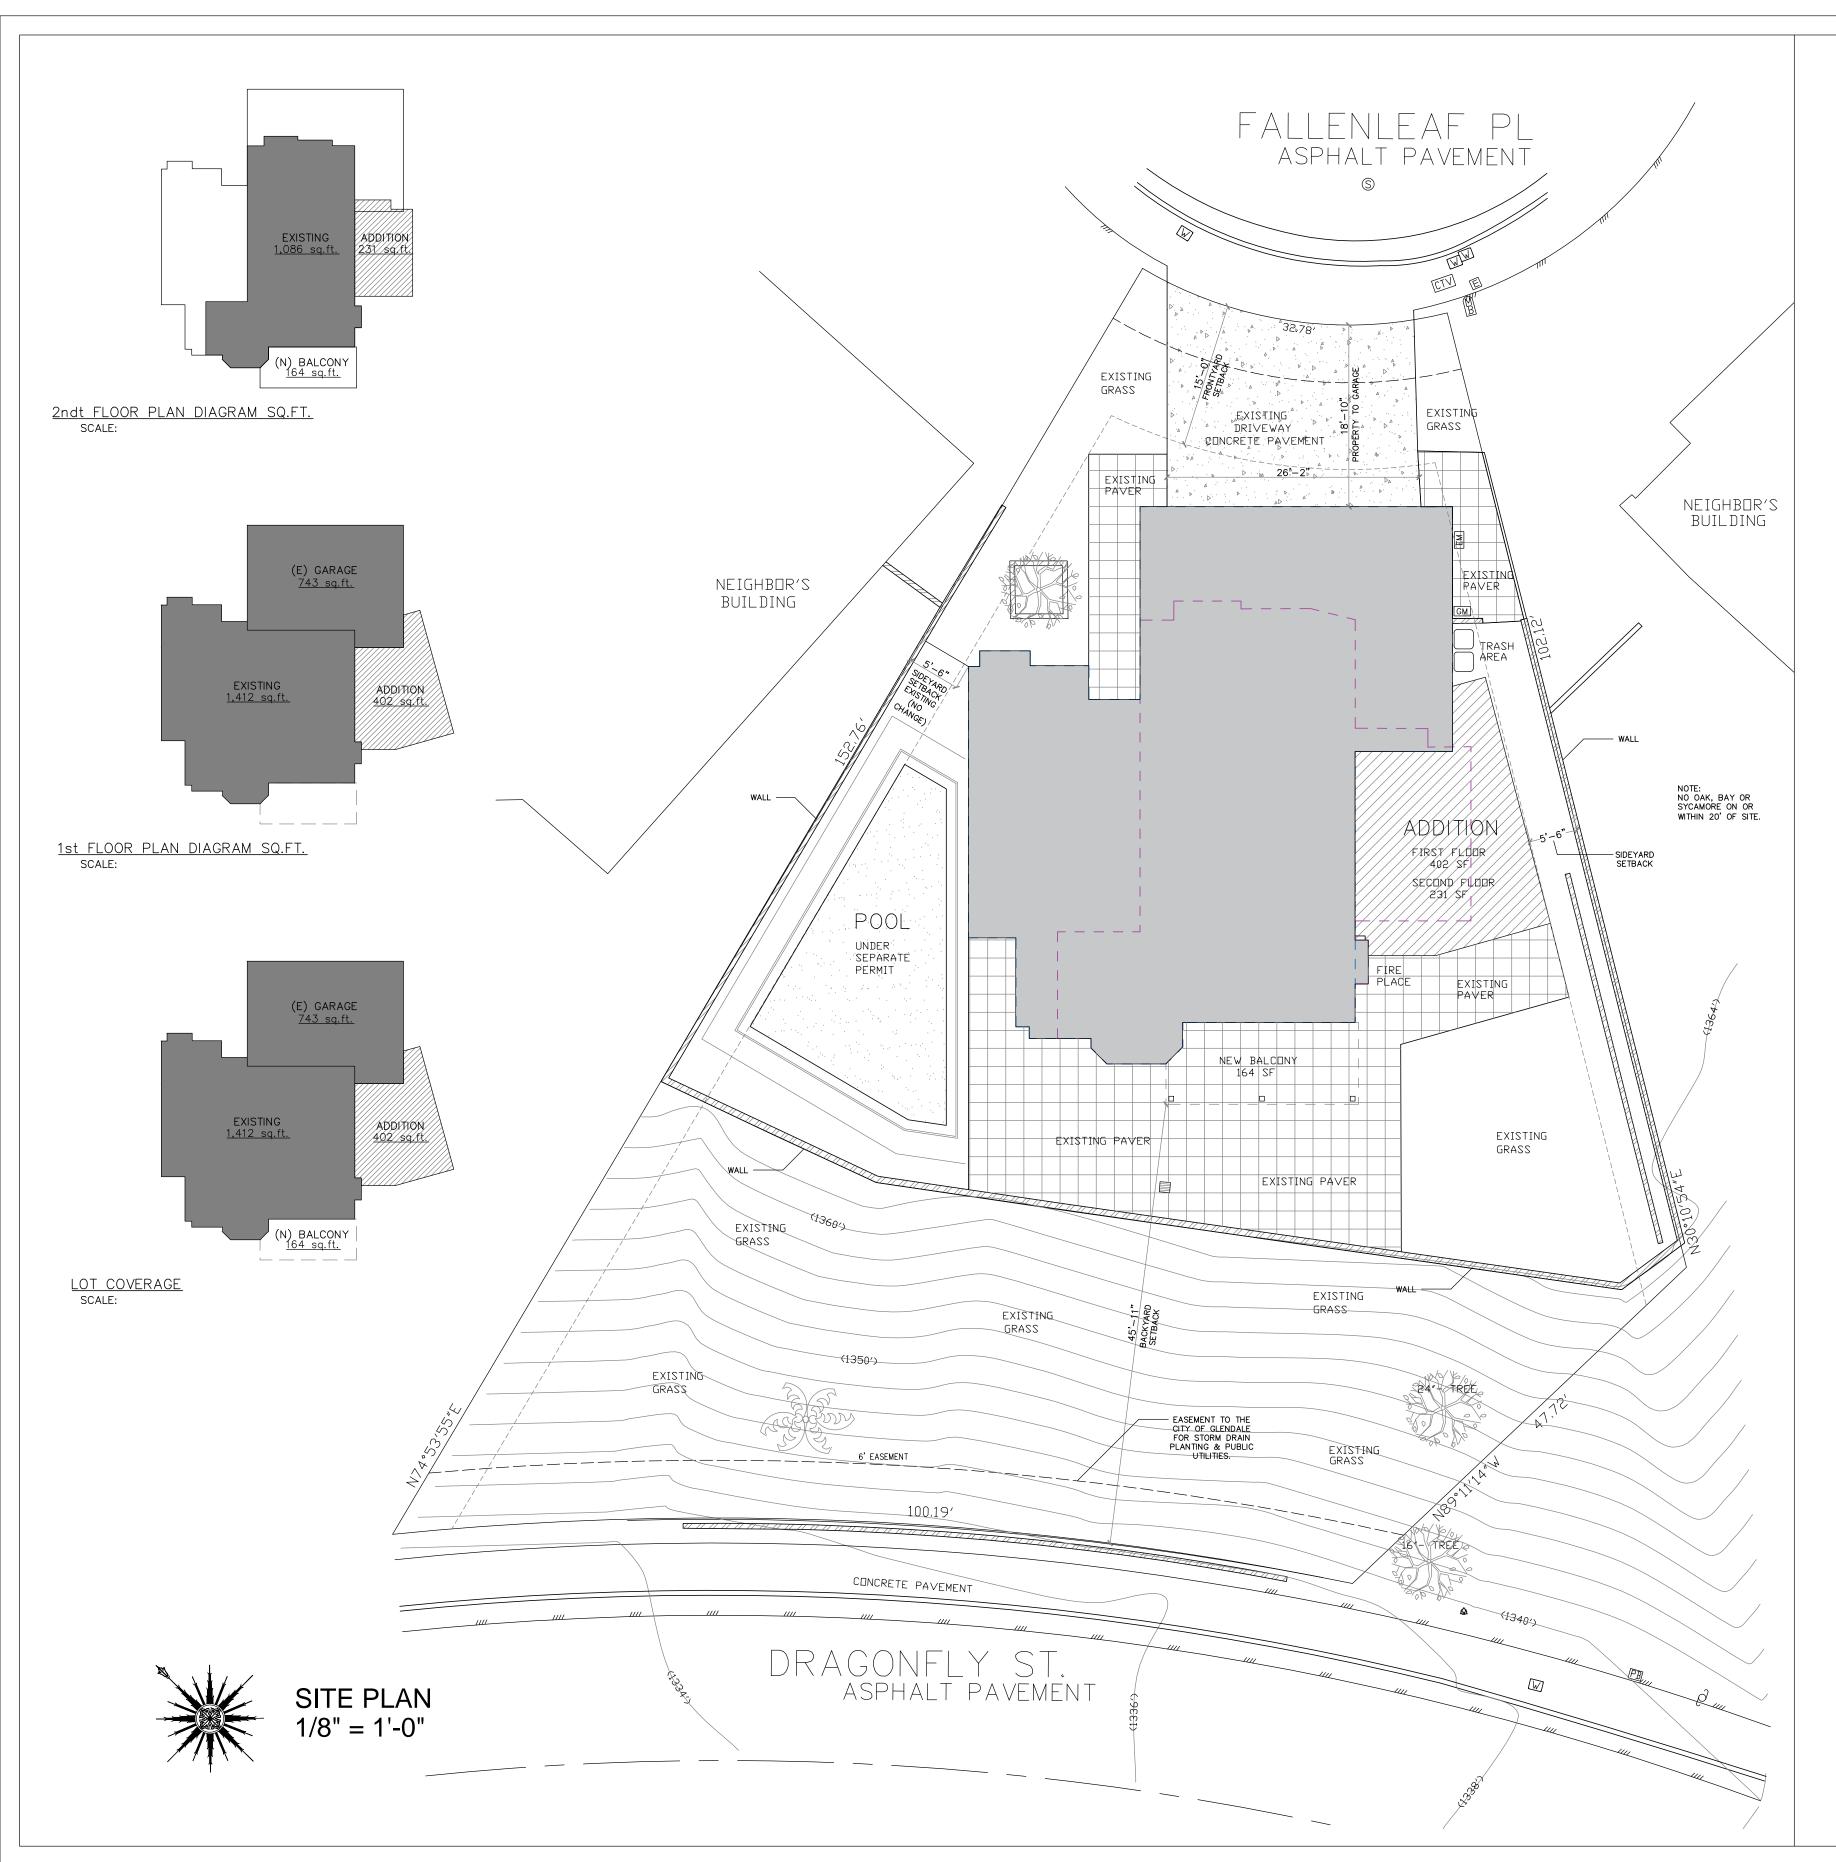
FALLENLEAF





PROJECT INFO
BER:

| PROJECT INFO | |
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| JOB NUMBER: | |
| DATE DRAWN: | 4/29/23 |
| DRAWN BY: | F.P. |
| CHECKED BY: | S.B. |
| SCALE: | |
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| ZONING DESIGNATION: | R1R III RESTRICTED RESIDENTIAL FAR III |
|-------------------------------------------|---------------------------------------------------------------------------------------------------------------------------------------------------|
| OCCUPANCY: | R3 (HOUSE) / U (GARAGE) |
| CONSTRUCTION TYPE: | TYPE-VB |
| FIRE SPRINKLERED: | YES, NFPA 13D |
| LOT SIZE: | 10,653 SF |
| EXISTING HOUSE: | 2,498 SF |
| NEW HOUSE: | 3,131 SF |
| EXISTING GARAGE: | 743 SF |
| ALLOWABLE FAR CACULATIONS: | 45% X 10,000 = 4,500 10% X 653 = 65.3 4,565.3 SF MAX. ALLOWED FAI |
| FAR CALCULATIONS BREAKDOWN: | 1ST FLR = (E) 1,412 + (N) 402 = 1,814 2ND FLR = (E) 1,086 + (N) 231 = 1,311 GARAGE = 743 SF (500 SF EXEMP TOTAL = 3,374SF |
| LOT COVERAGE CACULATIONS BREAKDOWN: | 1ST FLOOR = 1,814 SF GARAGE = 743 SF BALCONY/PATIO = 164 SF TOTAL= 2,721 SF |
| LOT COVERAGE CACULATIONS: | 2,721 SF TOTAL LOT COVERAGE 10,676 SF LOT AREA = 25% < 40% ALLOWED |
| LANDSCAPING CACULATIONS: | LOT SIZE: 10,676 SF TOTAL LOT COVERAGE = 2,721 S DRIVEWAY = 520 SF HARDSCAPE = 1,198 SF TOTAL LANDSCAPE = 6,237 SF 58% OF LOT SIZE > 40% LOT SIZE |
| NUMBER OF STORIES: | 2 |
| BUILDING HEIGHT: | 27'-6" |
| HIGH FIRE ZONE: | YES |
| HILLSIDE ZONE: | YES |
| METHANE ZONE: | NO |
| LIQUEFACTION: | NO |


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| E ZONE: | YES | | |
| NE ZONE: | NO | | |
| ACTION: | NO | | |
| | | | |
| LEGAL | DESCRIPTION | | |
| SS: | 3501 FALLENLEAF PL. GLENDALE CA 91206 | | |
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| | 5660-035-022 | | |
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| SHEET INDEX |
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| A-5 - SECOND FLOOR PLAN |
| A-6 - ROOF PLAN |
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|----------------------------------------------------------------------------------------------------------------------------------|------|----|------|
| 2-STORY ADDITION (633 SF) TO AN EXISTING 2-STORY SFDNEW OFFICE, BEDROOM, BATHROOMS (TOTAL NEW HABITABLE 633 SF) & BALCONY 164 SF | | | |

ARCHITECTURAL DESIGNER: SEVAN BENLIAN SEVANBENLIAN@GMAIL.COM (818) 237-0295

<u>APPLICABLE CODES:</u>
2019 CBC, 2019 CRC, 2019 CMC, 2019 CEC, 2019 CPC, 2019 CFC, 2019 CAL GREEN & 2020 GB & SC



| | | <u> </u> | SS SS |
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COVER
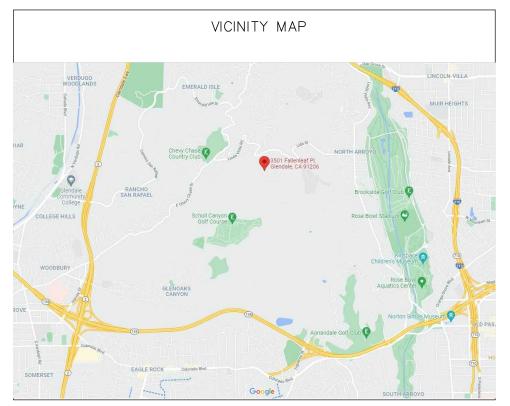
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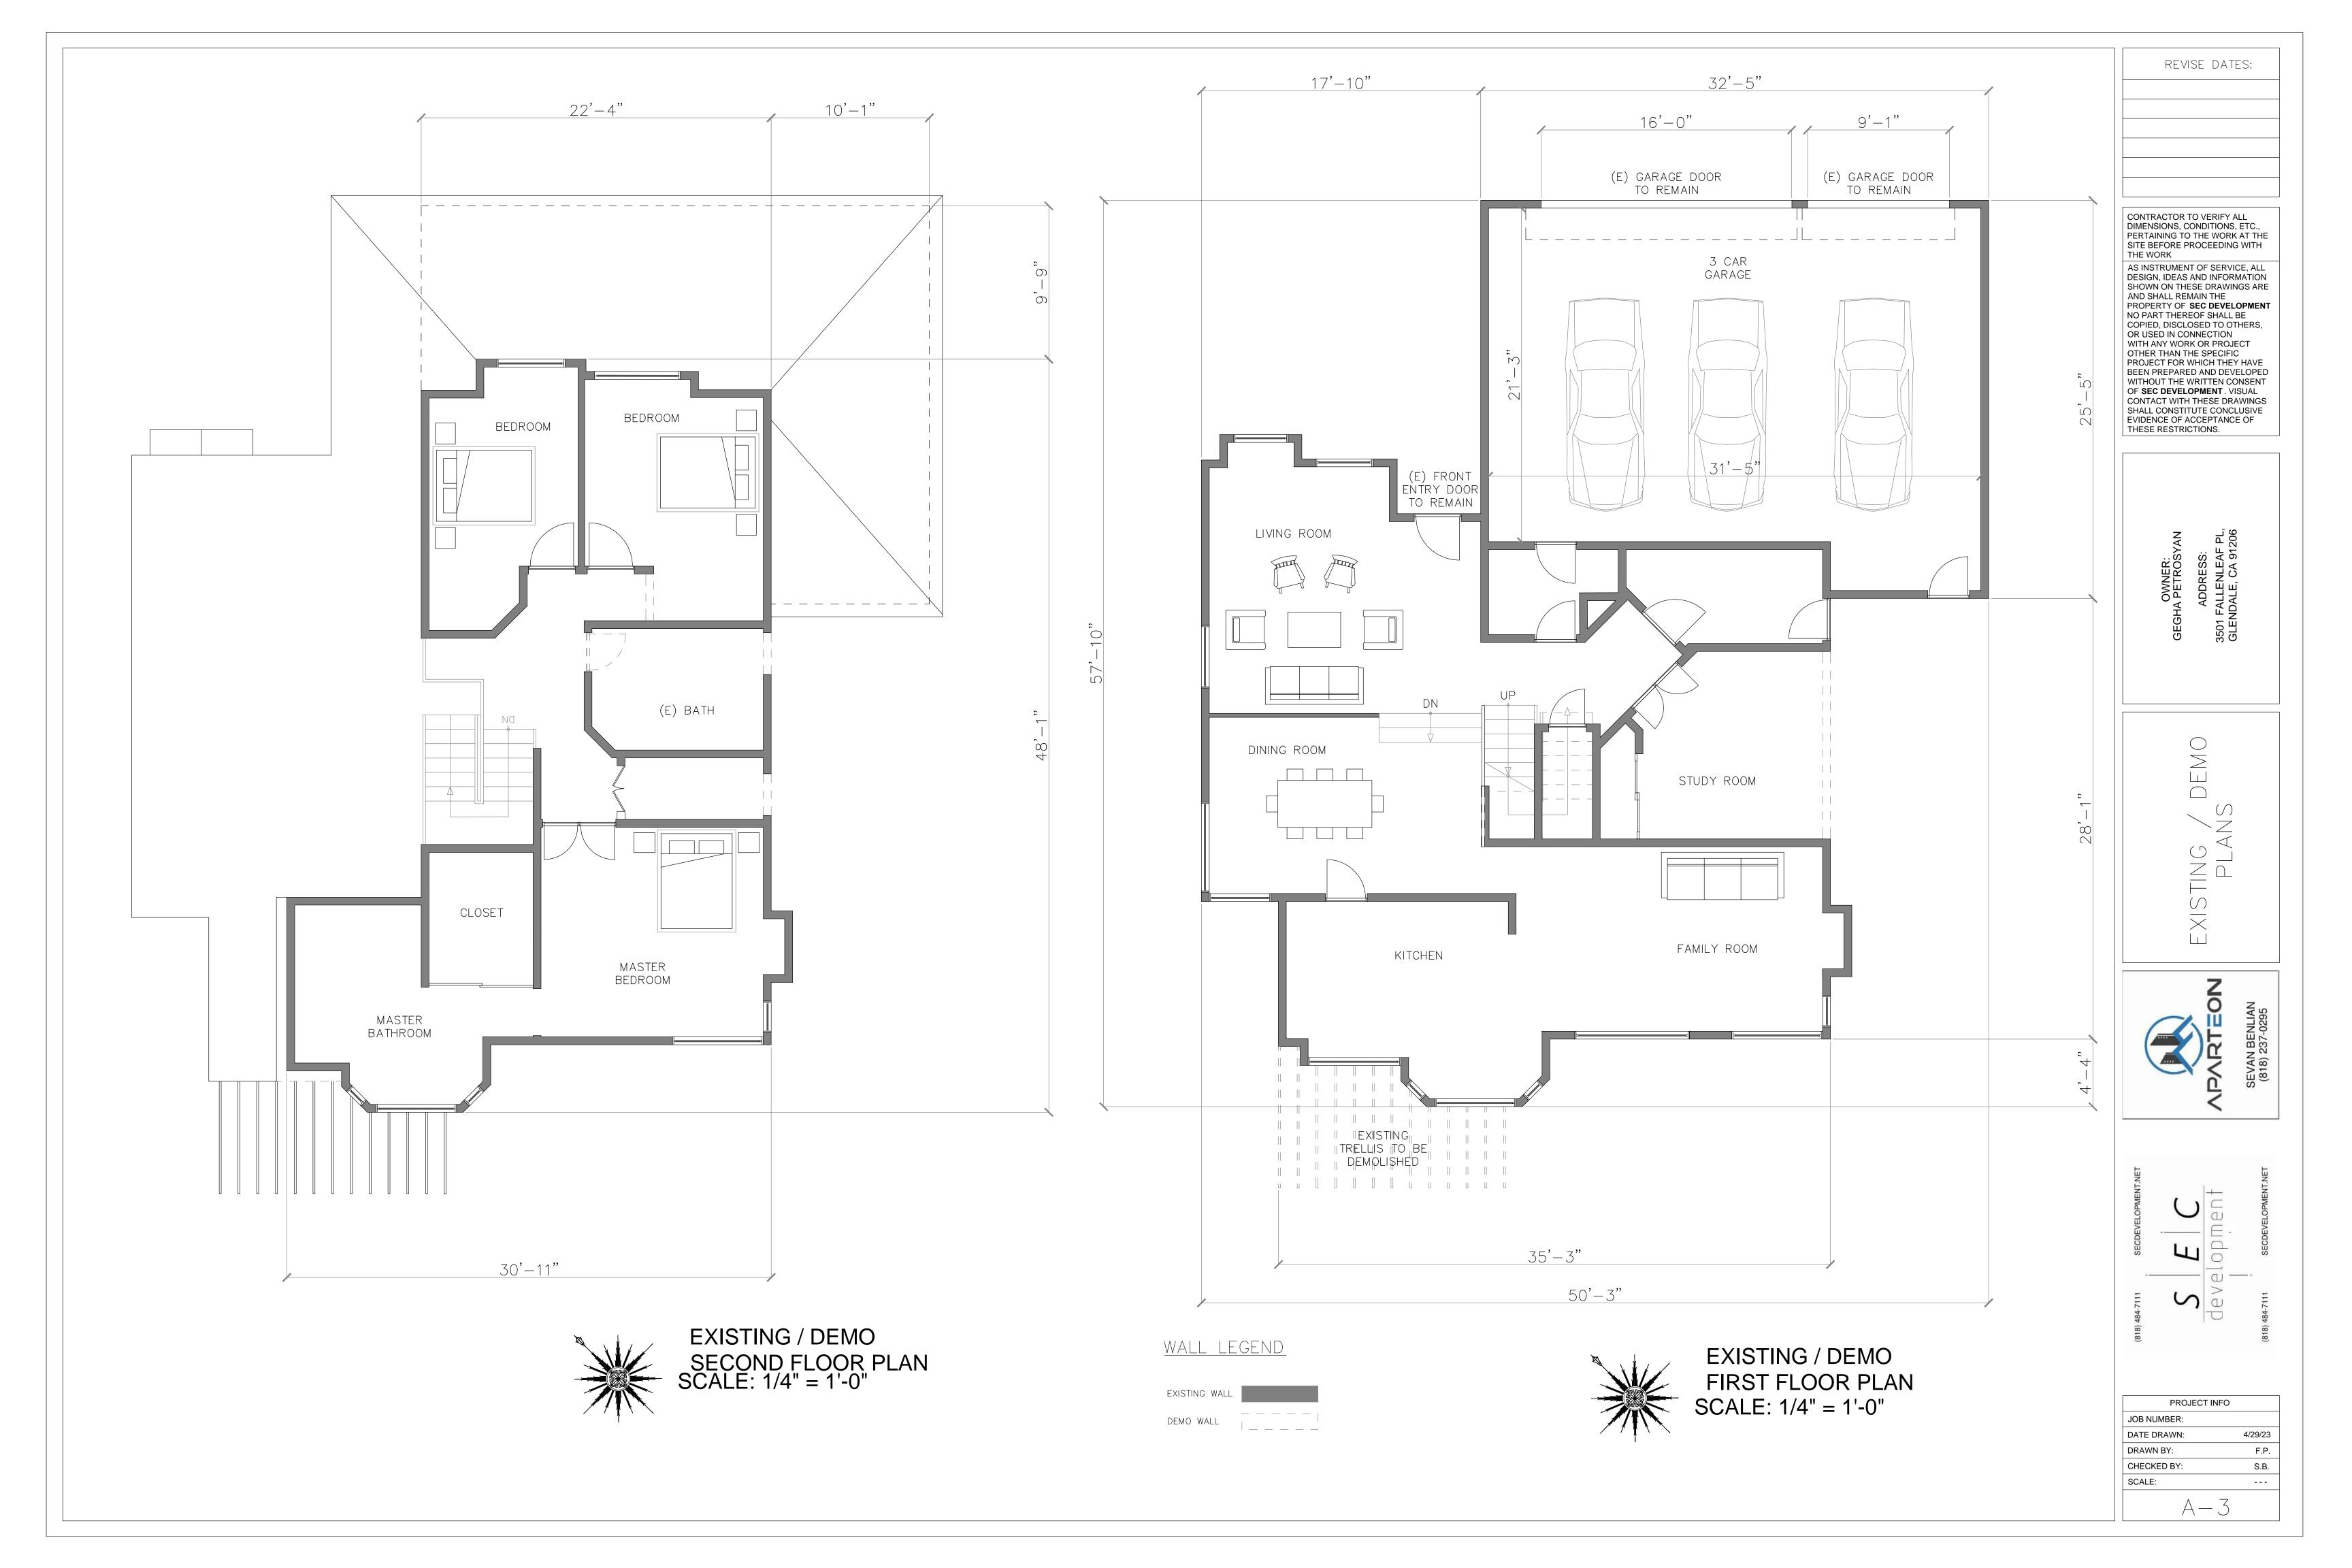
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| JOB NUMBER: | |
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| DRAWN BY: | F.P. |
| CHECKED BY: | S.B. |
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| A-2 | |


A-12 - FLASHING & SECURITY DETAILS

A-13 - GREEN FORMS

A-14 - GREEN FORMS

A-15 - SPECIFICATIONS



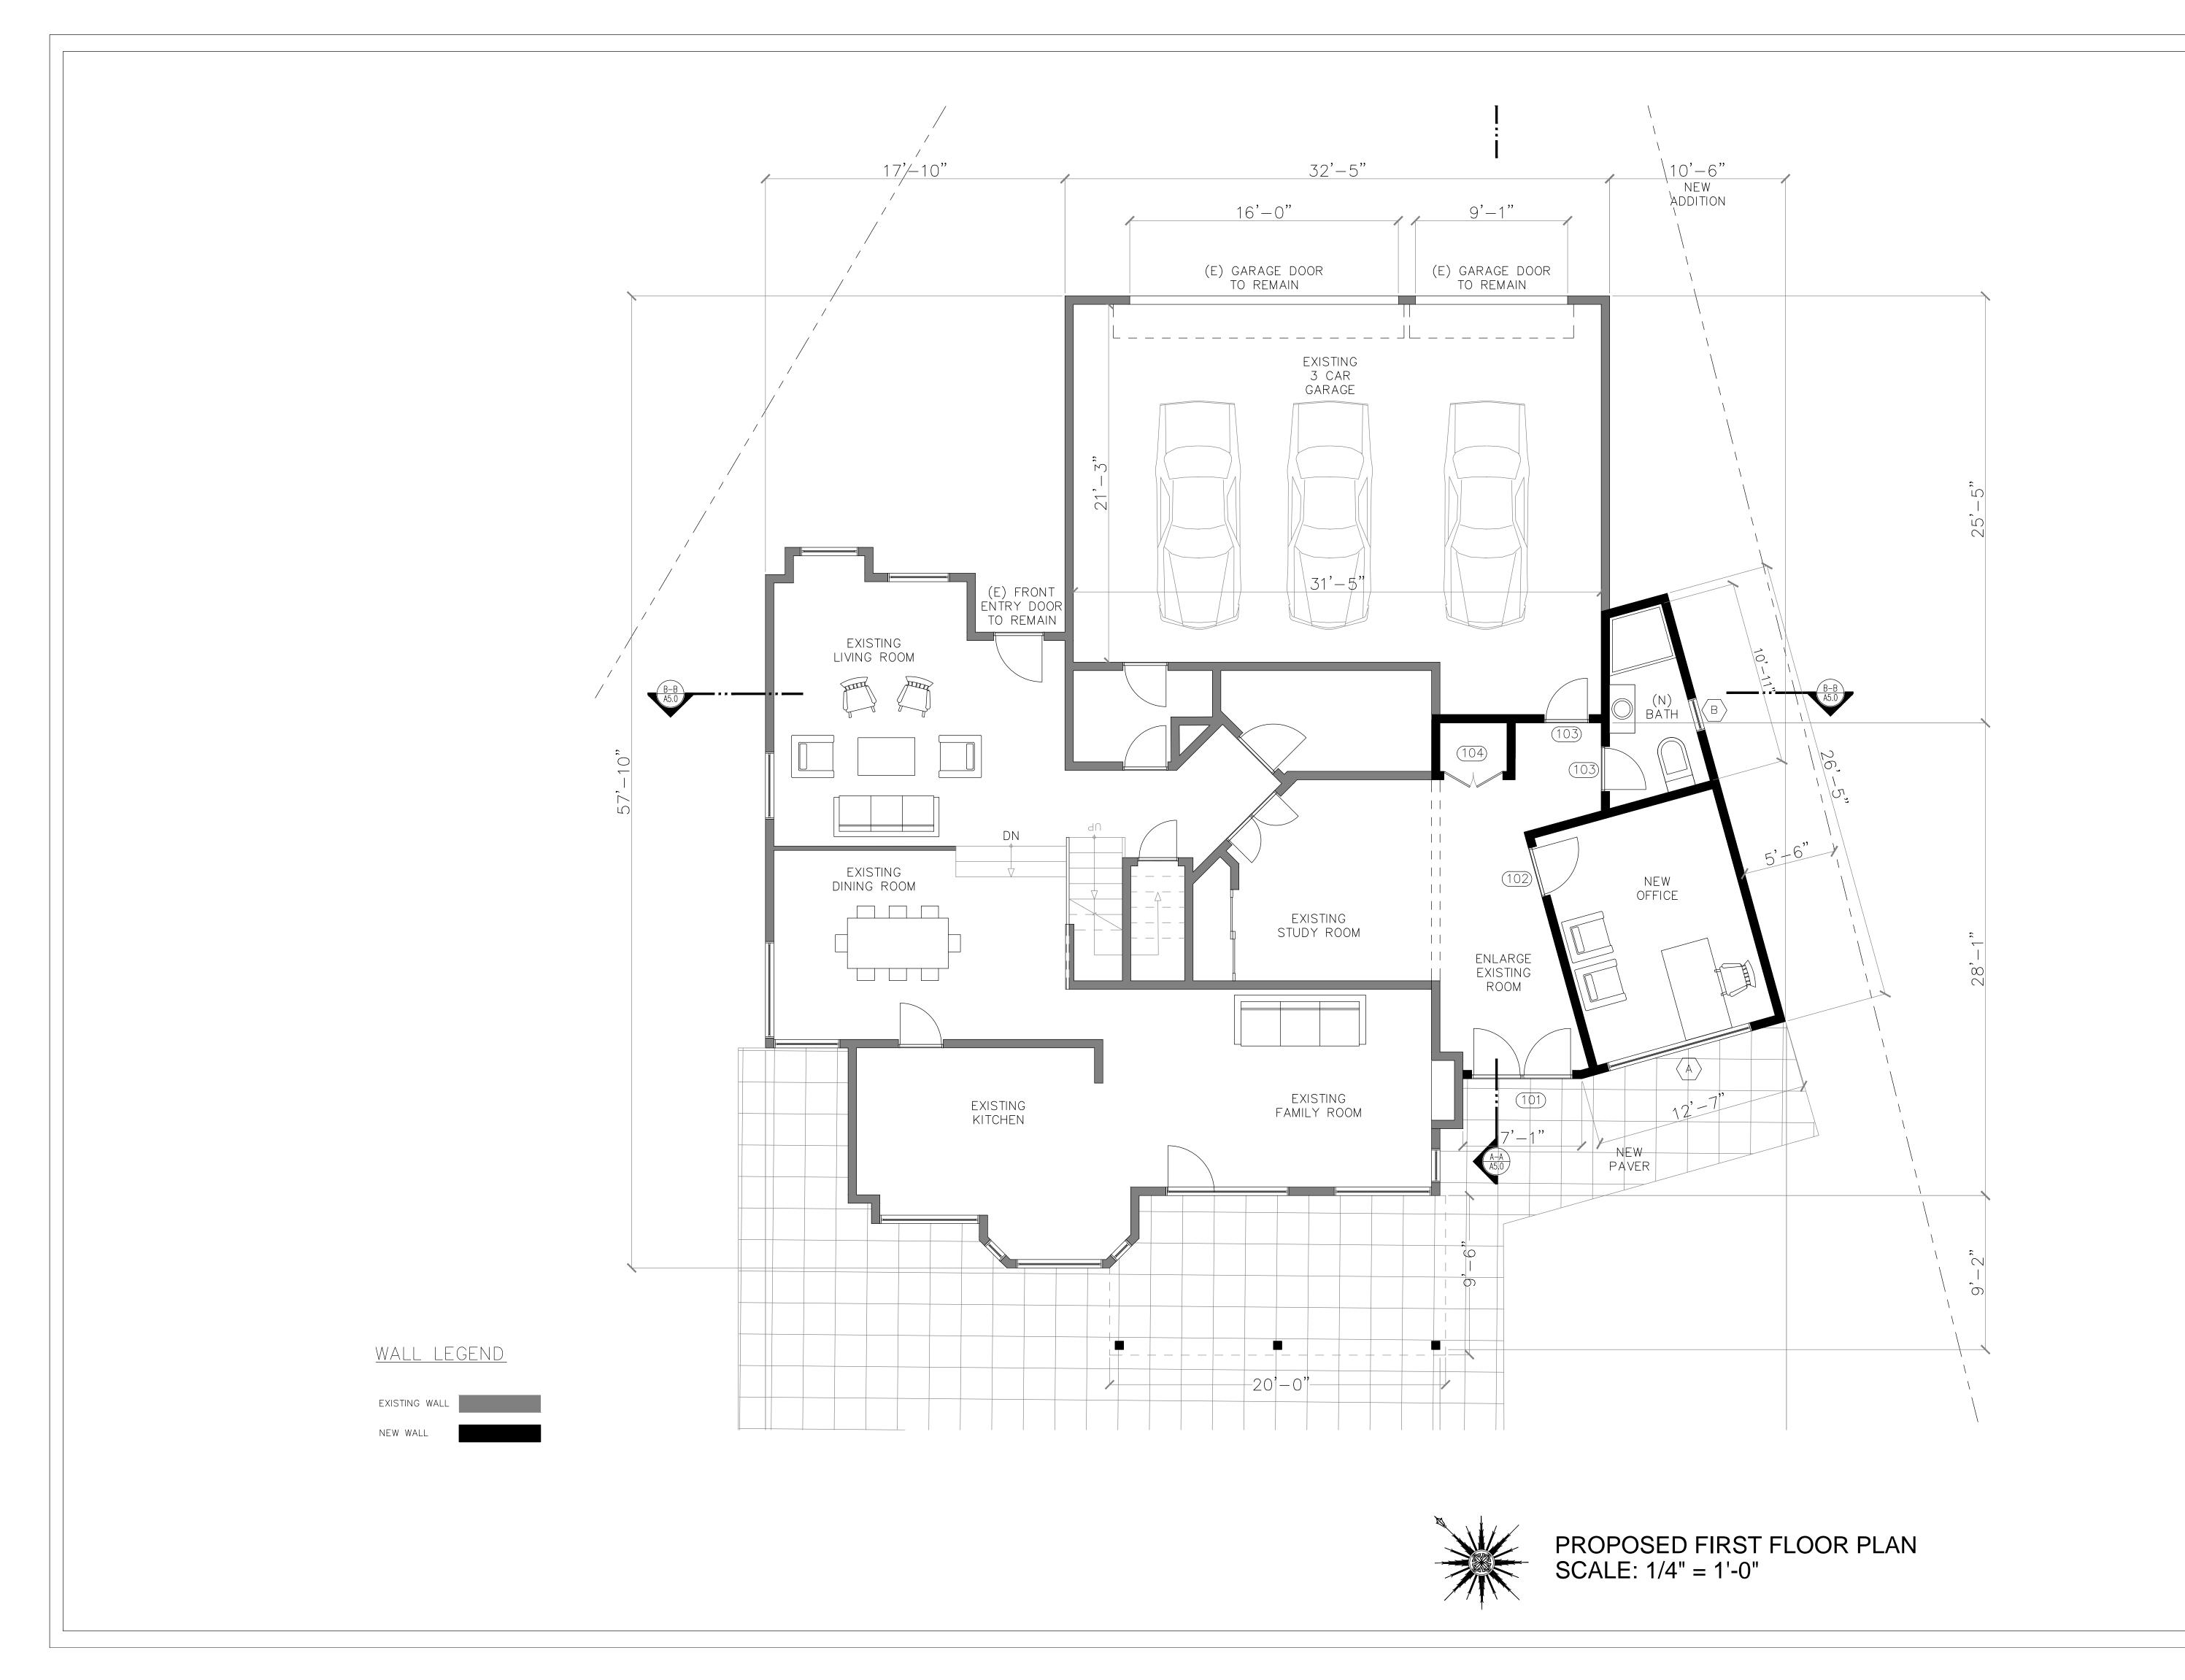

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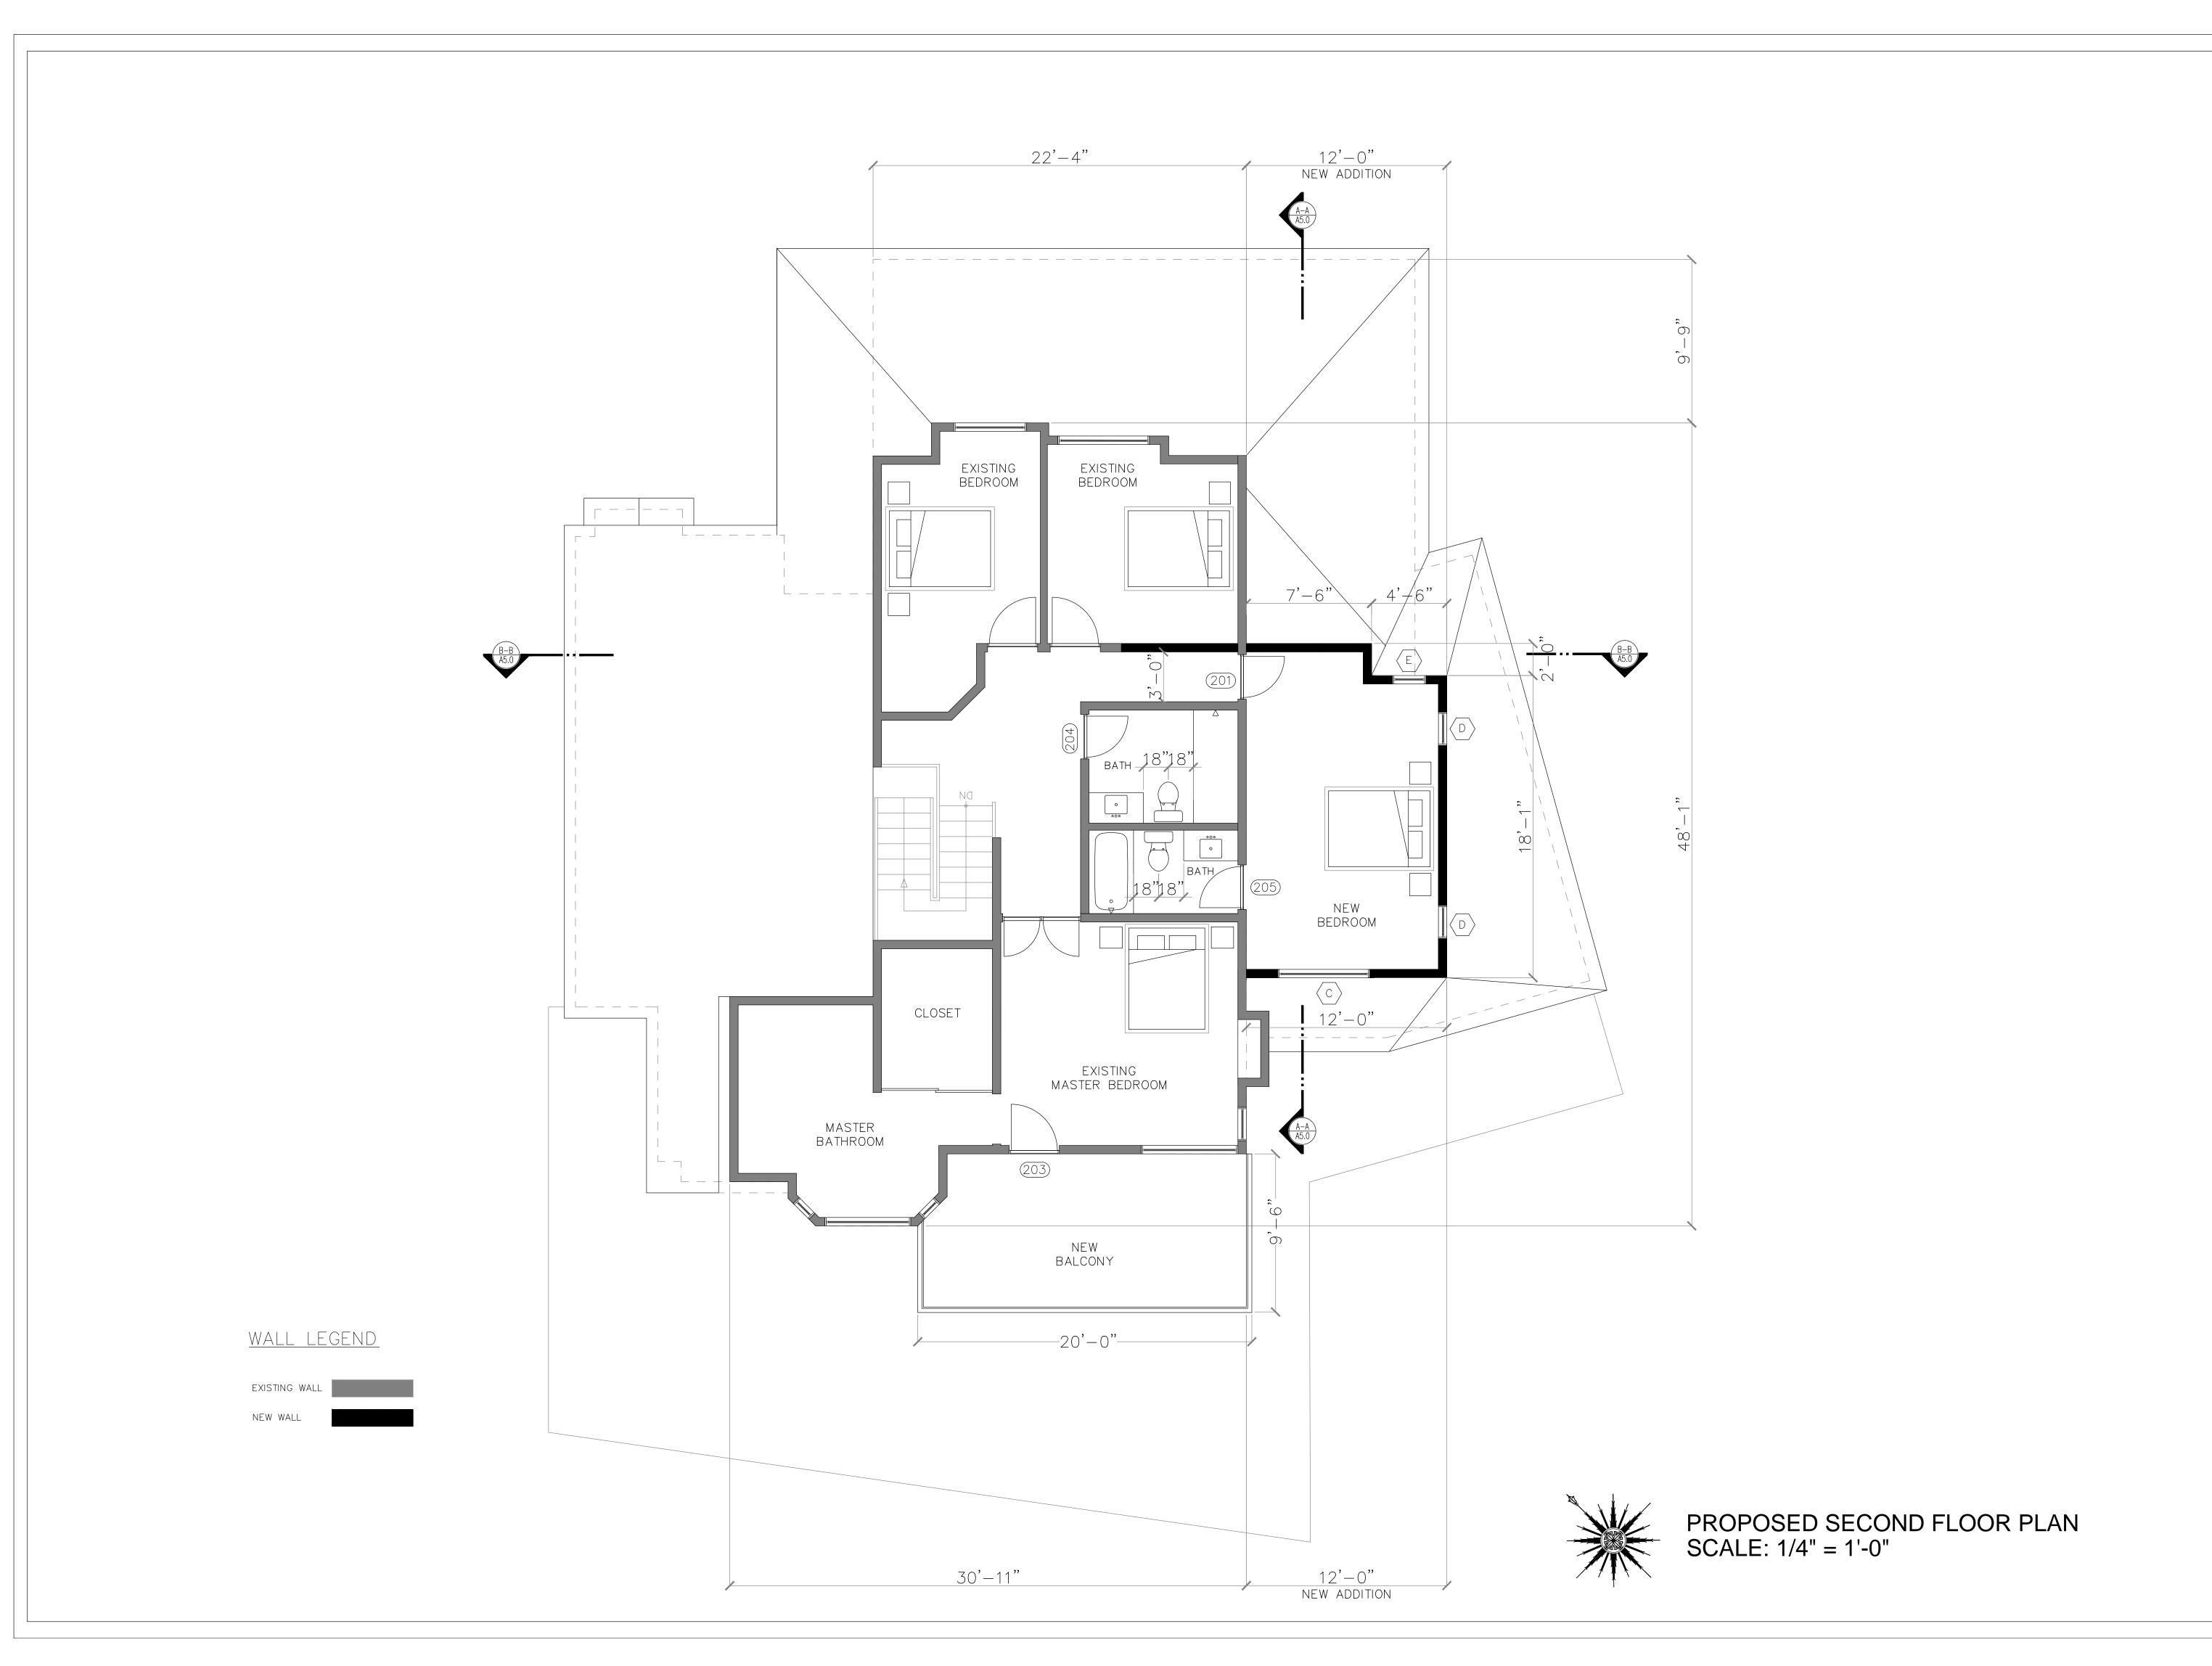
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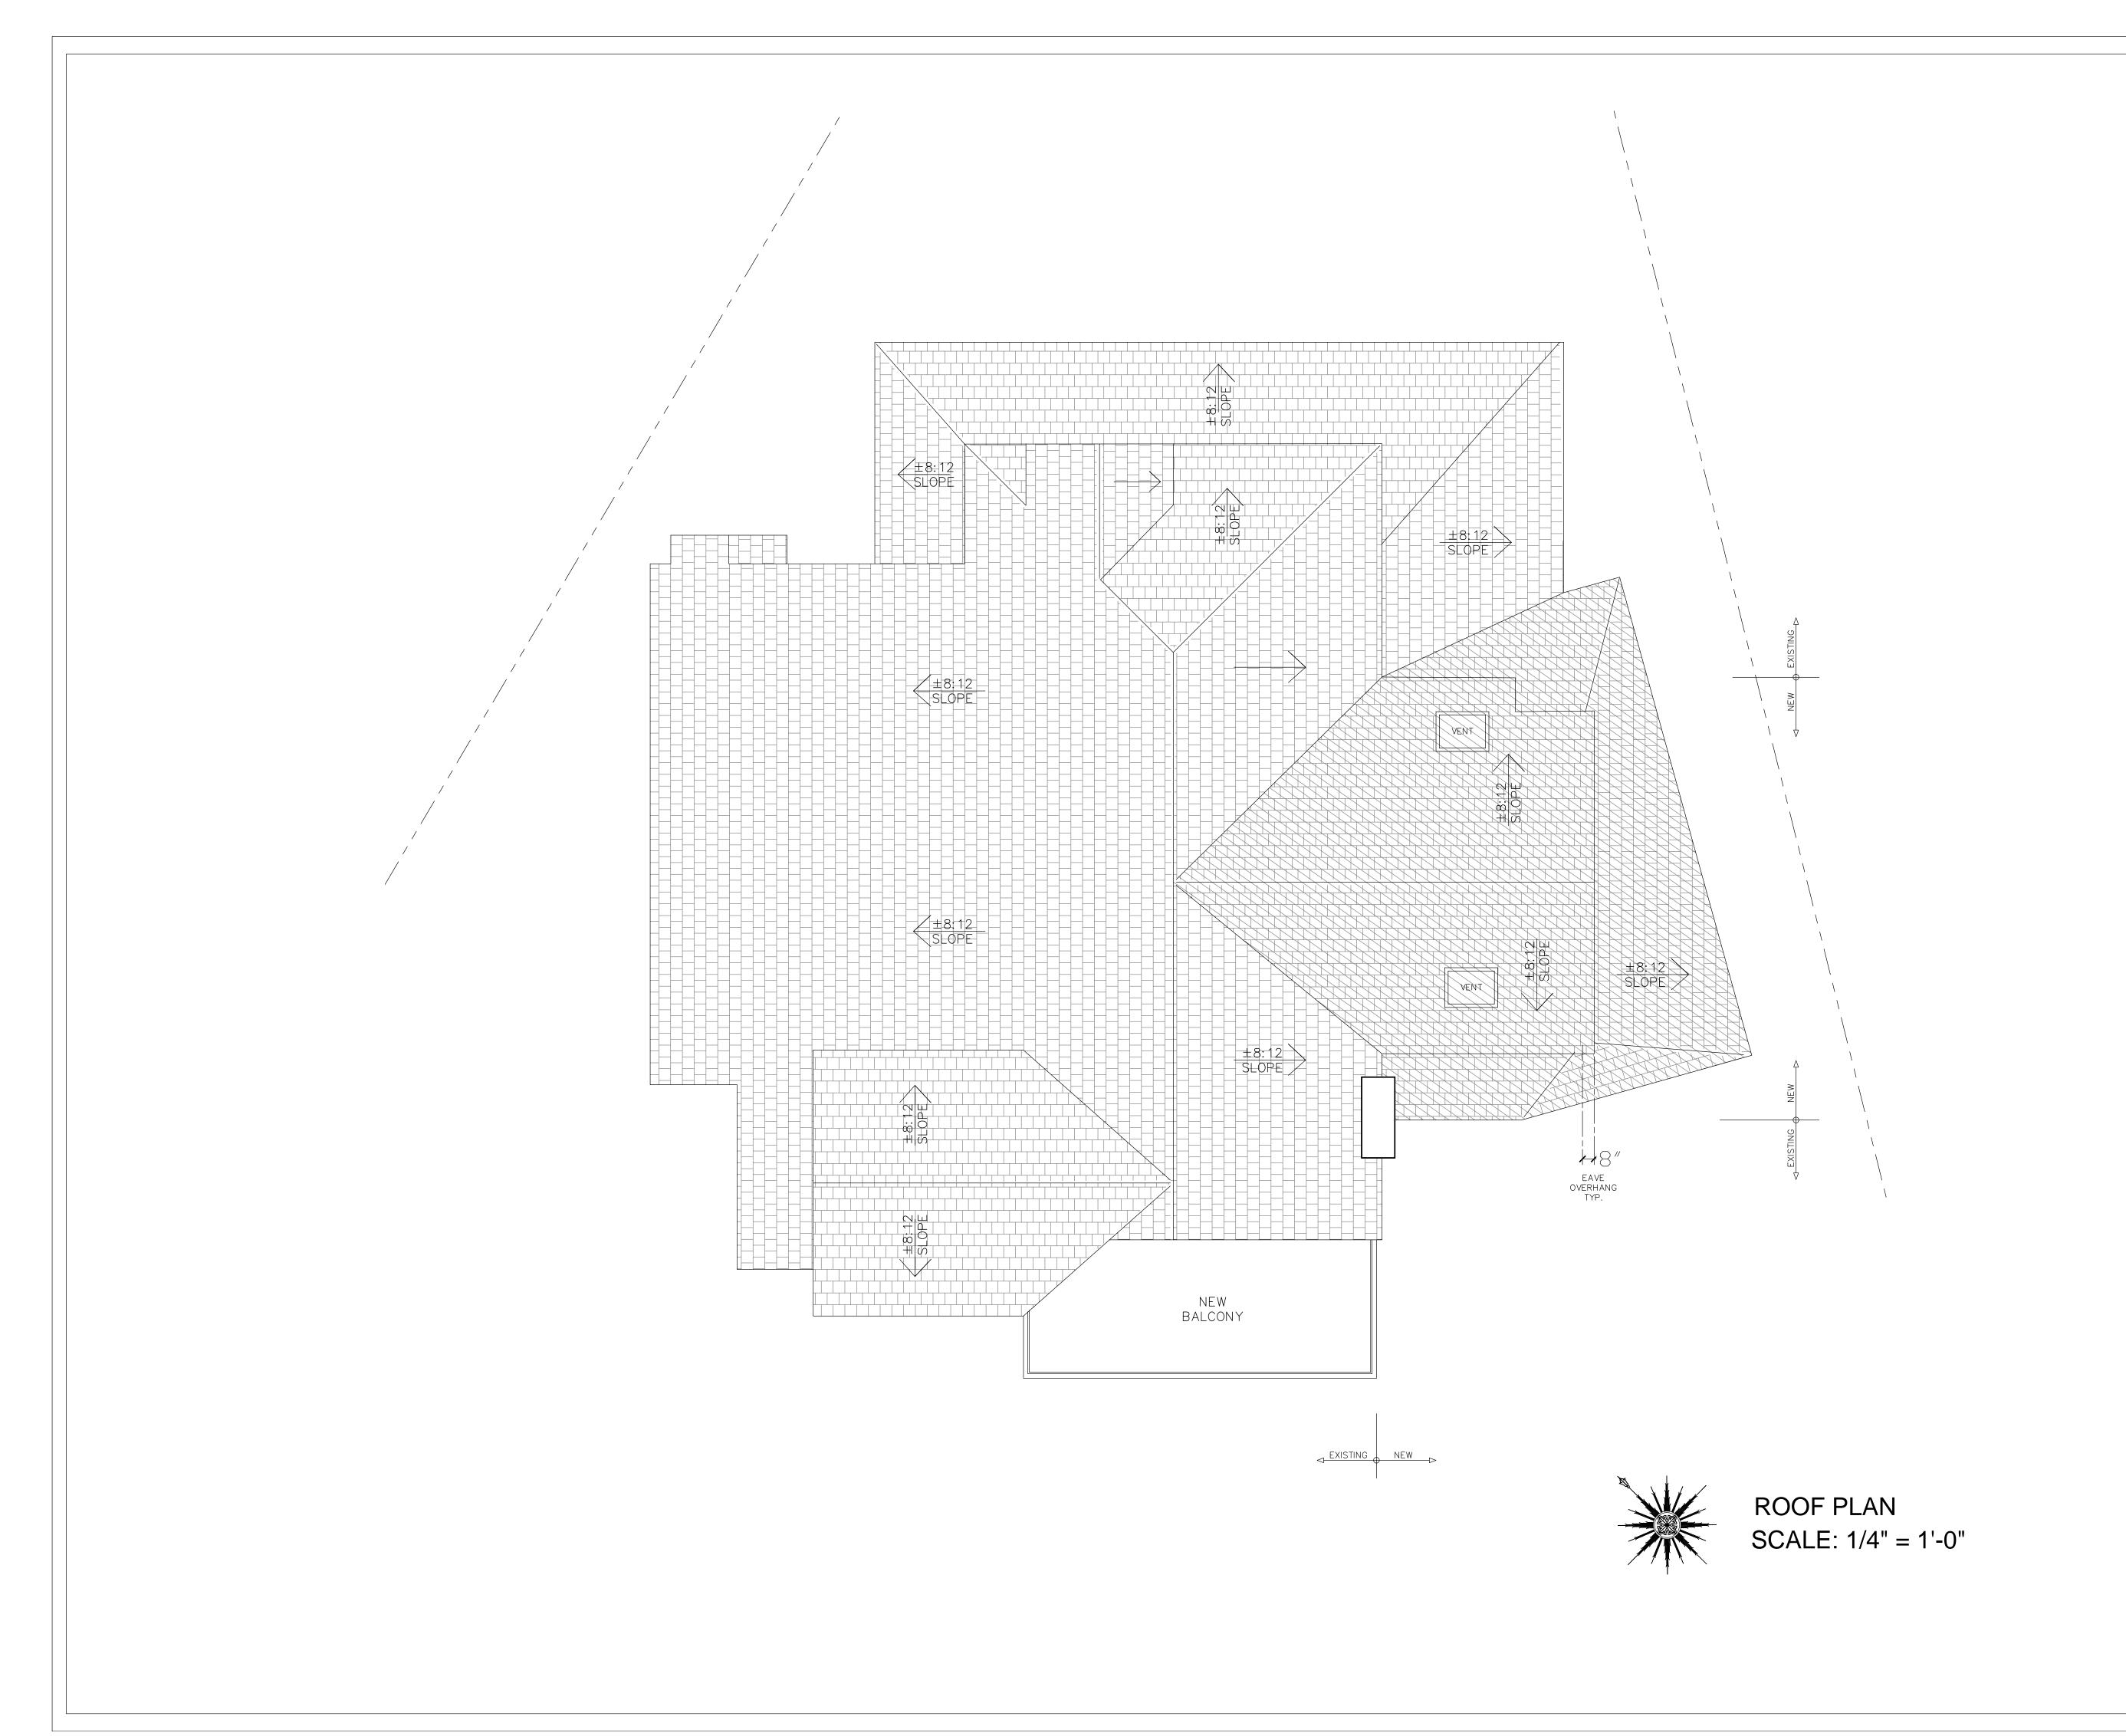
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2nd FLOOR PLAN





| PROJECT INFO | |
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| JOB NUMBER: | |
| DATE DRAWN: | 9//22//23 |
| DRAWN BY: | F.P. |
| CHECKED BY: | S.B. |
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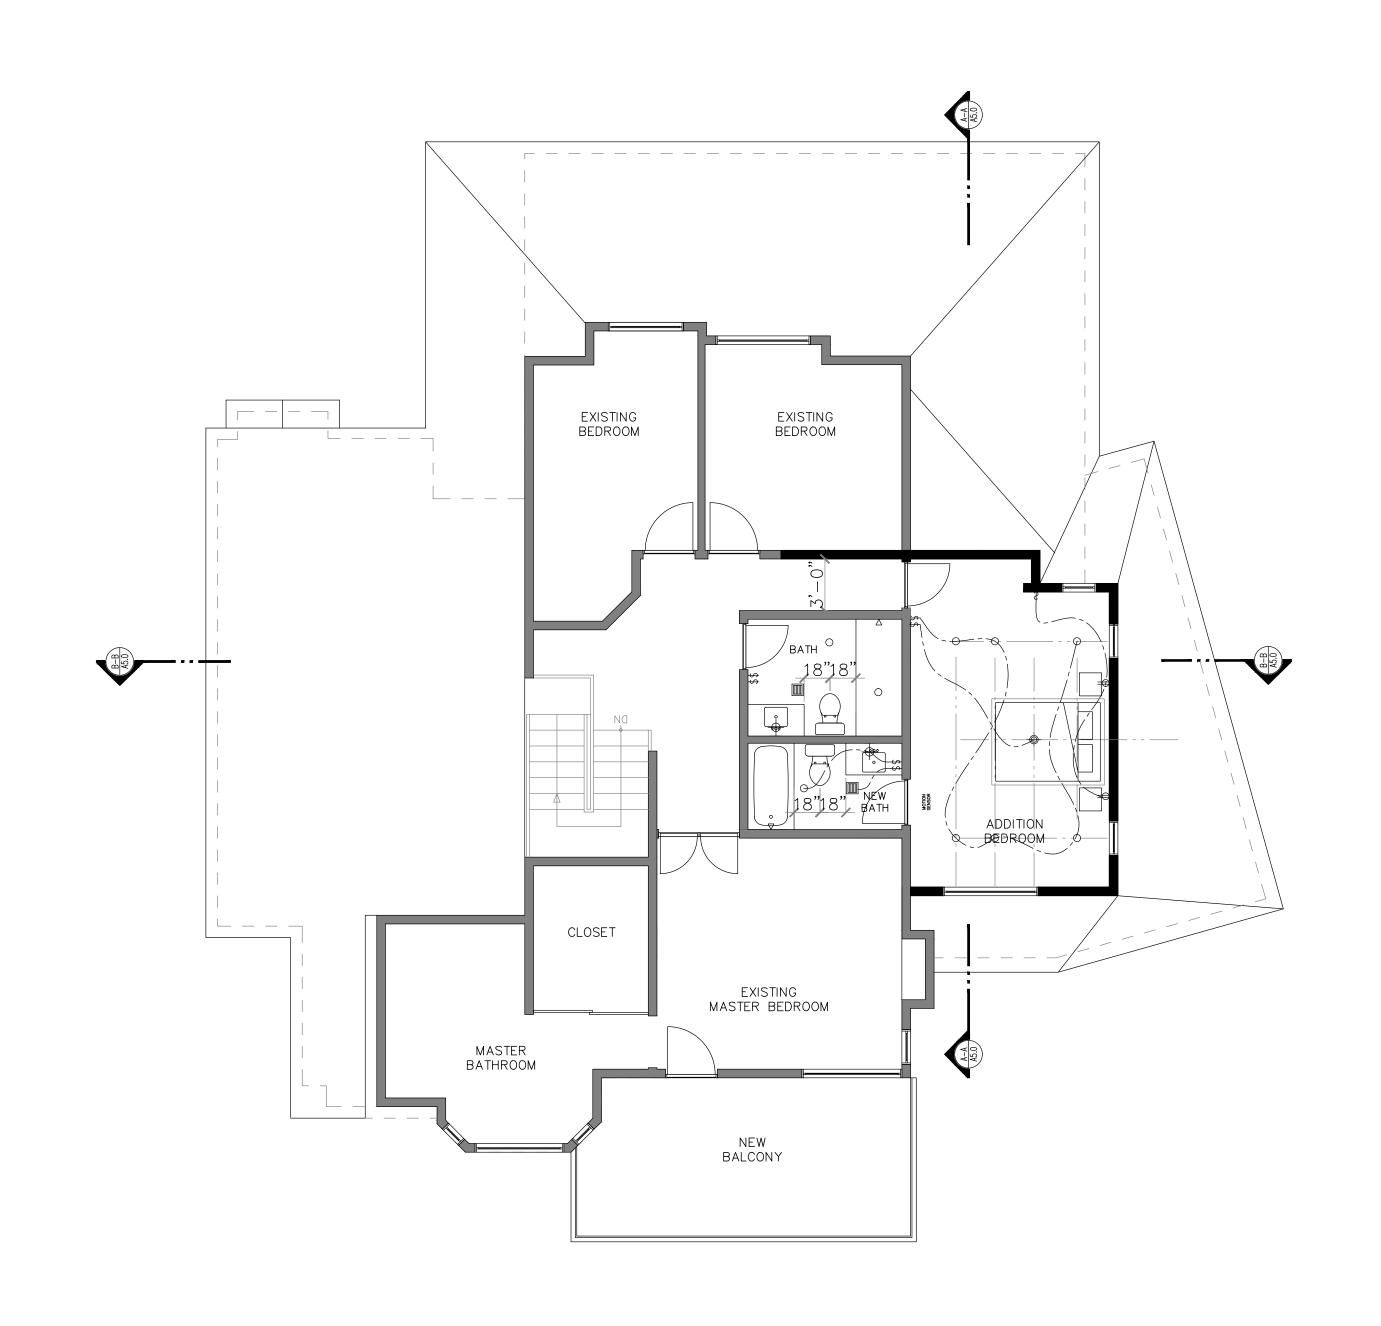
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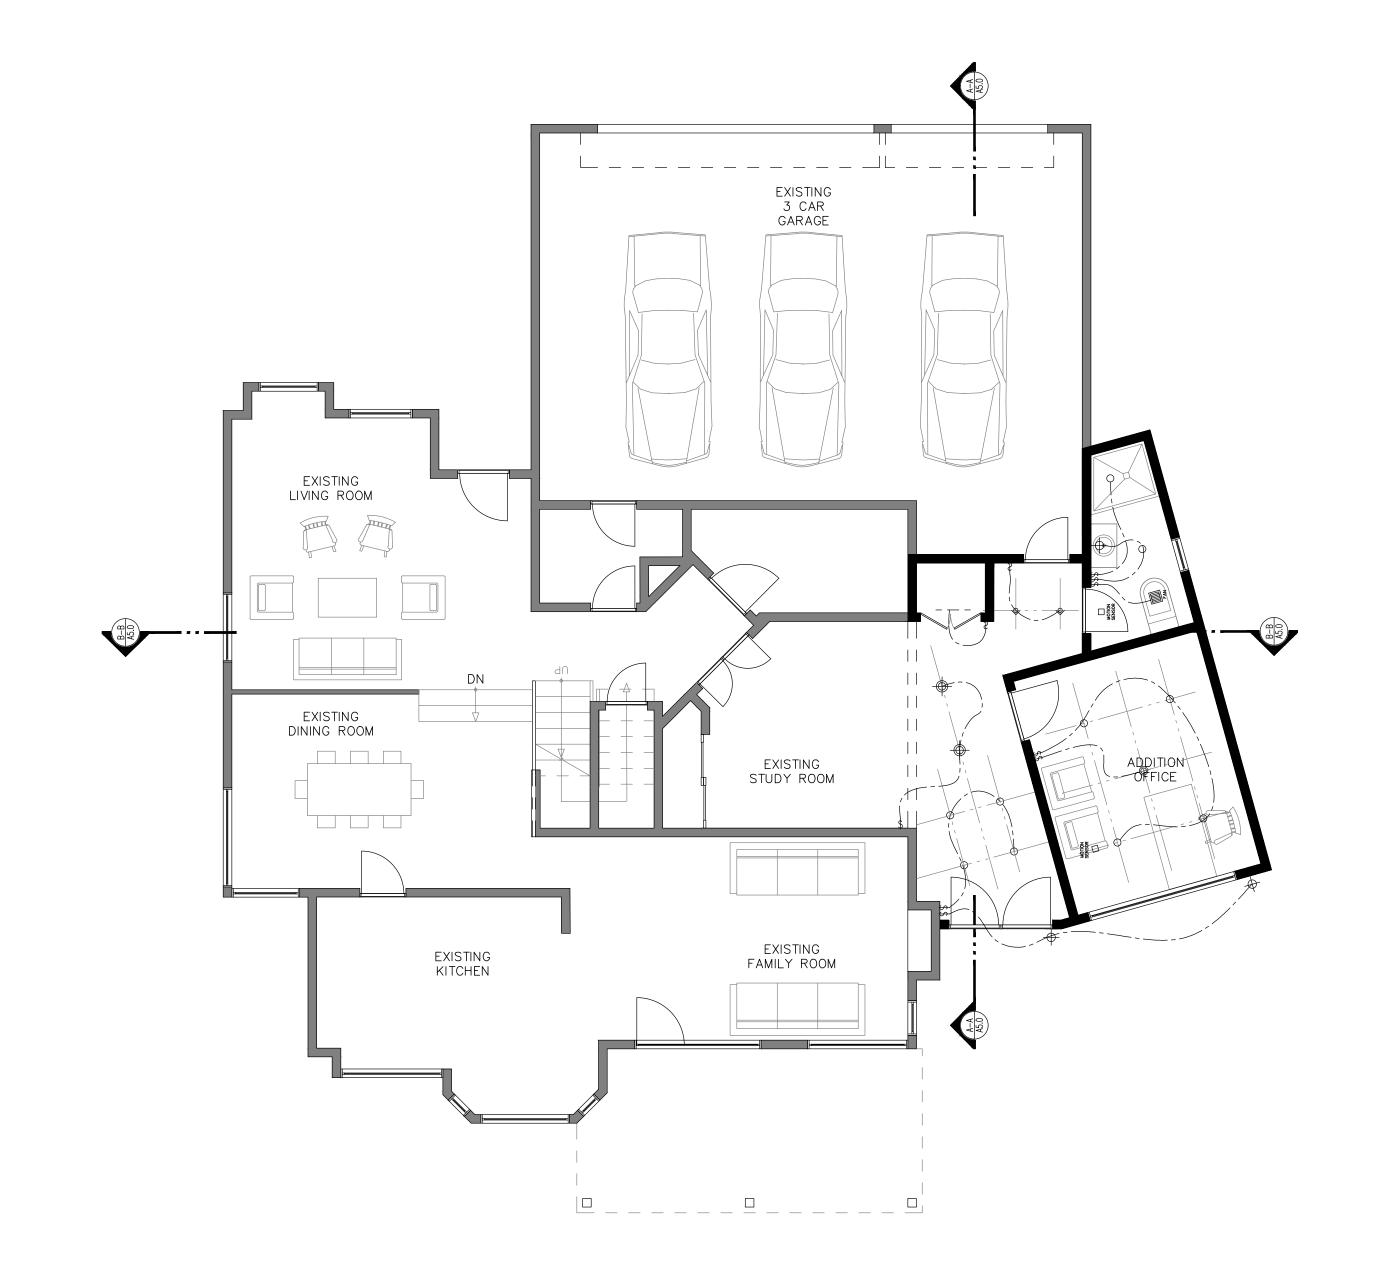
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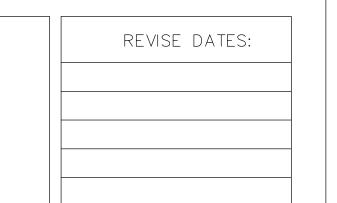
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SECOND FLOOR LIGHTING PLAN SCALE: 3/16" = 1'-0"





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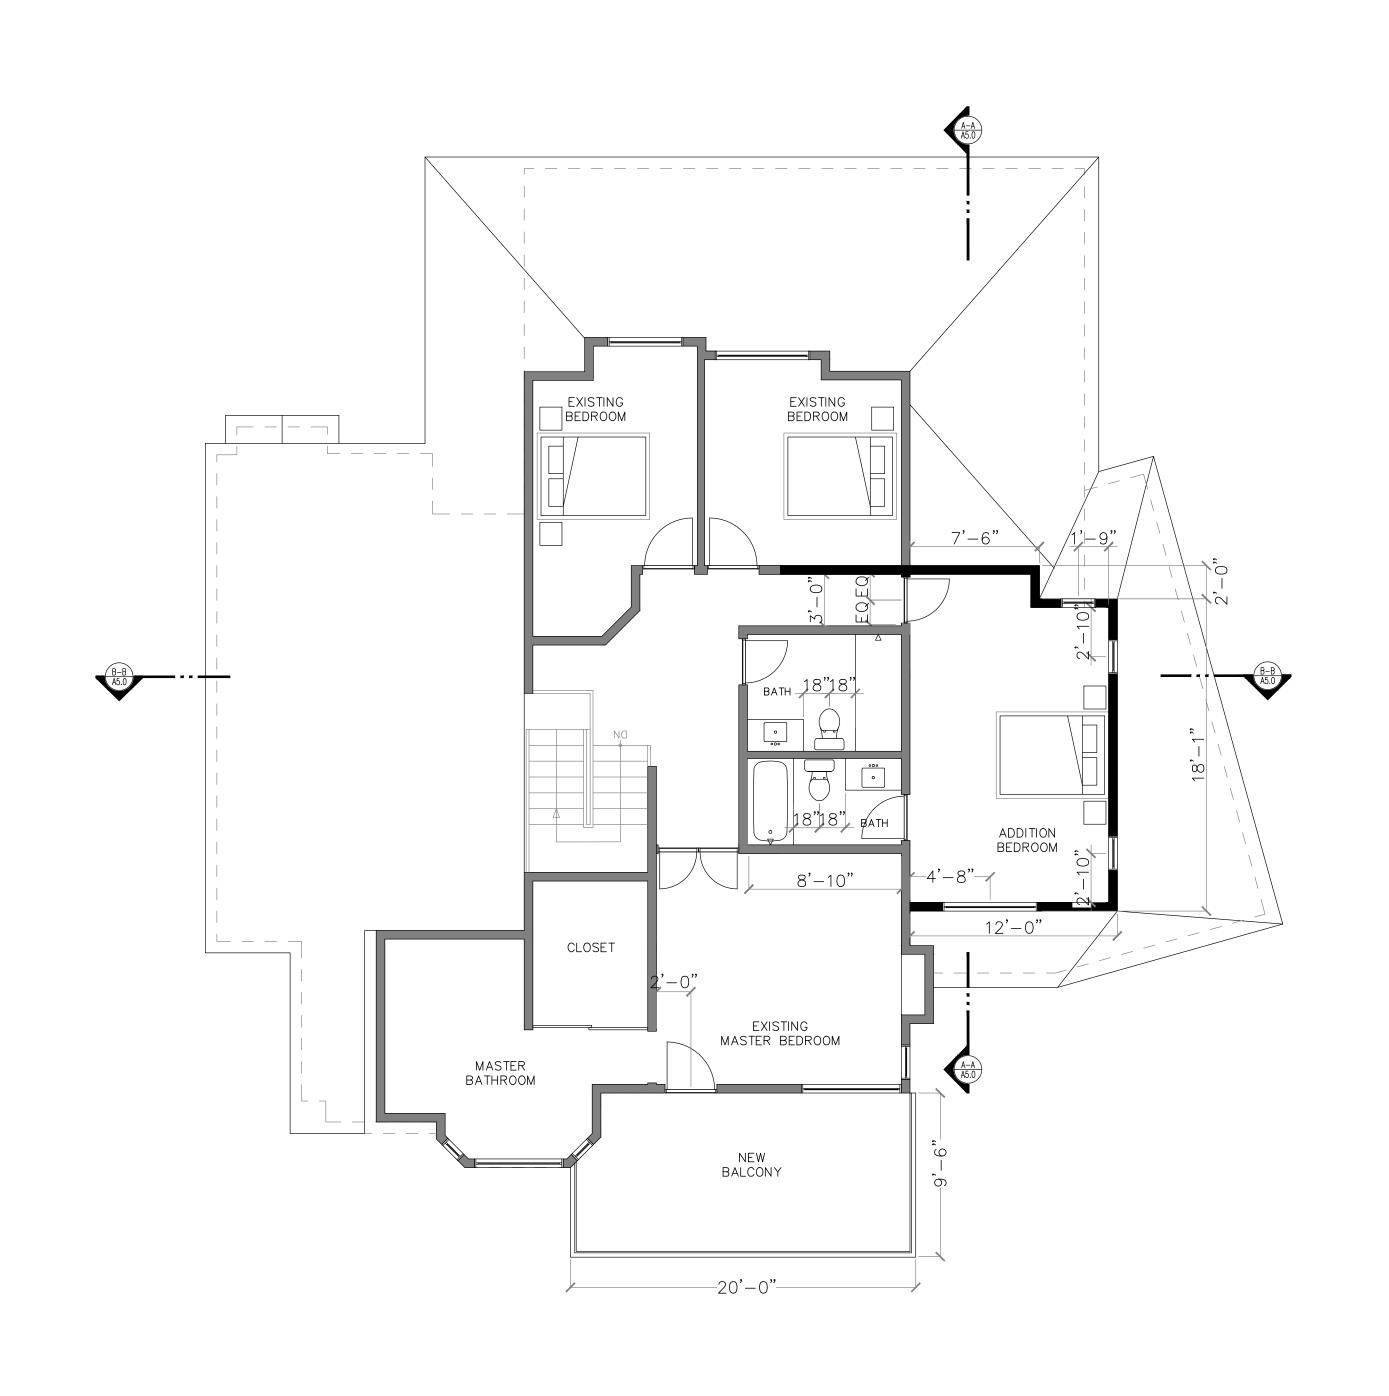
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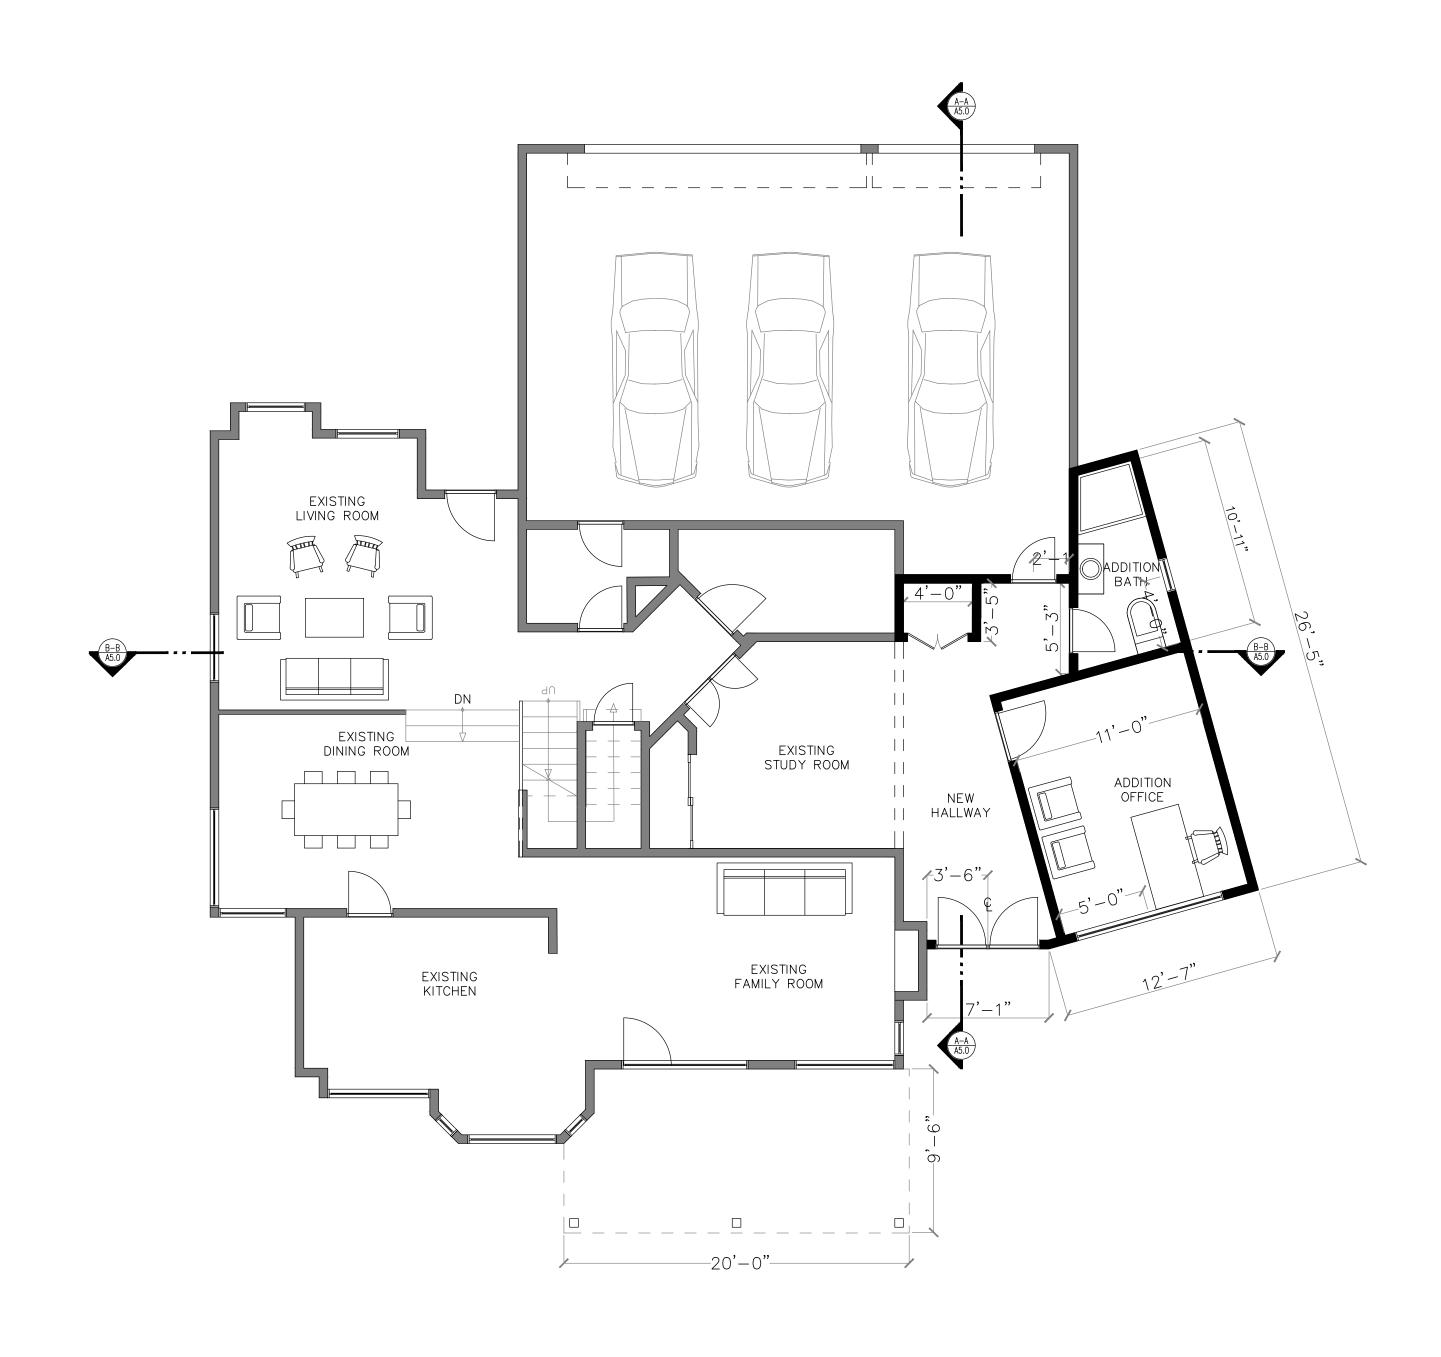
LIGHTING PLAN








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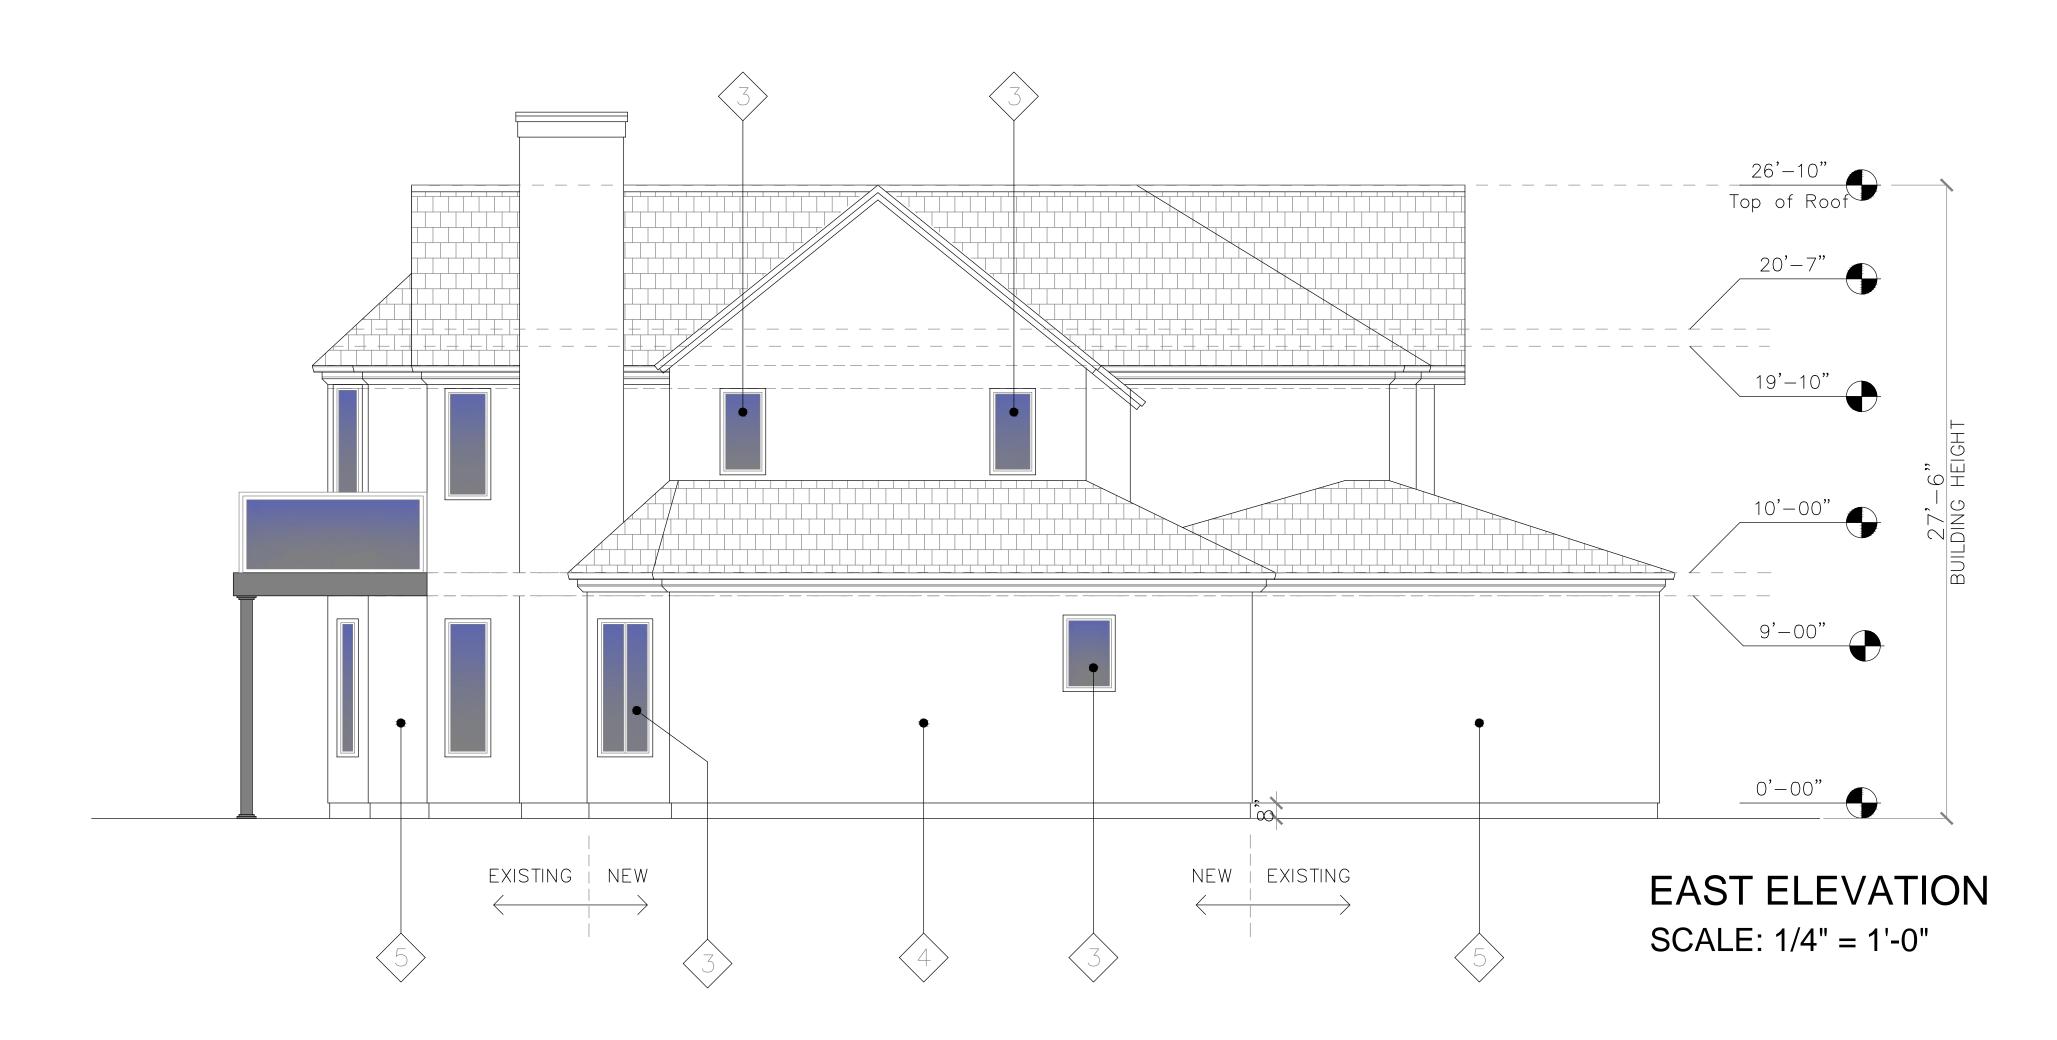
DIMENSION PLAN



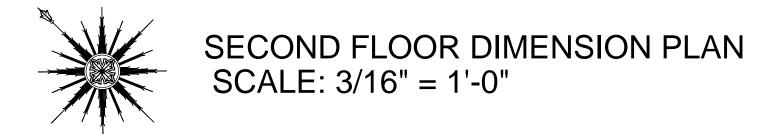

| PROJECT INFO | |
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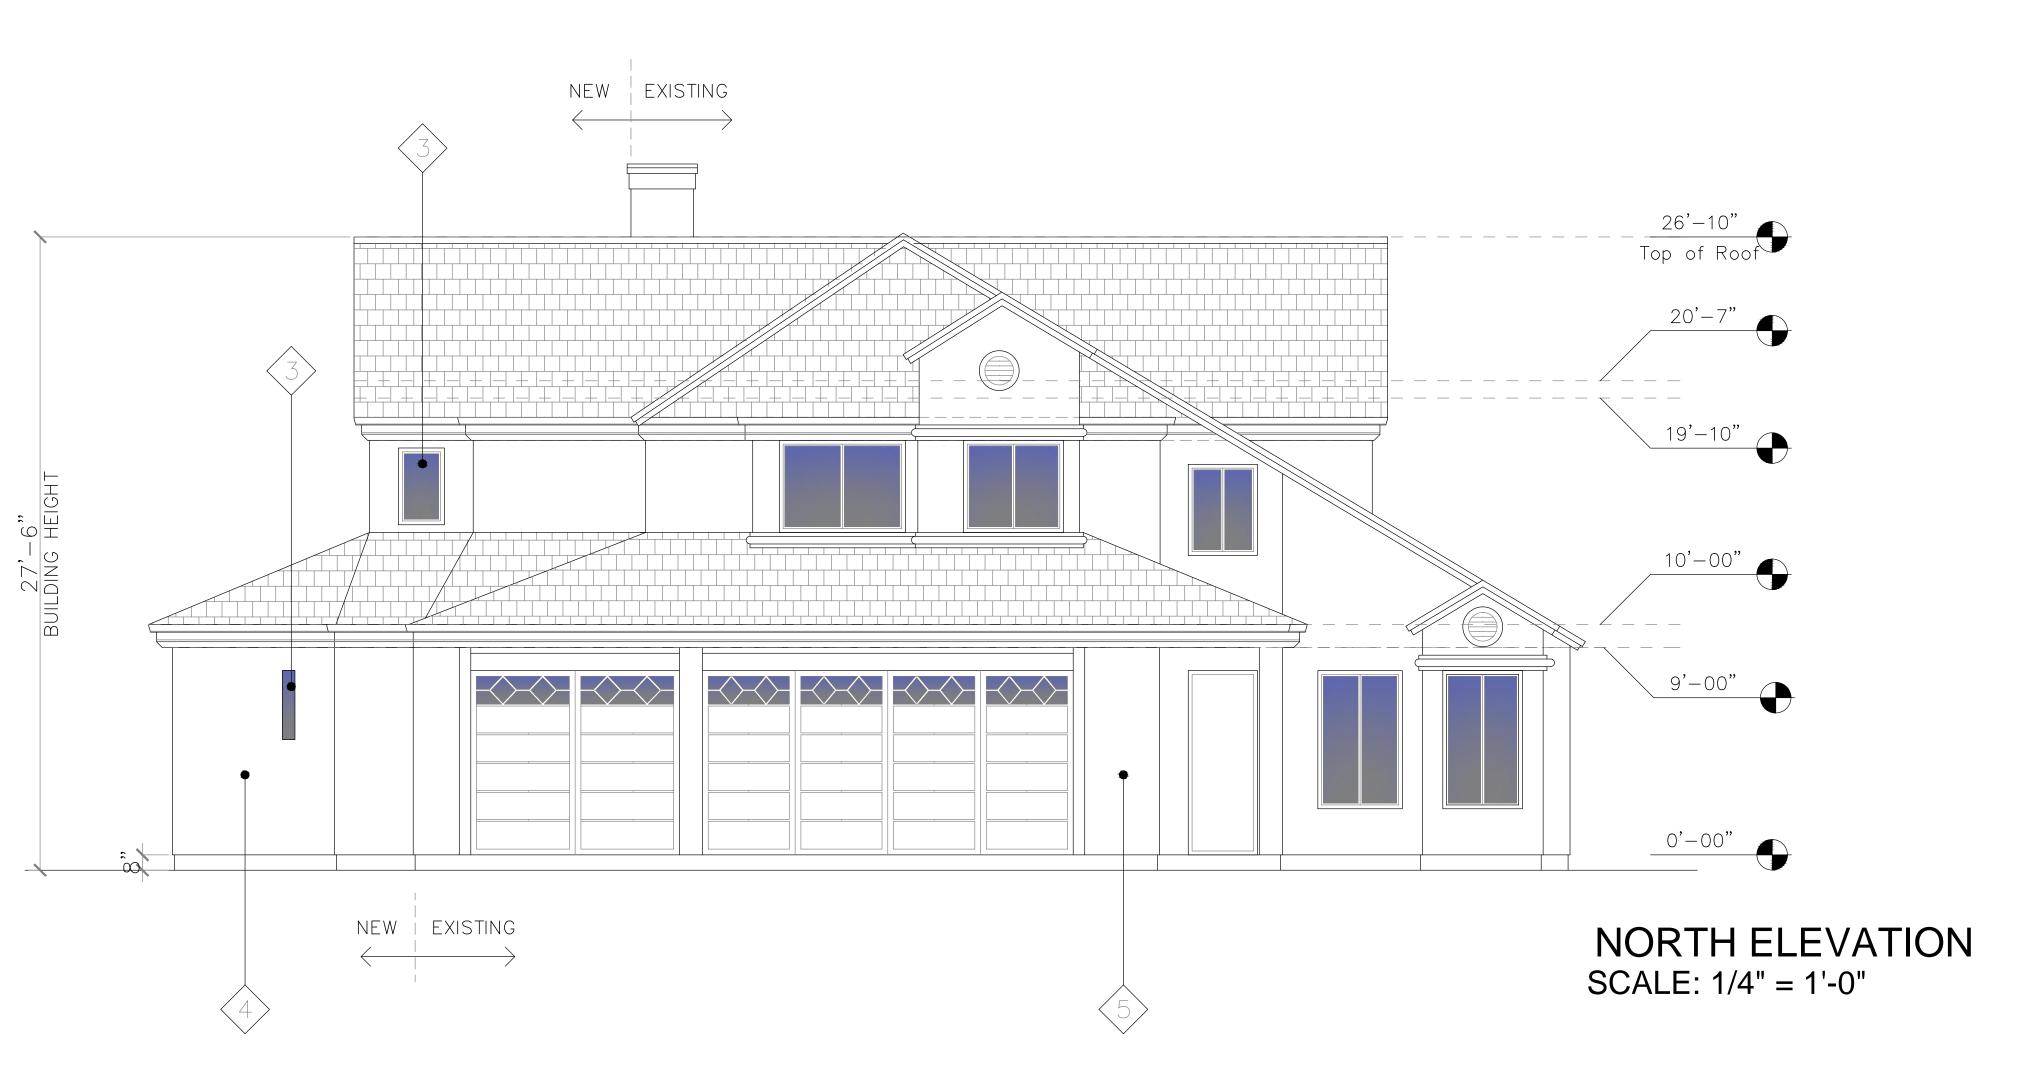


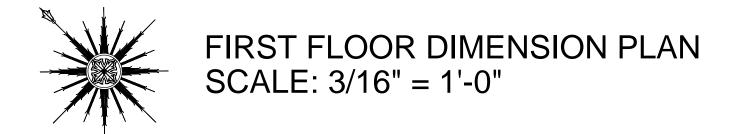

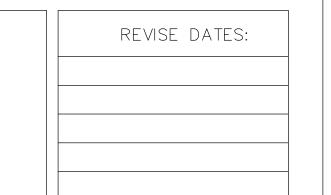

NOTE:

- NEW FACADE MATERIALS TO MATCH EXISTING.
- NEW WINDOW TRIMS TO MATCH EXISTING



REVISE DATES:

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7?? ADDRESS: 3501 FALLENLEAF PL, GLENDALE, CA 91206

PROPOSED ELEVATION





| PROJECT INFO | |
|--------------|---------|
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| SCALE: | |
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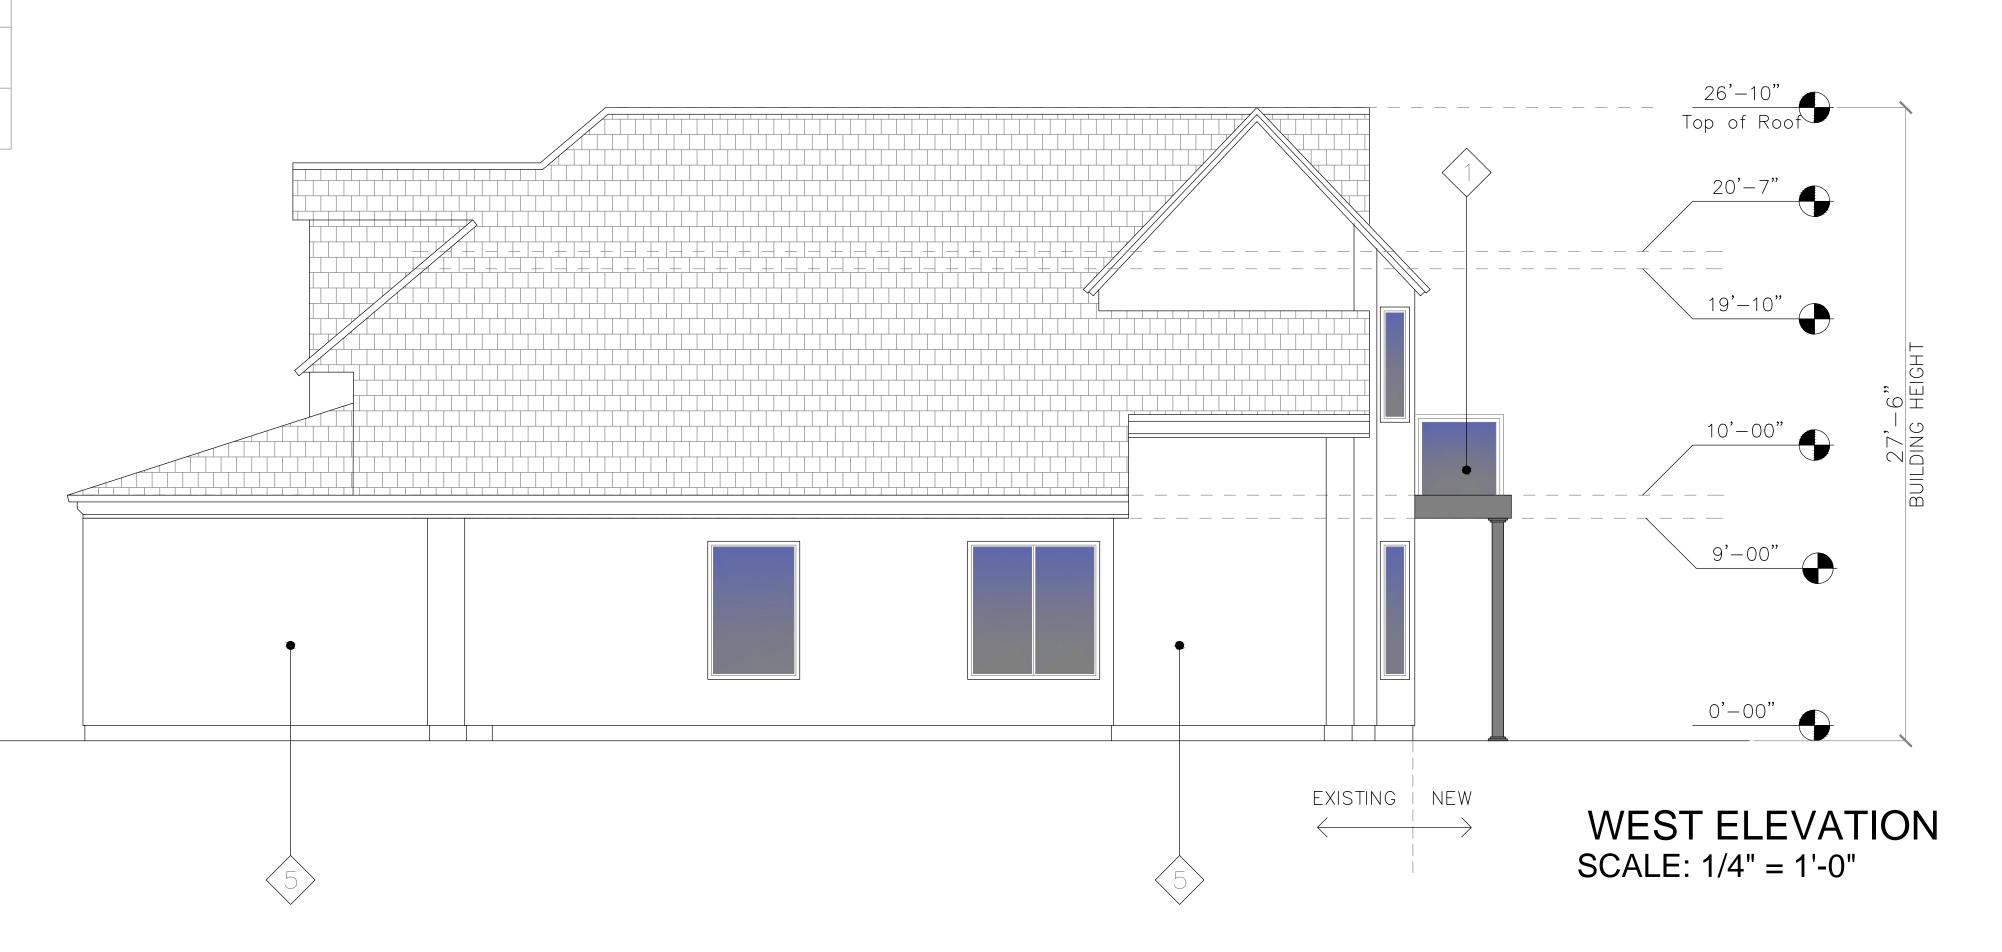
NOTE:

 NEW FACADE MATERIALS TO MATCH EXISTING.

SMOOTH STUCCO - COLOR: WHITE (MATCH EXISTING)

EXISTING SMOOTH STUCCO TO REMAIN

NEW WINDOW TRIMS TO MATCH EXISTING




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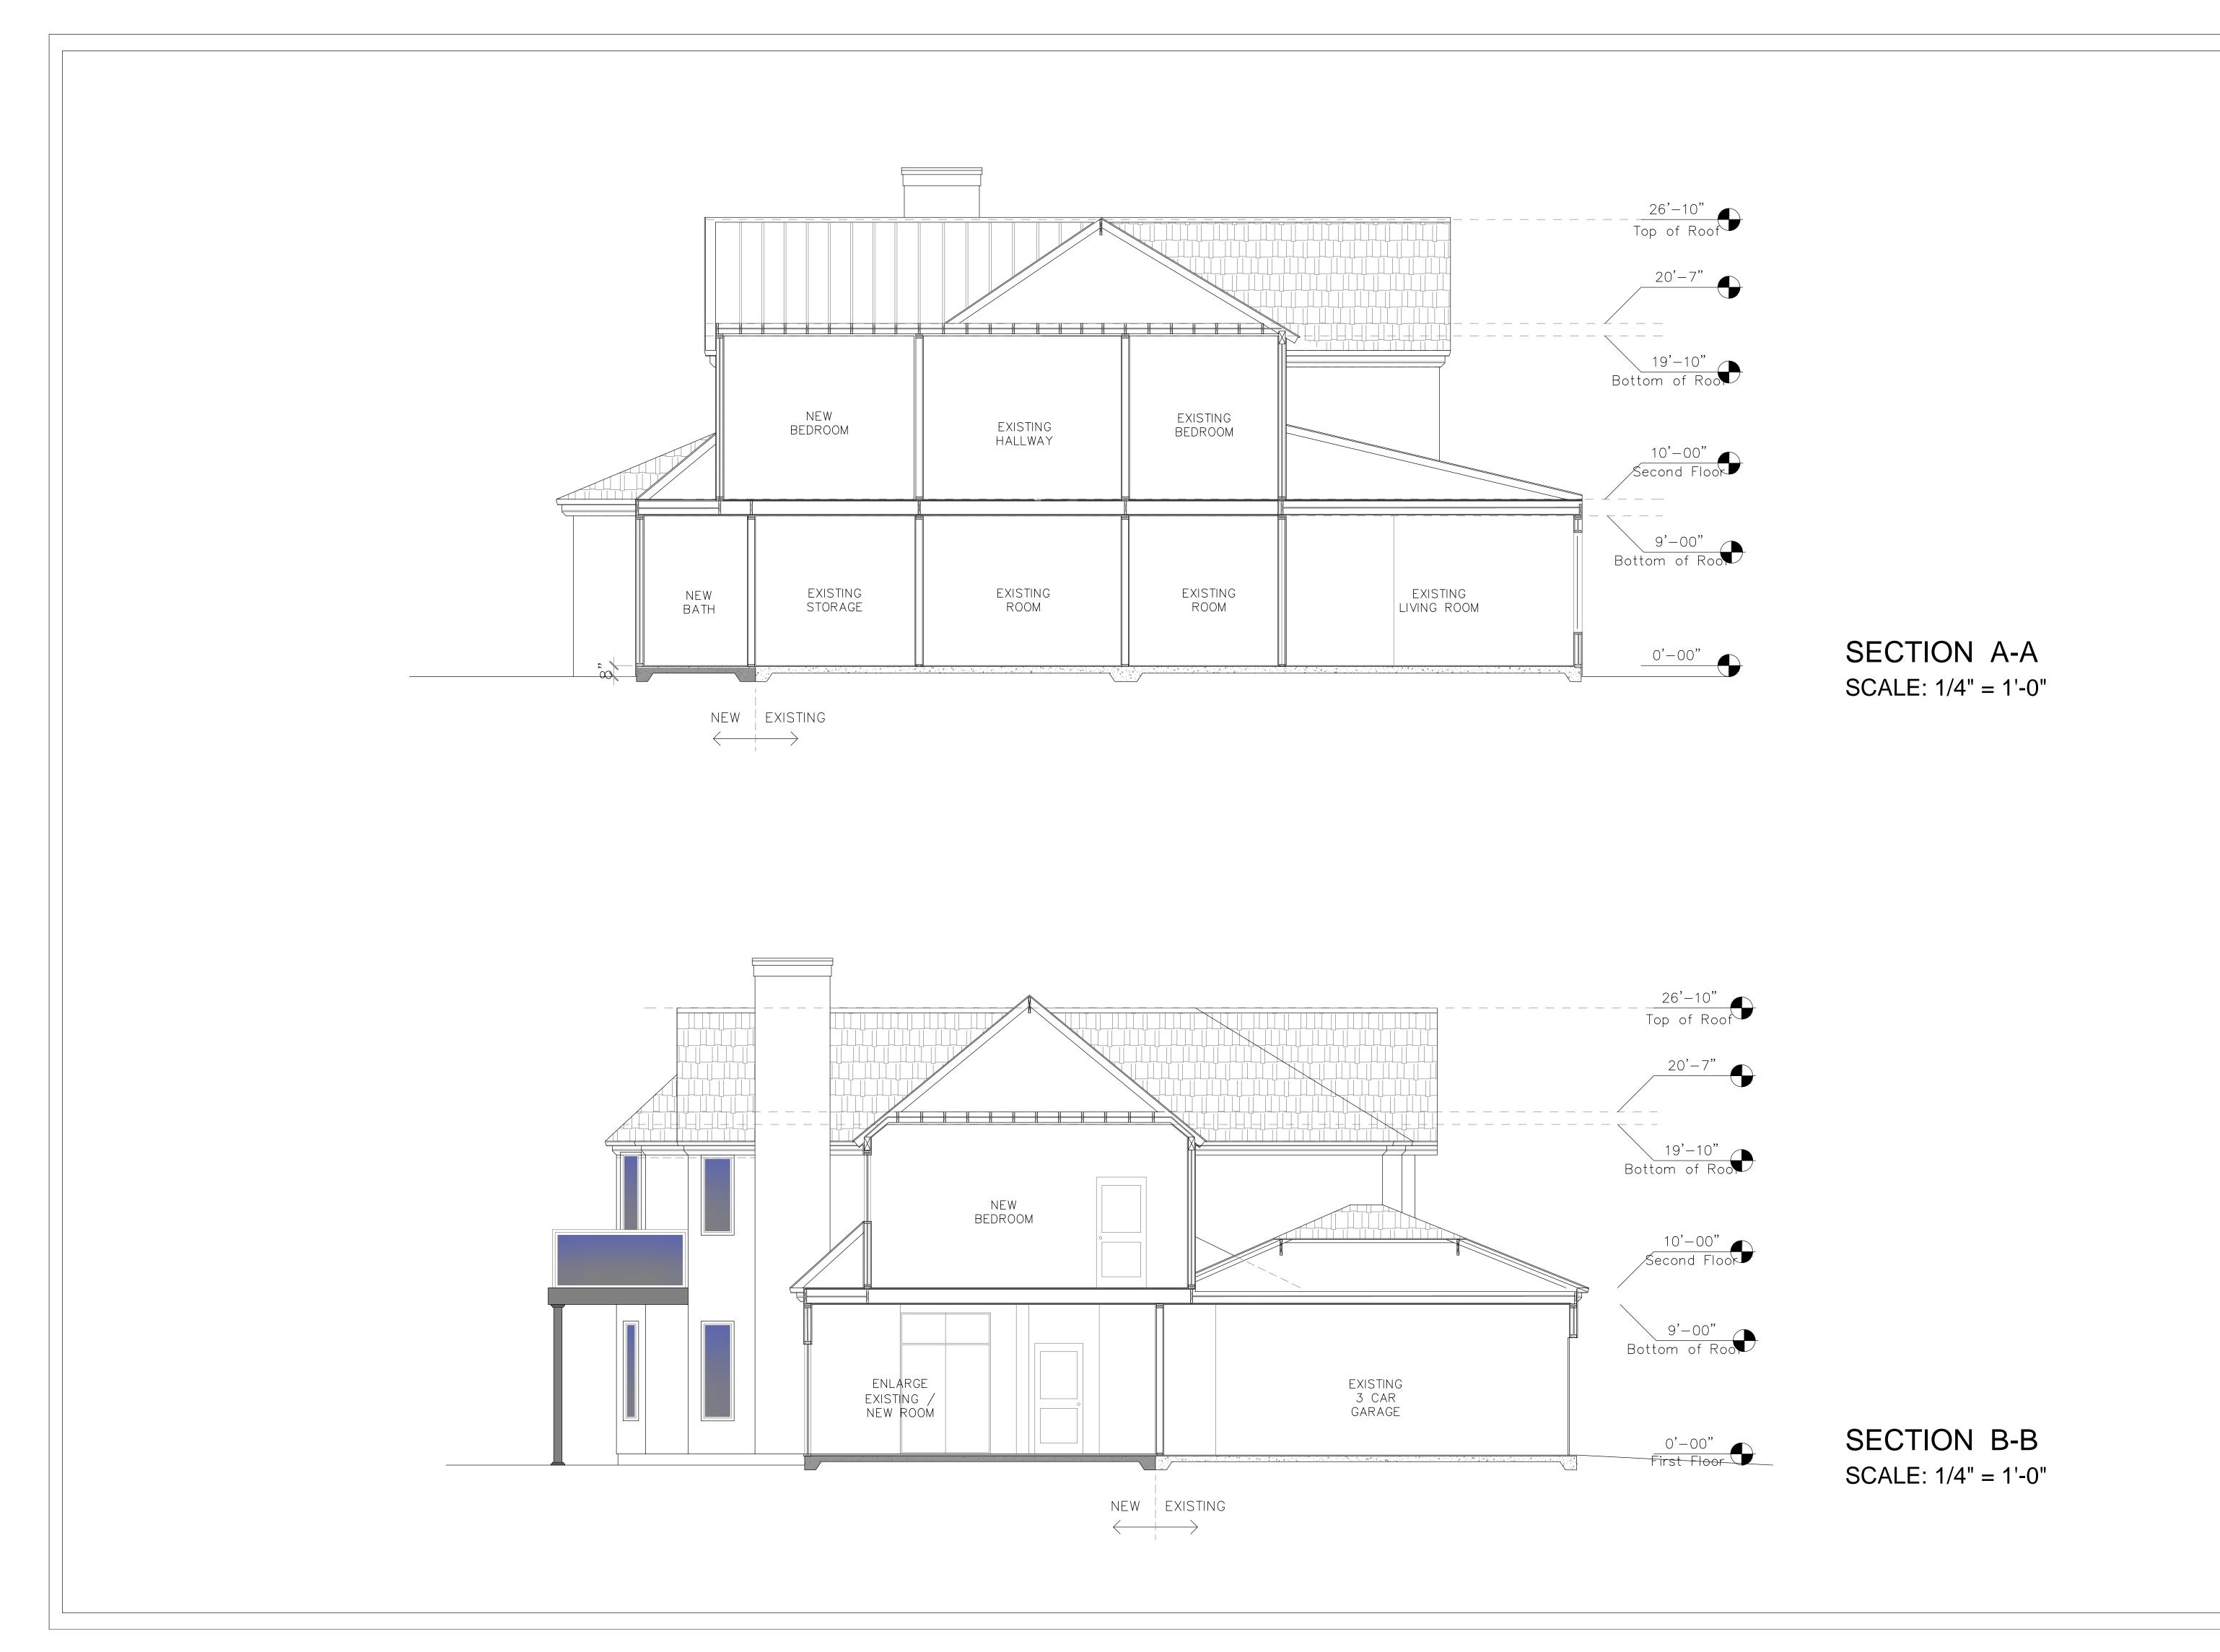
3501 FALLENLEAF PL, GLENDALE, CA 91206

PROPOSED ELEVATION





| JOB NUMBER: | |
|-------------|---------|
| DATE DRAWN: | 4/29/23 |
| DRAWN BY: | F.P. |
| CHECKED BY: | S.B. |
| SCALE: | |

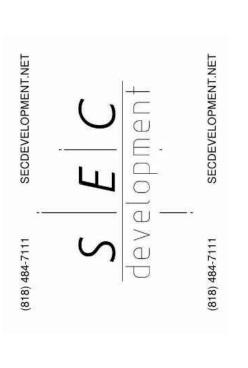

CONTRACTOR TO VERIFY ALL
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THE WORK


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REVISE DATES:

??? ADDRESS: 3501 FALLENLEAF PL, GLENDALE, CA 91206

SECTION



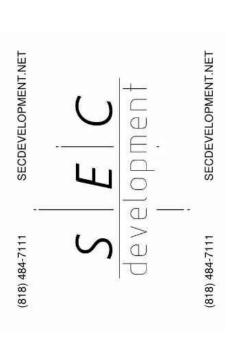

| PROJECT INFO | |
|--------------|---------|
| JOB NUMBER: | |
| DATE DRAWN: | 4/29/23 |
| DRAWN BY: | F.P. |
| CHECKED BY: | S.B. |
| SCALE: | |
| A-1 | 0 |

| | FIRST FLOOR DOOR SCHEDULE | | | | | | | | | | | |
|-------|------------------------------------------------------------------------------|-------|-------|------|------|----|---|-----|-----|--|--|--|
| | EXTERIOR | | | | | | | | | | | |
| MARK | MARK WIDTH HEIGHT OPERATION FRAMING MATERIAL TEMPERED QUANTITY U-FACTOR SHGC | | | | | | | | | | | |
| (101) | (101) 6'-0" 8'-0" SWING WOOD GLASS YES 1 0.32 C | | | | | | | | | | | |
| | INTERIOR | | | | | | | | | | | |
| (102) | 3'-0" | 8'-0" | SWING | WOOD | WOOD | NO | 1 | N/A | N/A | | | |
| (103) | 2'-8" | 8'-0" | SWING | WOOD | WOOD | NO | 2 | N/A | N/A | | | |
| (104) | 3'-6" | 8'-0" | SWING | WOOD | WOOD | NO | 1 | N/A | N/A | | | |

| | SECOND FLOOR DOOR SCHEDULE | | | | | | | | | | | |
|-------|----------------------------------------------------------------------------------------------|-------|-------|------|------|----|---|-----|-----|--|--|--|
| | INTERIOR | | | | | | | | | | | |
| MARK | MARK WIDTH HEIGHT OPERATION FRAMING MATERIAL TEMPERED QUANTITY U-FACTOR SH | | | | | | | | | | | |
| (201) | 2'-8" | 8'-0" | SWING | WOOD | WOOD | NO | 1 | N/A | N/A | | | |
| (203) | 3 3'-0" 8'-0" SWING WOOD GLASS YES | | | | | | | N/A | N/A | | | |
| (204) | 2'-8" | 8'-0" | SWING | WOOD | WOOD | NO | 1 | N/A | N/A | | | |
| (205) | 2'-8" | 8'-0" | SWING | WOOD | WOOD | NO | 1 | N/A | N/A | | | |
| (206) | 206) 6'-0" 8'-0" FOLDING WOOD WOOD NC | | | | | NO | 1 | N/A | N/A | | | |
| | | | | | | | | | | | | |

| 6'-0" | 102 103 | 3'-6" |
|-----------------------------|------------|-------------------------------------|
| 6'-0" "0-8 202 206 | 203 | 2'-8" "0 "0 204 205 |




| | | | | FIRST F | LOOR WINDOW SCHE | DULE | | | | | | | | |
|---------------------------|-------------------|--------------------|------------------------------------|-----------|-----------------------------|-------|-----------------------------------------------|---------|-----------------------------|-----|---------|--------------------------------------------------|----------|----------|
| WINDOW QUANTITY NUMBER | WIDTH x HEIGHT | MATERIAL | VISIBLE FROM THE STREETS Y/N | OPERATION | FRAME TYPE | SILL | EDGE DETAIL | BEDROOM | ENERGY EFFICIENT Y/N? | | HAZZARD | WINDOW WITHIN 18" OF FLOOR OR 40" OF DOOR? | U-FACTOR | SHGO MAX |
| (A) 1 | 8'-10" × 6'-0" | FIBERGLASS CLAD | S NO | SLIDING | NAIL—ON (MATCH EXISTING) | 2'-0" | N/A | NO | YES | YES | NO | NO | 0.32 | 0.32 |
| (B) 1 | 2'-0" × 3'-0" | FIBERGLASS CLAD | S YES | CASEMENT | NAIL—ON (MATCH EXISTING) | 5'-0" | MATCH EXISTING FRONT WINDOW EDGE DETAIL | NO | YES | YES | NO | NO | 0.32 | 0.32 |




WINDOWS/ PATIO DOORS:

| | SECOND FLOOR WINDOW SCHEDULE | | | | | | | | | | | | | | |
|------------------|------------------------------|-------------------|--------------------|----------------------------------|--------------------|-----------------------------|-------|-----------------------------------------------|---------|-----------------------------|-------|---------|--------------------------------------------------|-----------------|----------|
| WINDOW NUMBER | QUANTITY | WIDTH X HEIGHT | MATERIAL | VISIBLE FRO THE STREET Y/N | OM T? OPERATION | FRAME TYPE | SILL | EDGE DETAIL | BEDROOM | ENERGY EFFICIENT Y/N? | GLASS | HAZZARD | WINDOW WITHIN 18" OF FLOOR OR 40" OF DOOR? | U-FACTOR MAX | SHGO MAX |
| C | 1 | 5'-6" - 4'-0" | FIBERGLASS CLAD | S NO | SLIDING | NAIL—ON (MATCH EXISTING) | 4'-0" | N/A | YES | YES | YES | NO | NO | 0.32 | 0.32 |
| | 2 | 2'-0" -4'-0" | FIBERGLASS CLAD | S NO | CASEMENT | NAIL—ON (MATCH EXISTING) | 4'-0" | N/A | YES | YES | YES | NO | NO | 0.32 | 0.32 |
| E | 1 | 2'-0" -3'-4" | FIBERGLASS CLAD | S YES | CASEMENT | NAIL—ON (MATCH EXISTING) | 4'-4" | MATCH EXISTING FRONT WINDOW EDGE DETAIL | YES | YES | YES | NO | NO | 0.32 | 0.32 |
| | | | | | | | | | | | | | | | |

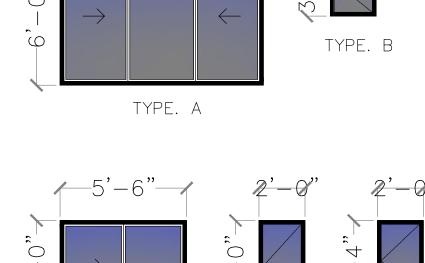

TYPE. D TYPE. E

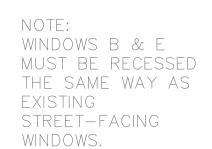



SMOOTH STUCCO COLOR: WHITE

EXTERIOR WALLS:



SLEEK COLOR: GREYED NICKEL

IN THE BACKYARD




MILGARD FRAME COLOR: BLACK BEAN

RAILINGS:



CRL GLASS RAILING SYSTEM

TYPE. C

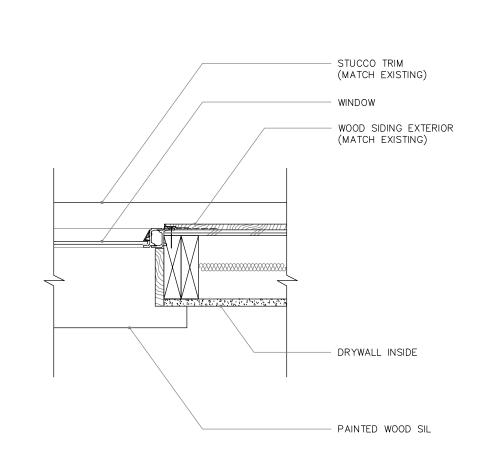

WINDOW JAMB DETAIL SCALE: 1 1/2" = 1'-0"

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| PROJECT INFO | | | | | | | | |
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| DATE DRAWN: | 4/27/23 | | | | | | | |
| DRAWN BY: | F.P. | | | | | | | |
| CHECKED BY: | S.B. | | | | | | | |
| SCALE: | | | | | | | | |
| B-1 | | | | | | | | |

RESPECTIVELY, BORED HOLES IN BEARING/NONBEARING WALLS SHALL NOT EXCEED 40% /60% OF IT, RESPECTIVELY, BOKED HOLES IN BEAKING/NONBEAKING WALLS SHALL NOT EAGEED 40%/80% OF WIDTH.

RESPECTIVELY, (RC602.6)

INTERIOR FINISHES IN GROUP R-3 SHALL HAVE A FLAME SPREAD INDEX OF NOT GREATER THAN 200, AND THE CRAWL SPACE. WHERE IT IS REQUIRED TO MOVE UNDER DUCTS FOR ACCESS TO AREAS OF THE CRAWL SPACE. A VERTICAL CLEARANCE OF 18" MINIMUM SHALL BE PROVIDED. (MC603.1)

5. WHERE FLASHING IS OF METAL, THE METAL SHALL BE CORROSION RESISTANT WITH A THICKNESS OF NOT LESS THAN .019 INCH (NO. 26 GALVANIZED SHEET). (RC903.2.1)

6. NOTE ON THE PLANS: "ROOF DIAPHRAGM NAILING TO BE INSPECTED BEFORE COVERING. FACE GRAIN PLYWOOD SHALL BE PERPENDICULAR TO SUPPORTS." SUBFLOORS SHALL HAVE END-MATCHED LUMBER, HAVE BLOCKED PANEL EDGES, OR OCCUR OVER SUPPORTS. FLOOR SHEATING SHALL. COMPLY WITH SECTION R503. THE FOLLOWING SHALL BE CONSIDERED SPECIFIC HAZARDOUS LOCATIONS REQUIRING SAFETY PER SECTION R308 GLAZING IN FIXED AND OPERABLE PANELS OF SWINGING, SLIDING, AND BIFOLD DOORS. GLAZING IN FIXED OR OPERABLE PANELS ADJACENT TO A DOOR WHERE THE NEAREST EDGE OF THE GLAZING IS LESS THAN 60 INCHES ABOVE THE WALKING SURFACE. VERTICAL WINDOW GLAZING IN AN INDIVIDUAL FIXED OR OPERABLE PANEL, THAT MEETS ALL OF THE FOLLOWING CONDITIONS: THE EXPOSED AREA OF AN INDIVIDUAL PANE IS LARGER THAN 9 SQUARE FEET. THE BOTTOM EDGE IS LESS THAN 18 INCHES ABOVE THE FLOOR. THE TOP EDGE IS MORE THAN 36 INCHES ABOVE THE FLOOR. ONE OR MORE WALKING SURFACES ARE WITHIN 36 INCHES, MEASURED HORIZONTALLY AND IN A STRAIGHT LINE, OF THE GLAZING.
GLAZING IN GUARDS, RAILINGS, STRUTURAL BALUSTER PANELS, AND NONSTRUCTURAL IN-FILL PANELS, REGARDLESS OF AREA OR HEIGHT ABOVE A WALKING SURFACE. GLAZING IN WALLS, ENCLOSURES OR FENCES CONTAINING OR FACING HOT TUBS, SPAS, WHIRLPOOL, SAUNAS, STEAM ROOMS, BATHTUBS, SHOWERS, AND INDOOR OR OUTDOOR SWIMMING POOLS, WHERE ALL OF THE FOLLOWING CONDITIONS ARE THE BOTTOM EDGE OF THE GLAZING IS LESS THAN 60 INCHES ABOVE ANY STANDING OR WALKING SURFACE.
THE GLAZING IS WITHIN 80 INCHES, MEASURED HORIZONTALLY AND IN A STRAIGHT FROM A HOT TUB, SPA, WHIRLPOOL, BATHTUB, OR SWIMMING POOL.
GLAZING ADJACENT TO STAIRS AND RAMPS WHERE THE BOTTOM EXPOSED EDGE IS LESS
INCHES ABOVE THE PLANE OF THE ADJACENT WALKING SURFACE OF STAIRWAYS. LINE THAN 36 ANDINGS BETWEEN FLIGHTS OF STAIRS, AND RAMPS, UNLESS THE GLAZING IS MORE THAN

MEASURED HORIZONTALLY FROM THE WALKING SURFACE, OR A RAIL IS

GLAZING ADJACENT TO THE LANDING AT THE BOTTOM OF THE STAIRWAY WHERE THE
LESS THAN 36 INCHES ABOVE THE LANDING AND WITHIN 60 INCHES
OF THE
BOTTOM OF THE TREAD, UNLESS THE GLAZING IS MORE THAN 18

R308.4.6

DESIGNED PER SECTION

HORIZONTALLY OF THE INCHES FROM A PROTECTIVE

GLAZING IS

MECHANICAL/PLUMBING/ELECTRICAL CODE REQUIREMENTS:

DWELLING SHALL BE PROVIDED WITH COMFORT HEATING FACILITIES CAPABLE OF MAINTAINING ROOM TEMPERATURE OF 68 DEGREES F AT 3 FEET ABOVE THE FLOOR AND 2 FEET FROM

EXTERIOR

WALLS.
THE FOLLOWING ARE REQUIRED FOR CENTRAL HEATING FURNACES AND LOW-PRESSURE BOILERS IN A COMPARTMENT:

LISTED APPLIANCES SHALL BE INSTALLED WITH CLEARANCES IN ACCORDANCE WITH

THE TERMS OF THEIR LISTINGS AND THE MANUFACTURER'S INSTALLATION INSTRUCTIONS, (MC 904.2(1))

THE

UNLISTED APPLIANCES SHALL MEET BOTH THE CLEARANCES IN TABLE 904.2. AND

CLEARANCES ALLOWED BY THE MANUFACTURER'S INSTALLATION INSTRUCTIONS WHEN COMBUSTION AIR IS TAKEN FROM INSIDE, THE AREA OF COMBUSTION AIR OPENINGS SHALL BE 1 SQ. INCH PER 1,000 BTU (100 SQ. INCH MINIMUM) PER OPENING ONE OPENING SHALL BE WITHIN 12 INCHES OF THE CEILING AND THE SECOND SHALL BE WITHIN 12 INCHES OF THE BOTTOM OF THE ENCLOSURE. THE DIMENSION SHALL NOT BE LESS THAN 3 INCHES. (MC701.5(1))

1/4 INCH SCREENS ARE REQUIRED AT OPENINGS WHERE COMBUSTION AIR IS TAKEN

SEPERATE DUCTS SHALL BE USED FOR UPPER AND LOWER COMBUSTION AIR

OPENINGS

AND MAINTAINED TO THE SOURCE OF COMBUSTION AIR. (MC701.11(4)) THE FOLLOWING ARE REQUIRED FOR APPLIANCES INSTALLED IN AN ATTIC AN OPENING AND PASSAGEWAY SHALL NOT BE LESS THAN THE SIZE OF THE

LARGEST PIECE OF EQUIPMENT

WHERE THE PASSAGEWAY HEIGHT IS LESS THAN 6 FEET. THE DISTANCE FROM ACCESS TO THE APPLIANCE SHALL NOT EXCEED 20 FEET, AS MEASURED ALONG THE

CENTERLINE. (MC904.10.1) PASSAGEWAY SHALL BE UNOBSTRACTED AND SHALL HAVE SOLID FLOORING NOT

LESS THAN 24 INCHES WIDE FROM ENTRANCE TO APPLIANCE, (MC904.10,2) A LEVEL WORKING PLATFORM NOT LESS THAN 30 INCHES BY 30 INCHES IS REQUIRED

IN FRONT OF THE SERVICE SIDE OF THE APPLIANCE (MC904 10 3) A PERMANENT 120V RECEOTABLE OUTLET AND A LIGHTING FIXTURE SHALL BE

INSTALLED NEAR THE APPLIANCE. LIGHT SWITCH SHALL BE LOCATED AT THE ENTRANCE TO THE PASSAGEWAY (MC904.10.4)

A TYPE B OR L GAS VENT SHALL TERMINATE NOT LESS THAN 5 FEET ABOVE THE HIGHEST CONNECTED APPLIANCE FILLE COLLAR OR DRAFT HOOD, (MC802 6.2.1)

G. APPLIANCE INSTALLATION SHALL MEET ALL LISTED CLEARANCES. (MC303.2)
CLOTHES DRYER MOISTURE EXHAUST DUCT SHALL TERMINATE ON THE OUTSIDE OF THE

AND SHALL BE EQUIPPED WITH A BACK-DRAFT DAMPER. SCREENS SHALL NOT BE USED AND THE

EXHAUST DUCT MAY NOT EXTEND INTO OR THROUGH DUCTS AND PLENUMS. (MC504.3) CLOTHES DRYER MOISTURE EXHAUST DUCT SHALL BE 4 INCHES IN DIAMETER AND LENGTH IS LIMITED TO 14 FEET WITH TWO ELBOWS FROM THE CLOTHES DRYER TO POINT OF

DUCT LENGTH SHALL BE REDUCED BY 2 FEET FOR EVERY ELBOW IN EXCESS OF TWO. HEATING APPLIANCES (WATER HEATER, FURNACE, ETC.) LOCATED IN THE GARAGE, WHICH

GLOW, SPARK OR FLAME, SHALL BE INSTALLED AT LEAST 18 INCHES ABOVE THE FLOOR. (MC308.1)

DUCTS SHALL BE SIZED PER CHAPTER 6 OF THE MECHANICAL CODE

THE EFFECTIVE FLUSH VOLUME OF ALL WATER CLOSETS SHALL NOT EXCEED 1.28 GPF. URINALS SHALL

BE 0.5 GPF MAXIMUM. (GC4.303.1.1) SINGLE SHOWER HEADS SHALL HAVE A MAXIMUM FLOW RATE OR 2.0GPM AT 80PSI. MULTIPLE SHOWERHEADS SERVING ONE SHOWER SHALL HAVE A COMBINED FLOW RATE OF 2.0GPM AT

OR THE SHOWER SHALL BE DESIGNED TO ALLOW ONLY ONE SHOWER OUTLET TO BE IN OPERATION

AT A TIME. (GC4.303.1.3)

LAVATORY FAUCETS SHALL NOT EXCEED 1.5GPM AT 60PSI. THE MINIMUM FLOW RATE SHALL

KITCHEN FAUCETS SHALL NOT EXCEED 1.8GPM AT 60PSI. THE FAUCET MAY TEMPORARILY

TO ABOVE THIS RATE, BUT NOT TO EXCEED 2.2GPM AT 60PSI, AND MUST DEFAULT TO THE MAXIMUM

FLOW RATE OF 1.8GPM AT 60PS. (GC4.303.1.4)

ABS AND PVC DWV PIPING INSTALLATIONS ARE LIMITED TO NOT MORE THAN TWO STORIES OF AREAS (PC701 1/2))

ALL SHOWERS AND TUB-SHOWERS SHALL HAVE A PRESSURE BALANCE, THERMOSTATIC MIXING VALVE

OR A COMBINATION PRESSURE BALANCE/THERMOSTATIC MIXING TYPE VALVE, (PC418)

14. ALL NEW, REPLACEMENT AND EXISTING WATER HEATERS SHALL BE STRAPPED TO THE WALL IN

MANDANTORY PLUMBING FIXTURE UPGRADE

SENATE BILL 407 REQUIRES WATER CONSERVING FIXTURES BE INSTALLED IN ALL RESIDENTIAL AND COMMERCIAL BUILDINGS CONSTRUCTED PRIOR TO JANUARY 1, 1994

SENATE BILL 407 ALSO REQUIRES EFFECTIVE JANUARY 1, 2014, THAT AS A CONDITION OF FINAL PERMIT SENATE BILL 407 ALSO REQUIRES EFFECTIVE JANUARY 1, 2014, THAT AS A CONDITION OF FINAL PER APPROVAL BY BUILDING AND SAFETY THE PERMIT APPLICANT SHALL REPLACE ALL NON-COMPLIANT PLUMBING FIXTURES WITH WATER-CONSERVING PLUMBING FIXTURES.

NON-COMPLIANT PLUMBING FIXTURES AS DEFINED AS: ANY TOILET MANUFACTURED TO USE MORE THAN 1.6 GALLONS PER FLUSH ANY URINAL MANUFACTURED TO USE MORE THAN 1.0 GALLONS PER FLUSH ANY SHOWERHEAD MANUFACTURED TO FLOW MORE THAN 2.5 GALLONS/MINUTE

ANY INTERIOR FAUCET MANUFACTURED TO FLOW MORE THAN 2.2 GALLONS/MINUTE TENANT IMPROVEMENTS/MULTI-FAMILY REMODELS FOR WORK THAT DOES NOT INCLUDE RESTROOMS. BATHROOMS, KITCHENS OR BREAK-ROOMS WITH A VALUATION LESS THAN \$150,000 ARE EXEMPT CERTAIN TYPES OF REPAIR WORK, SUCH AS RE-ROOFS, ARE EXEMPT. REGISTERED HISTORICAL BUILDINGS ARE EXEMPT

GLENDALE FIRE DEPARTMENT NOTES:

ADDRESS NUMBERS: APPROVED ADDRESS NUMBERS BUILDING NUMBERS OR APPROVED BUILDING IDENTIFICATION SHALL BE PLACED IN A POSITION THAT IS PLAINLY LEGIBLE AND VISIBLE FROM THE STREET, ROAD, ALLEY, AND WALKWAYS GIVING THAT IS PLAINT TEGISLE AND VISIBLE FROM THE STREET, ROAD, ALLEY, AND WALKWAYS GIVING ACCESS TO AND WITHIN THE PROPERTY. THESE NUMBERS SHALL CONTRAST WITH THEIR BACKGROUND. ADDRESS NUMBERS SHALL BE ARABIC NUMERALS OR ALPHABET LETTERS. NUMBERS SHALL BE A MINIMUM OF SIX (6) INCHES (152 MM) HIGH WITH A MINIMUM STROKE WIDTH OF 0.5 INCH (12.7 MM) AND SHALL BE ILLUMINATED IN AN APPROVED MANNER (IF NUMBERS ARE ON THE EXTERIOR). NUMBER HEIGHT AND STROKE WIDTH SHALL BE INCREASED AS NEEDED FOR LEGIBILITY BASED ON VISIBILITY

(FOR NEW STRUCTURES AND ADDITIONS/REMODELS 50% VALUATION OR GREATER. (REQUIRED) FIRE SPRINKLERS: PROVIDE A COMPLETE AUTOMATIC FIRE SPRINKLER SYSTEM THROUGHOUT THE STRUCTURE INSTALLED IN ACCORDANCE WITH THE RECOMMENDATIONS OF NFPA 13D AND THE REQUIREMENTS OF THE GLENDALE FIRE DEPARTMENT. FIRE SPRINKLER PLANS SHALL BE SUBMITTED WITHIN 30 DAYS OF ISSUANCE OF THE BUILDING PERMIT.

SMOKE DETECTORS: SMOKE DETECTORS SHALL BE WIRED TO THE BUILDING FLECTRICAL SYSTEM, BE EQUIPPED WITH BATTERY BACKUP, AND EMIT A SIGNAL WHEN BATTERIES ARE LOW.

SMOKE ALARMS SHALL BE INTERCONNECTED, SO THAT THE ACTIVATION OF ONE ALARM WILL ACTIVATE ALL OTHER SMOKE DETECTORS

CARBON MONOXIDE: DETECTORS: SHALL BE INSTALLED OUTSIDE OF EACH SEPARATE DWELLING UNIT SLEEPING AREA IN THE IMMEDIATE VICINITY OF THE BEDROOM(S) AND ON EVERY LEVEL OF A DWELLING UNIT INCLUDING BASEMENTS. ALARMS SHALL BE HARDWIRED FROM THE BUILDING POWER SUPPLY AND EQUIPPED WITH BATTERY BACKUP, DETECTORS SHALL MEET U.L. 2034 AND/OR NFPA 720 STANDARDS. COMPLY WITH CURRENT CRC CHAPTER 3.

FIRE PERMITS: THE FOLLOWING PERMITS ARE REQUIRED FROM THE FIRE DEPARTMENT

REQUIRED GFD INSPECTIONS: FOR INSPECTIONS, CALL 818-548-4810. FIRE DEPARTMENT INSPECTIONS FOR THIS PROJECT ARE

FIRE SPRINKLER OVERHEAD/UNDERGROUND ROUGH AND FLUSH (BEFORE COVERING ANY

FIRE SPRINKLER FINAL.
FIRE PREVENTION BUREAU FINAL (ADDRESS SIGNS, EGRESS FIRE DEPARTMENT ACCESS, SMOKE DETECTORS, FUEL MODIFICATION, ETC.).

FINISH MATERIAL POLLUTANT CONTROL:

ADHESIVES, SEALANTS AND CAULKS SHALL MEET OR EXCEED THE STANDARD OUTLINED IN SECTION 4.504.2.1 AND COMPLY WITH THE VOC LIMITS IN TABLES 4.504.1 AND 4.504.2 AS APPLICABLE. (4.504.2.1) PAINTS AND COATINGS SHALL MEET OR EXCEED THE STANDARDS OUTLINED IN SECTION 4.504.2.2

AEROSOL PAINTS AND COATING SHALL MEET OR EXCEED THE STANDARDS OUTLINED IN SECTION

4.504.2.3 A MINIMUM OF 80% OF FLOOR AREA RECEIVING RESILIENT FLOORING SHALL COMPLY WITH ONE OR

MORE OF THE FOLLOWING OF THE FOLLOWING: I. VOC EMISSION LIMITS DEFINED IN THE CHPS HIGH PERFORMANCE PRODUCTS DATABASE OR II. PRODUCTS COMPLIANT WITH CHPS CRITERIA UNDER THE GREENGUARD CHILDREN &

SCHOOLS PROGRAM OR

iii. CERTIFICATION UNDER THE RFCI FLOORSCORE PROGRAM OR

iv. MEET THE CALIFORNIA DEPARTMENT OF PUBLIC HEALTH STANDARD METHOD FOR THE

TESTING OF VOC EMISSIONS (SPECIFICATION 01350) (4.504.4)
COMPOSITE WOOD PRODUCTS (HARDWOOD PLYWOOD, PARTICLE BOARD, AND MDF) INSTALLED ON THE INTERIOR OF EXTERIOR OF THE BUILDING SHALL MEET OR EXCEED THE STANDARDS OUTLINED IN 4.504.5. VERIFICATION OF COMPLIANCE WITH THESE SECTIONS MUST BE PROVIDED AT THE INSPECTION, (4,504.5)

ADDITIONAL NOTES:

APPLICATIONS FOR WHICH NO PERMIT IS ISSUED WITHIN ONE (1) YEAR FOLLOWING THE DATE OF APPLICATION SHALL AUTOMATICALLY EXPIRE. (R105.3.2 CRC)
EVERY PERMIT ISSUED SHALL BECOME INVALID UNLESS WORK AUTHORIZED IS COMMENCED WITHIN

180 DAYS OR IF THE WORK AUTHORIZED IS SUSPENDED OR ABANDON FOR A PERIOD OF 180 DAYS. A SUCCESSFUL INSPECTION MUST BE OBTAINED WITHIN 180 DAYS. A PERMIT MAY BE EXTENDED IF A WRITTEN REQUEST STATING JUSTIFICATION FOR EXTENSION AND AN EXTENSION FEE IS RECEIVED

PRIOR TO EXPIRATION OF THE PERMIT AND GRANTED BY THE BUILDING OFFICIAL.

3. FIRE SPRINKLER PLANS STAMPED APPROVED BY THE CITY OF GLENDALE'S FIRE DEPARTMENT SHALL BE PROVIDED AT "HE SITE AT TIME OF FRAMING INSPECTION."

REVISE DATES:


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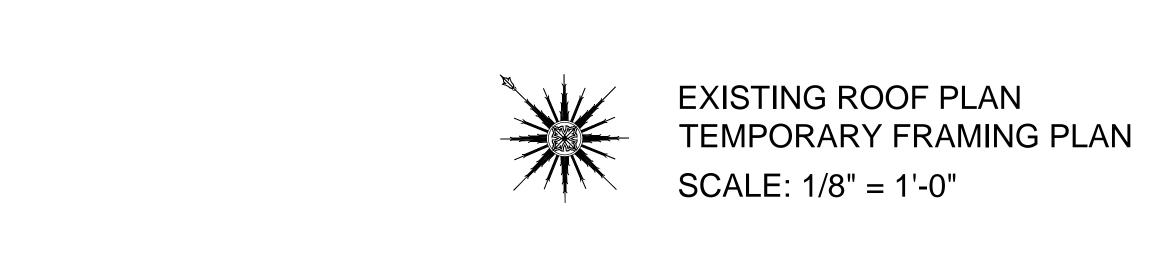
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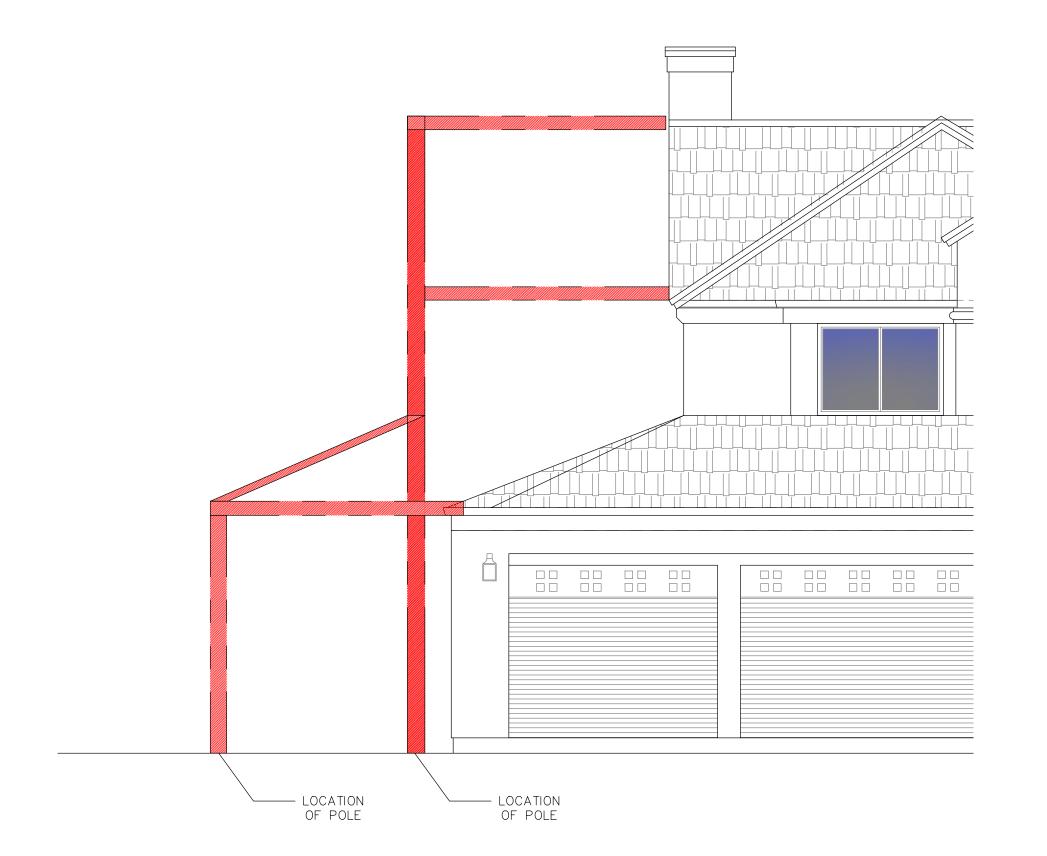


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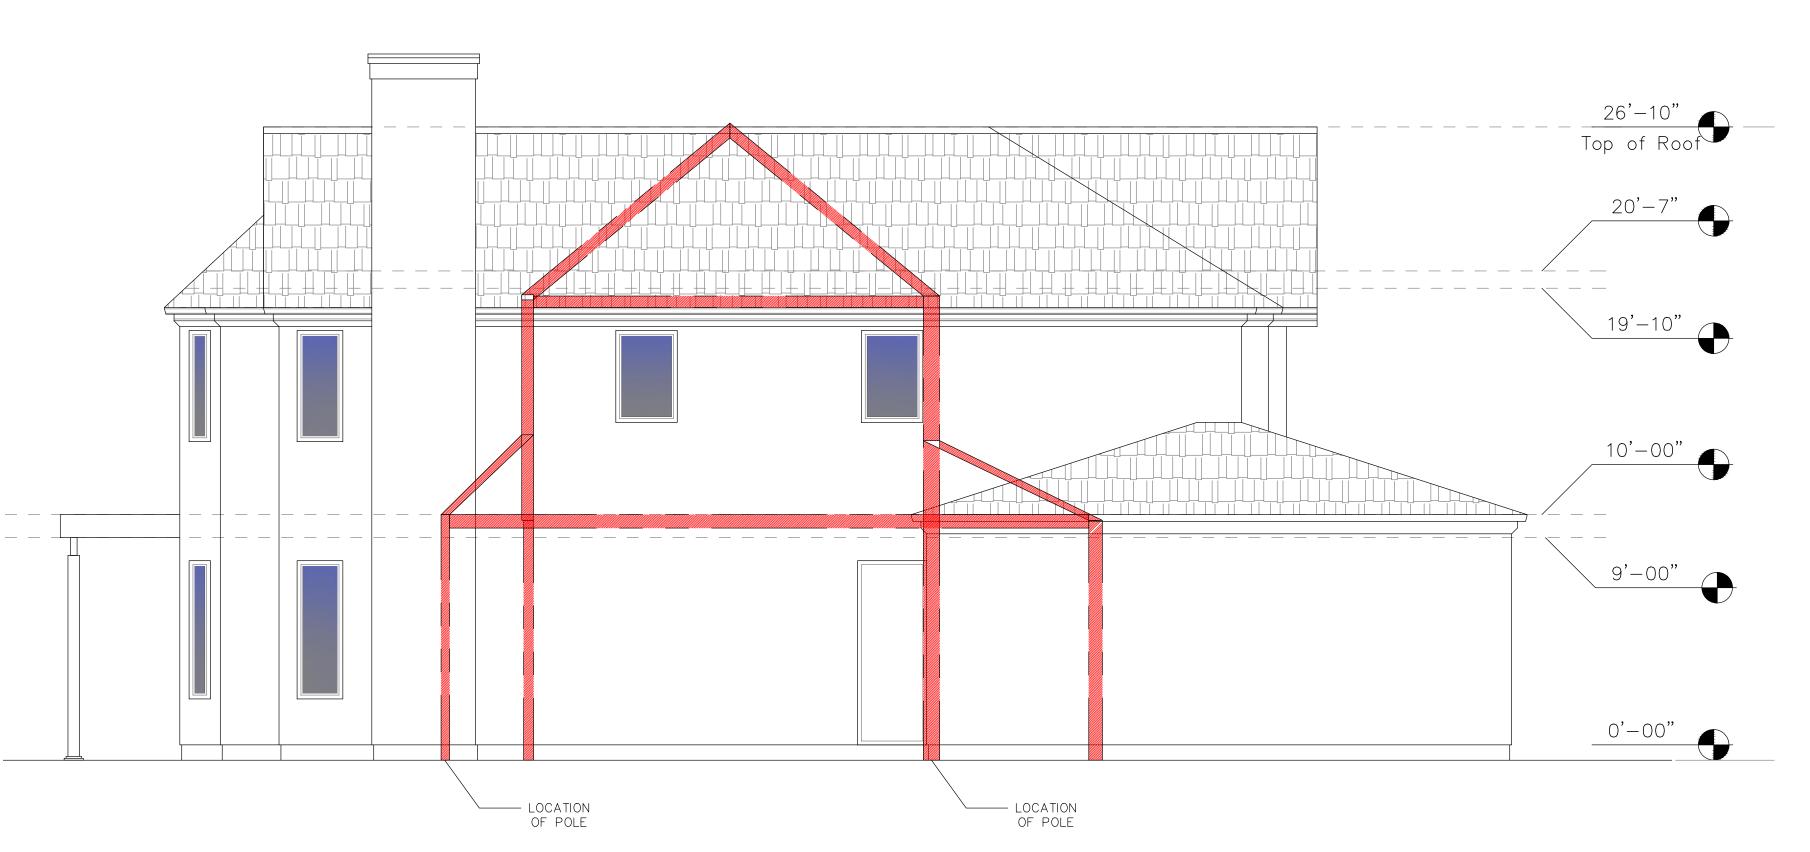
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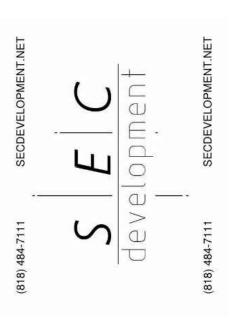
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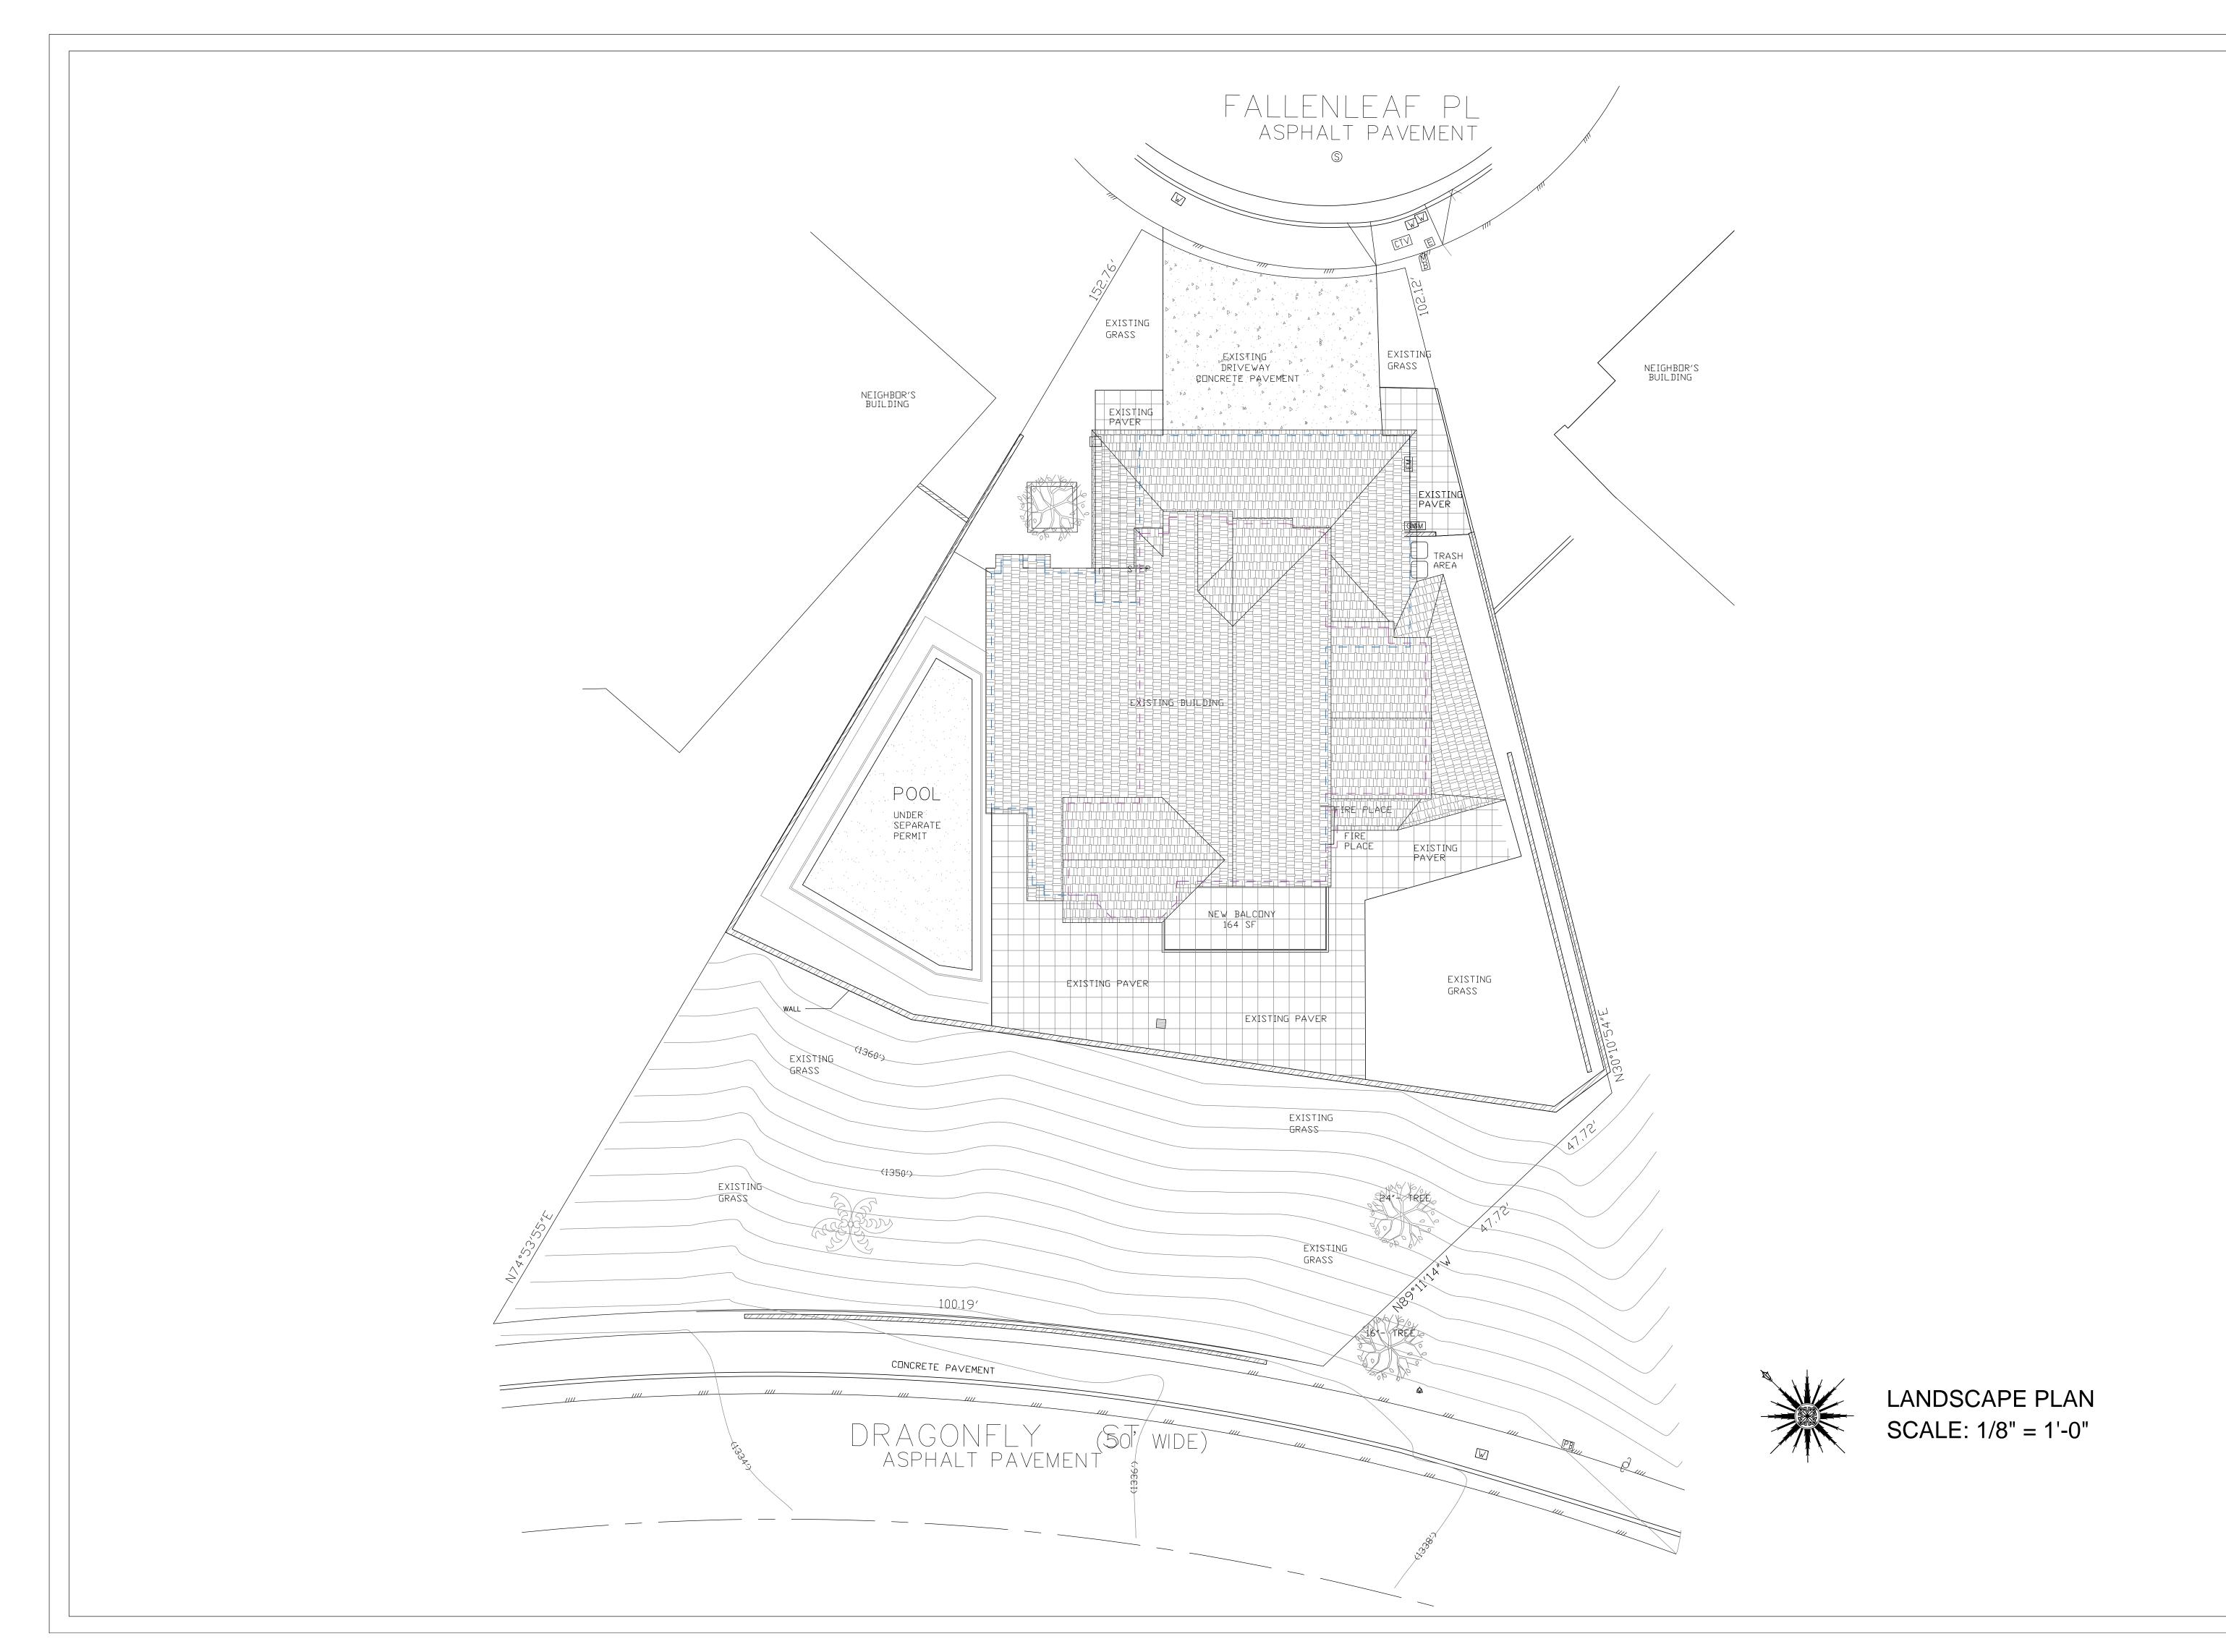
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| PROJECT INFO | | | | | | | | |
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| JOB NUMBER: | | | | | | | | |
| DATE DRAWN: | 4/29/23 | | | | | | | |
| DRAWN BY: | F.P. | | | | | | | |
| CHECKED BY: | S.B. | | | | | | | |
| SCALE: | | | | | | | | |
| A-1 | 6 | | | | | | | |



CONTRACTOR TO VERIFY ALL
DIMENSIONS, CONDITIONS, ETC.,
PERTAINING TO THE WORK AT THE
SITE BEFORE PROCEEDING WITH

THE WORK
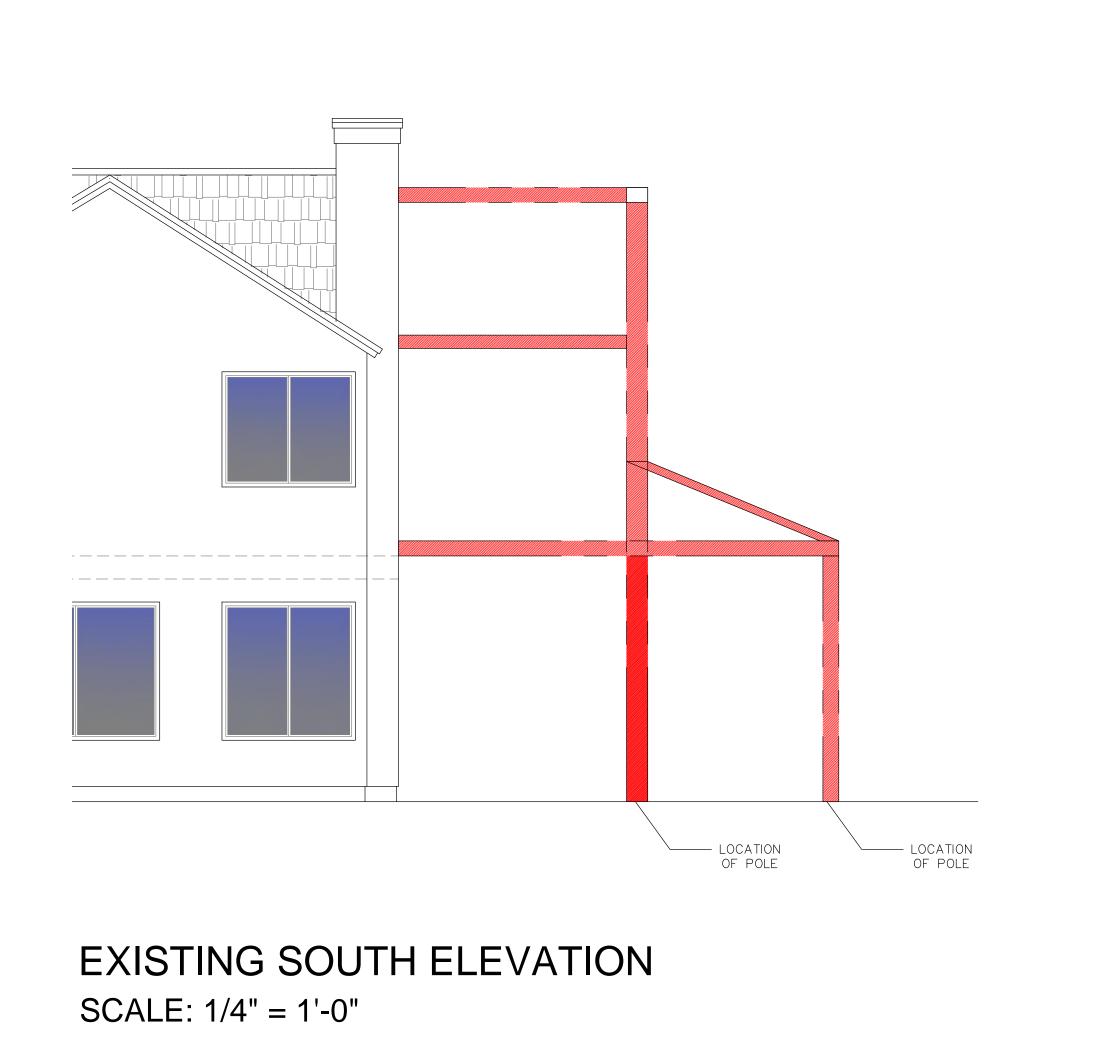
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ADDRESS: 3501 FALLENLEAF PL, GLENDALE, CA 91206


LANDSCAPE PLAN






| PROJECT INFO | | | | | | |
|--------------|--|--|--|--|--|--|
| | | | | | | |
| 4/29/23 | | | | | | |
| F.P. | | | | | | |
| S.B. | | | | | | |
| | | | | | | |
| | | | | | | |
| | | | | | | |



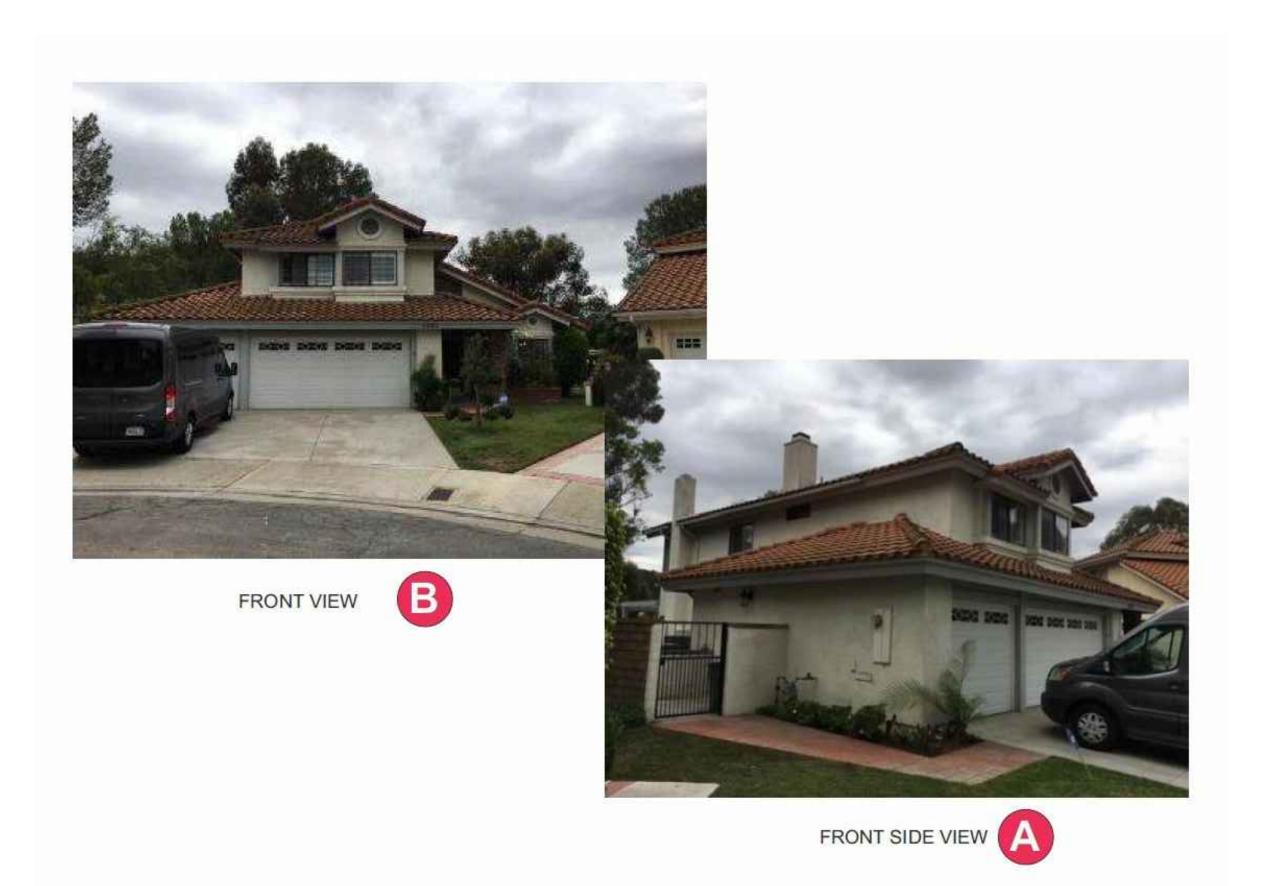



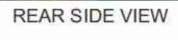



3501 Fallenleaf Place, Glendale, CA 91206



REAR SIDE CORNER

3501 Fallenleaf Place, Glendale, CA 91206

REVISE DATES:

CONTRACTOR TO VERIFY ALL DIMENSIONS, CONDITIONS, ETC., PERTAINING TO THE WORK AT THE SITE BEFORE PROCEEDING WITH THE WORK

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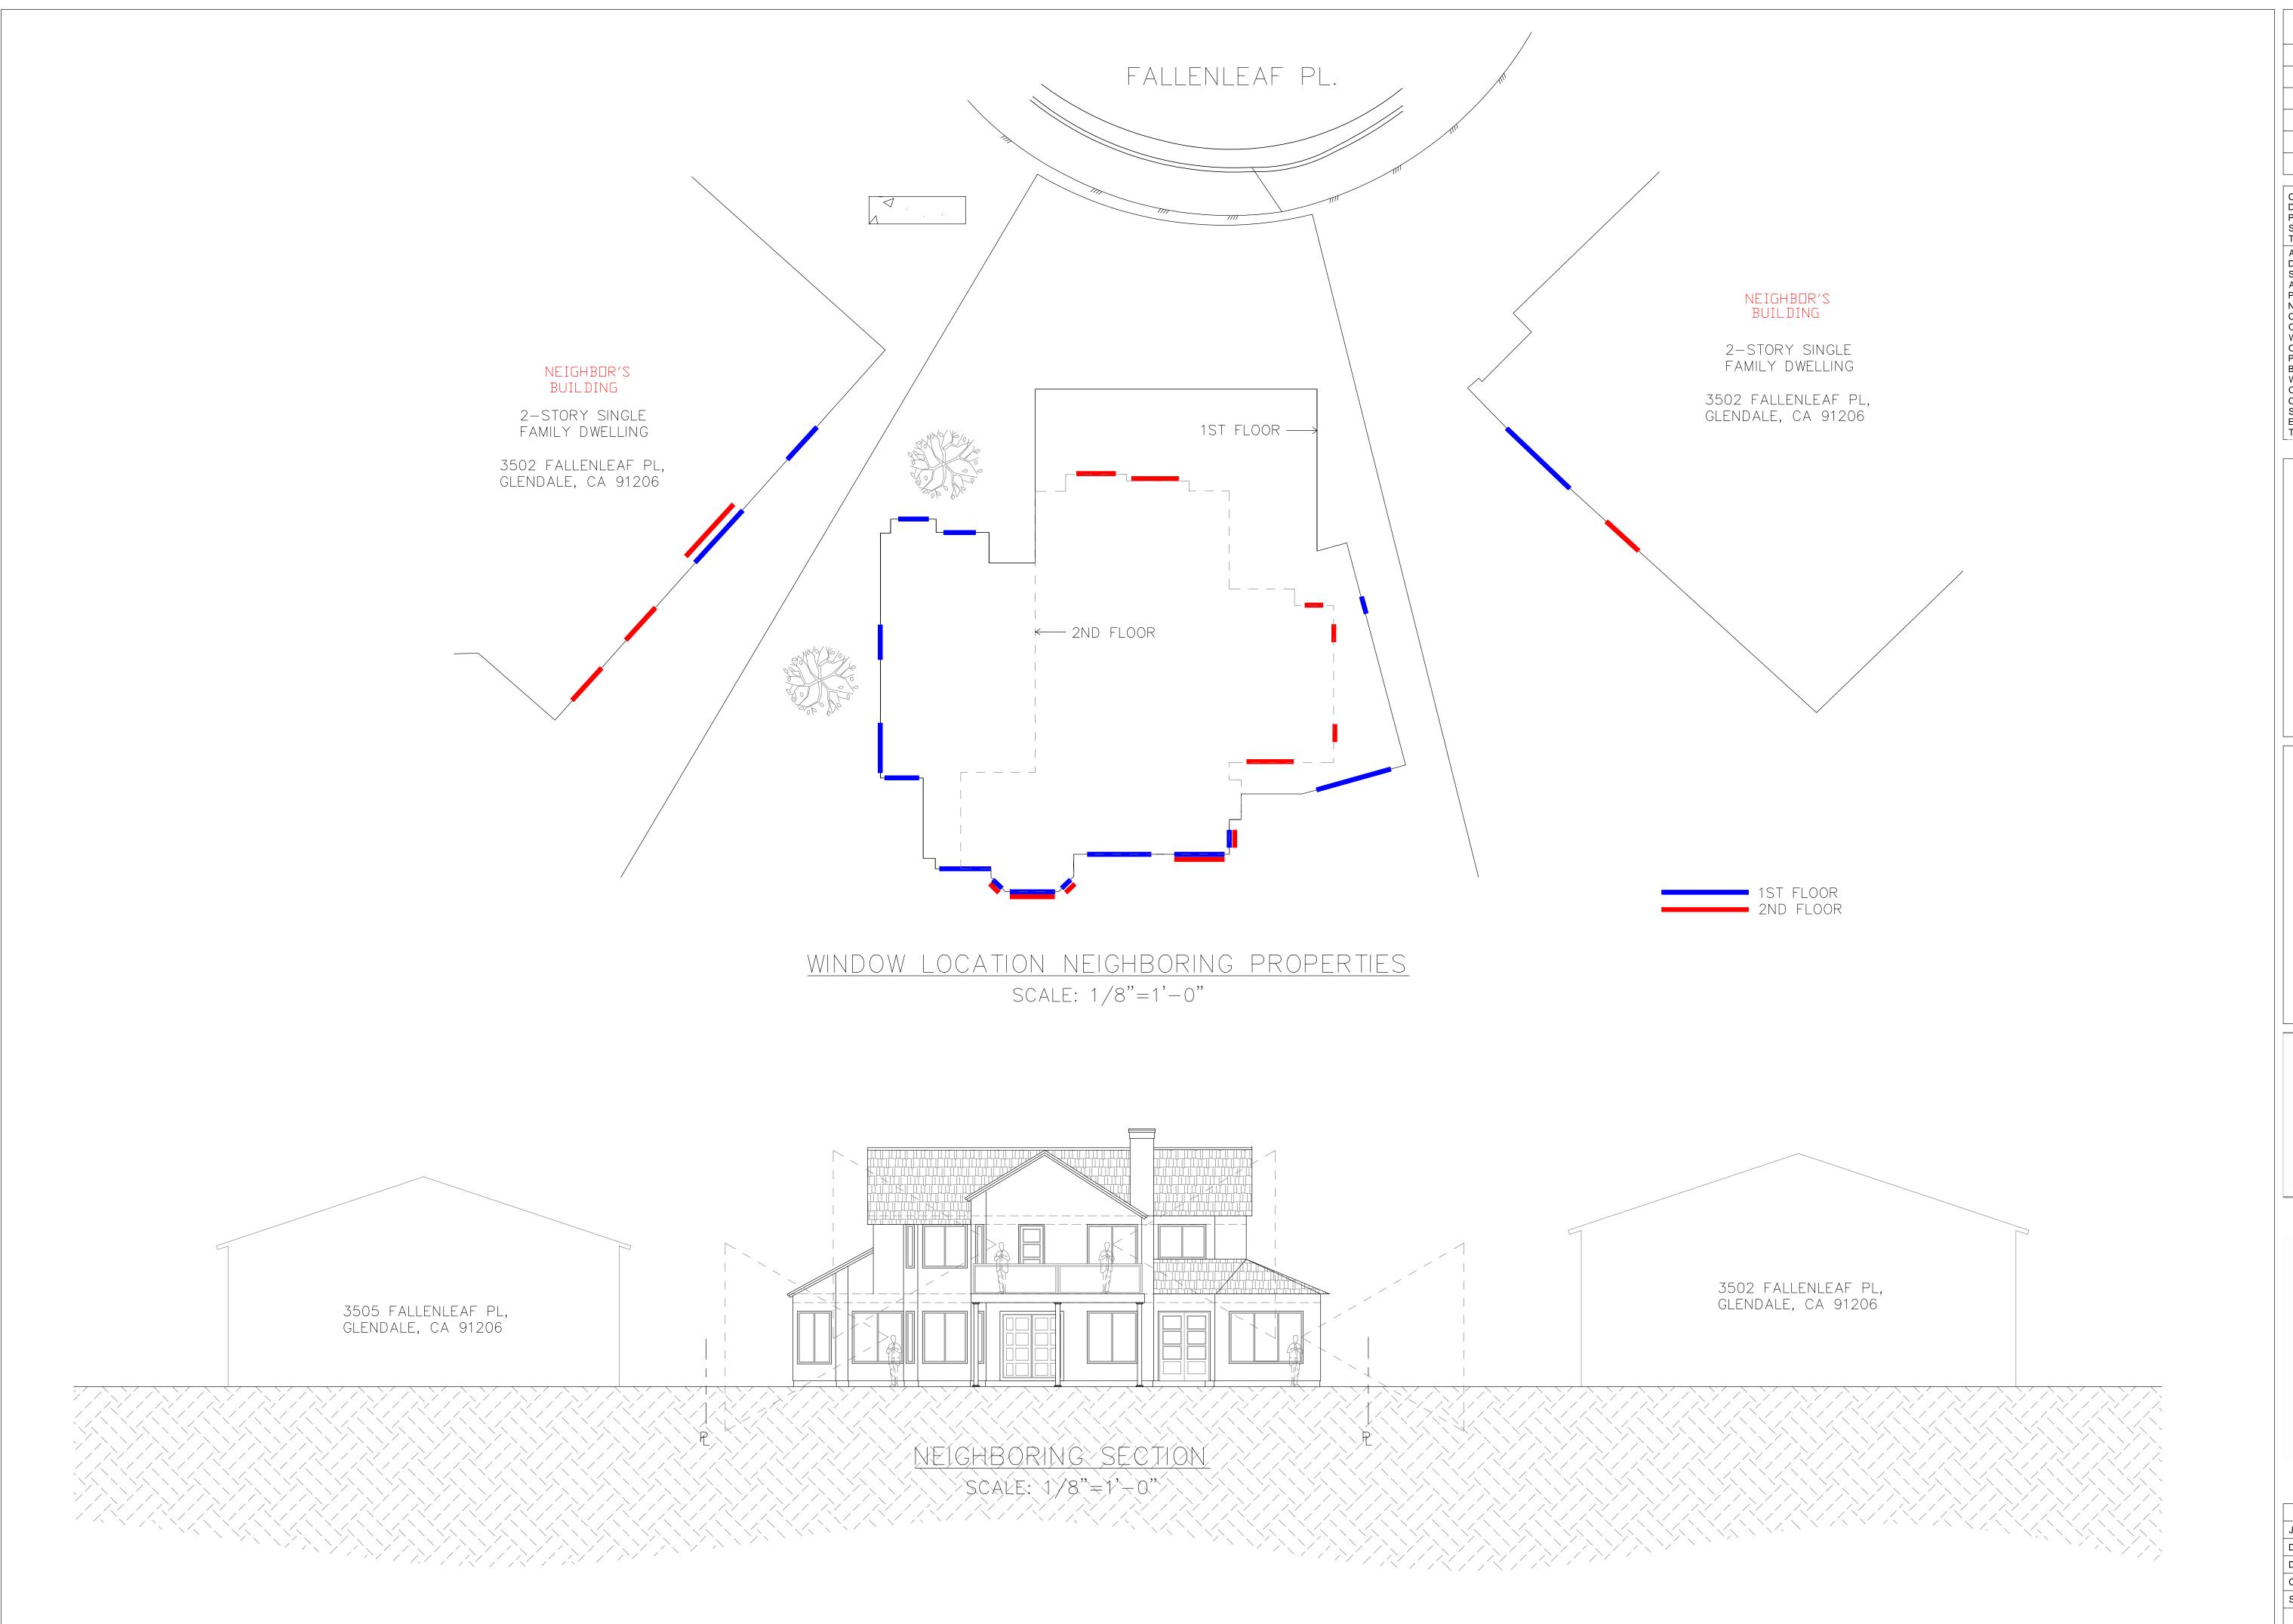
???? ADDRESS: 3501 FALLENLEAF PL, GLENDALE, CA 91206

SITE PHOTO SURVEY MAP





| PROJECT INFO | | | | | | | |
|--------------|---------|--|--|--|--|--|--|
| JOB NUMBER: | | | | | | | |
| DATE DRAWN: | 3/27/22 | | | | | | |
| DRAWN BY: | F.P. | | | | | | |
| CHECKED BY: | S.B. | | | | | | |
| SCALE: | | | | | | | |
| A-17 | | | | | | | |



CONTRACTOR TO VERIFY ALL DIMENSIONS, CONDITIONS, ETC., PERTAINING TO THE WORK AT THE SITE BEFORE PROCEEDING WITH

THE WORK

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GEGHA PETROSYAN ADDRESS: 3501 FALLENLEAF PL, GLENDALE, CA 91206

NEIGHBORING SECTION





| PROJECT INFO | | | | | | | |
|--------------|---------|--|--|--|--|--|--|
| JOB NUMBER: | | | | | | | |
| DATE DRAWN: | 4/29/23 | | | | | | |
| DRAWN BY: | F.P. | | | | | | |
| CHECKED BY: | S.B. | | | | | | |
| SCALE: | | | | | | | |
| A-18 | 8 | | | | | | |











3501 Fallenleaf Place, Glendale, CA 91206



REAR SIDE CORNER

3501 Fallenleaf Place, Glendale, CA 91206

REVISE DATES:

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ADDRESS: 3501 FALLENLEAF PL, GLENDALE, CA 91206

SITE PHOTO SURVEY MAP





| PROJECT INFO | | | | | | | |
|--------------|---------|--|--|--|--|--|--|
| JOB NUMBER: | | | | | | | |
| DATE DRAWN: | 3/27/22 | | | | | | |
| DRAWN BY: | F.P. | | | | | | |
| CHECKED BY: | S.B. | | | | | | |
| SCALE: | | | | | | | |
| A-17 | 7 | | | | | | |



SCALE: 1" = 100'

PHOTO SURVEY MAP 3501 FALLENLEAF PL GLENDALE, CA 91206 APN: 5660-035-022 300 LINEAR FEET DATE: 11-09-2021





Survey List

| Number | Address | Stories | Approx Setback (ft) | Floor Area Ratio | House Size (sf) | Lot Size (sf) |
|----------|--------------------|---------|---------------------|------------------|-----------------|---------------|
| 1 | 3527 Fallenleaf Pl | 2 | 14.2 | 0.337 | 2665 | 7906 |
| 2 | 3523 Fallenleaf Pl | 2 | 18.7 | 0.38 | 3029 | 7967 |
| 3 | 3519 Fallenleaf Pl | 2 | 18.3 | 0.311 | 2498 | 8028 |
| 4 | 3513 Fallenleaf Pl | 2 | 15.2 | 0.374 | 3029 | 8088 |
| 5 | 3509 Fallenleaf Pl | 2 | 13.6 | 0.306 | 2665 | 8720 |
| 6 | 3505 Fallenleaf Pl | 2 | 23.1 | 0.28 | 3070 | 10964 |
| 7 | 3501 Fallenleaf Pl | 2 | 16.1 | 0.28 | 2498 | 10653 |
| 8 | 3502 Fallenleaf Pl | 2 | 12.9 | 0.329 | 2585 | 7863 |
| 9 | 3508 Fallenleaf Pl | 2 | 15.2 | 0.331 | 2867 | 8653 |
| 10 | 3510 Fallenleaf Pl | 2 | 13.8 | 0.318 | 2498 | 7861 |
| 11 | 3516 Fallenleaf Pl | 1 | 10.9 | 0.278 | 2094 | 7596 |
| 12 | 3520 Fallenleaf Pl | 2 | 13.5 | 0.401 | 3047 | 7590 |
| 13 | 3526 Fallenleaf Pl | 2 | 13.6 | 0.443 | 3373 | 7619 |
| 14 | 3180 Dragonfly St | 2 | 17.4 | 0.202 | 3069 | 15166 |
| 15 | 3170 Dragonfly St | 2 | 19.6 | 0.246 | 2498 | 10155 |
| 16 | 3160 Dragonfly St | 2 | 20.6 | 0.282 | 2665 | 9454 |
| 17 | 3146 Dragonfly St | 2 | 17.1 | 0.303 | 3029 | 9996 |
| 18 | 3149 Dragonfly St | 2 | 19.5 | 0.365 | 3070 | 8420 |
| 19 | 3153 Dragonfly St | 2 | 19.4 | 0.289 | 3029 | 10493 |
| 20 | 3159 Dragonfly St | 2 | 22.1 | 0.205 | 2665 | 12988 |
| 21 | 3163 Dragonfly St | 2 | 19 | 0.195 | 3029 | 15558 |
| 22 | 3169 Dragonfly St | 2 | 18.2 | 0.238 | 3286 | 13829 |
| 23 | 3179 Dragonfly St | 2 | 19.3 | 0.251 | 2498 | 9960 |
| 24 | 3189 Dragonfly St | 1 | 19.4 | 0.191 | 2091 | 10934 |
| 25 | 3198 Dragonfly St | 2 | 31.2 | 0.076 | 2665 | 35231 |
| 26 | 3194 Dragonfly St | 2 | 20.7 | 0.145 | 3070 | 21199 |
| 27 | 3533 Pheasant St | 2 | 16.2 | 0.295 | 2498 | 8473 |
| Averages | | | 17.7 | 0.283 | 2781 | 11162 |

Photo 1 – 3527 Fallenleaf Pl



Photo 2 – 3523 Fallenleaf Pl



Photo 3 – 3519 Fallenleaf Pl



Photo 4 – 3513 Fallenleaf Pl



Photo 5 – 3509 Fallenleaf Pl



Photo 6 – 3505 Fallenleaf Pl



Photo 7 – 3501 Fallenleaf Pl



Photo 8 – 3502 Fallenleaf Pl



Photo 9 – 3508 Fallenleaf Pl



Photo 10 – 3510 Fallenleaf Pl



Photo 11 – 3516 Fallenleaf Pl



Photo 12 – 3520 Fallenleaf Pl



Photo 13 – 3526 Fallenleaf Pl



Photo 14 – 3180 Dragonfly St



Photo 15 – 3170 Dragonfly St



Photo 16 – 3160 Dragonfly St



Photo 17 – 3146 Dragonfly St



Photo 18 – 3149 Dragonfly St



Photo 19 – 3153 Dragonfly St



Photo 20 – 3159 Dragonfly St



Photo 21 – 3163 Dragonfly St



Photo 22 – 3169 Dragonfly St



Photo 23 – 3179 Dragonfly St



Photo 24 – 3189 Dragonfly St



Photo 25 – 3198 Dragonfly St



Photo 26 – 3194 Dragonfly St



Photo 27 – 3533 Pheasant St

