

CITY OF GLENDALE, CA

DESIGN REVIEW STAFF REPORT - SINGLE FAMILY

November 20, 2024 926 East Dryden Street

Decision Date Address

Administrative Design Review (ADR) 5646-006-022

Review Type APN

PADR-003840-2024 Sevak Karabachian

Case Number Applicant

Eric Ji, Planning Associate Matthew Islam

Case Planner Owner

Project Summary

To demolish the unpermitted enclosed porch at the rear façade and add a new 198 square-foot (SF) one-story addition in the same locations at the existing one-story, 1,334 SF, Spanish Colonial Revival-style house. The house was built in 1924 with is located on a 6,350 SF lot zoned R1 (Floor Area District II). The property is a contributor to the Rossmoyne Historic District.

Environmental Review

The project is exempt from CEQA review as a Class 31 "Historic Restoration or Rehabilitation" pursuant to Section 15331 of the State CEQA Guidelines because the addition meets the Secretary of the Interiors Standards for the Treatment of Historic Properties.

Existing Property/Background

Originally developed in 1924, the project site is a 6,350 SF corner lot with frontage on East Dryden Street and Cordova Avenue. The site is currently developed with a 1.334 SF, one-story single-family residence with a detached two-car garage and attached permitted carport. An accessory dwelling unit, adjoining the garage, will be reviewed under a separate application.

The subject property is a contributor to the Rossmoyne Historic District (Attachment #5). The home retains many of its original character defining features and possesses high historic integrity.

Staff Recommendation

Approve

Last Date Reviewed / Decision

First time submittal for final review.

Zone: RI FAR District: II

Although this design review does not convey final zoning approval, the project has been reviewed for consistency with the applicable Codes and no inconsistencies have been identified.

Active/Pending Permits and Approvals

None.

Site Slope and Grading

None proposed.

Neighborhood Survey

	Average of Properties within 300 linear feet of subject property	Range of Properties within 300 linear feet of subject property	Subject Property Proposal
Lot size	6,956 SF	5,467 SF - 8,369 SF	6,350 SF
Setback	20'-0"	20'-0"	20'-0"
House size	1,927 SF	1,088 SF – 2,495 SF	1,532 SF
Floor Area Ratio	0.27	0.19 – 0.29	24%
Number of stories	1-story	1-story – 2-story	1-story

DESIGN ANALYSIS

Site Planning

Are the following items satisfactory and compatible with the project site and surrounding area?

Building Location ⊠ yes □ n/a □ no
 If "no" select from below and explain: □ Setbacks of buildings on site □ Prevailing setbacks on the street □ Building and decks follow topography
Garage Location and Driveway ☐ yes ☑ n/a ☐ no
If "no" select from below and explain: ☐ Predominant pattern on block ☐ Compatible with primary structure ☐ Permeable paving material
☐ Decorative paving

Landscape Design □ yes ⊠ n/a □ no
If "no" select from below and explain: ☐ Complementary to building design ☐ Maintains existing trees when possible ☐ Maximizes permeable surfaces ☐ Appropriately sized and located Walls and Fences
□ yes ⊠ n/a □ no
If "no" select from below and explain: ☐ Appropriate style/color/material ☐ Perimeter walls treated at both sides ☐ Retaining walls minimized
☐ Appropriately sized and located
Determination of Compatibility: Site Planning
The proposed site planning is appropriate, as modified by any proposed conditions, to the site and its surroundings for the following reasons:
 Overall, the site planning is appropriate and remains relatively unchanged, with the addition occupying the area of the current unpermitted enclosed patio. The proposed addition is approximately ten feet and seven inches from the street side property line facing Cordova Avenue. The addition is located behind the existing five-foot-tall concrete masonry unit (CMU) wall on the existing concrete pad. The placement of the addition is located away from the primary façade and is set in from the rear corner of the house in a manner consistent with the Historic District Design Guidelines.
Massing and Scale Are the following items satisfactory and compatible with the project site and surrounding area?
Building Relates to its Surrounding Context ⊠ yes □ n/a □ no
 If "no" select from below and explain: □ Appropriate proportions and transitions □ Relates to predominant pattern □ Impact of larger building minimized
Building Relates to Existing Topography ⊠ yes □ n/a □ no
If "no" select from below and explain: ☐ Form and profile follow topography ☐ Alteration of existing land form minimized

☐ Retaining walls terrace with slope
Consistent Architectural Concept ⊠ yes □ n/a □ no
If "no" select from below and explain: ☐ Concept governs massing and height
Scale and Proportion ⊠ yes □ n/a □ no
If "no" select from below and explain: ☐ Scale and proportion fit context ☐ Articulation avoids overbearing forms ☐ Appropriate solid/void relationships ☐ Entry and major features well located ☐ Avoids sense of monumentality
Roof Forms ⊠ yes □ n/a □ no
If "no" select from below and explain: ☐ Roof reinforces design concept ☐ Configuration appropriate to context
Determination of Compatibility: Mass and Scale
The proposed massing and scale are appropriate, as modified by any proposed conditions, to the site and its surroundings for the following reasons:
 The proposed addition is located on the rear side of the existing home facing Cordova Avenue and located away from the main façade facing Dryden Street. By maintaining the asymmetrical massing characteristic of the Spanish Colonial Revival style, the addition remains compatible in size and scale with the original structure.
 The proposed addition is lower in height and steps in from the existing house to ensure it remains subordinate to the primary volume of the house, preserving the overall architectural integrity.
Design and Detailing Are the following items satisfactory and compatible with the project site and surrounding area?
Overall Design and Detailing ⊠ yes □ n/a □ no
 If "no" select from below and explain: □ Consistent architectural concept □ Proportions appropriate to project and surrounding neighborhood □ Appropriate solid/void relationships

□ yes □ n/a □ no
 If "no" select from below and explain: ☐ Well integrated into design ☐ Avoids sense of monumentality ☐ Design provides appropriate focal point ☐ Doors appropriate to design
Windows ⊠ yes □ n/a □ no
 If "no" select from below and explain: □ Appropriate to overall design □ Placement appropriate to style □ Recessed in wall, when appropriate
Privacy ⊠ yes □ n/a □ no
If "no" select from below and explain: ☐ Consideration of views from "public" rooms and balconies/decks ☐ Avoid windows facing adjacent windows
Finish Materials and Color ⊠ yes □ n/a □ no
If "no" select from below and explain: ☐ Textures and colors reinforce design ☐ High-quality, especially facing the street ☐ Respect articulation and façade hierarchy ☐ Wrap corners and terminate appropriately
Paving Materials ☐ yes ⊠ n/a ☐ no
If "no" select from below and explain: □ Decorative material at entries/driveways □ Permeable paving when possible □ Material and color related to design
Lighting, Equipment, Trash, and Drainage ☑ yes ☐ n/a ☐ no
If "no" select from below and explain: □ Light fixtures appropriately located/avoid spillover and over-lit facades □ Light fixture design appropriate to project □ Equipment screened and well located □ Trash storage out of public view □ Downspouts appropriately located □ Vents, utility connections integrated with design, avoid primary facades

Ancillary	/ Structu	ıres	
⊠ yes	□ n/a	□ no	
If "no" se	lect from	below and explain:	
☐ Desi	ign consi	stent with primary structure	
☐ Desi	ign and n	materials of gates complement primary structure	е

Determination of Compatibility: Design and Detailing

The proposed design and detailing are appropriate, as modified by any proposed conditions, to the site and its surroundings for the following reasons:

- Overall, the addition's design and detailing are appropriate and consistent with the
 existing Spanish Colonial Revival style of the residence through the use of the same
 materials and colors.
- The unpermitted addition that is currently in place is inappropriate to the style and design of the house and the addition will improve the overall appearance of the property.
- The addition will feature a smooth finish stucco in white color and red mission clay 'S' tile roofs that matches the finish details of the Spanish Colonial Revival home.
- The new windows at the addition will be white, aluminum clad wood casement and fixed windows recessed in their openings, with external muntin grids and wood sills
- Removing the non-original jalousie and aluminum sliding windows at the existing house and replacing them with new aluminum-clad wood sash will bring these openings closer to their early appearance.
- The roof of the proposed addition will match the existing gable roof design with matching 5 ½" / 12" slope.

Glendale Historic District Design Guidelines and Rehabilitation Standards Analysis

Glendale Historic District Design Guidelines Analysis

Staff finds that the project meets the Historic District Design Guidelines for the following reasons:

Massing & Additions

- The one-story addition is set to the rear of the main volume of the house and is subordinate in size and height. To accomplish this, the eave and ridge lines of the addition will be lower than those of the main house, and the pitch of the new gabled roof form will match the main roof.
- Because of the corner lot, the addition will be clearly visible from the street in the
 context of the streetside elevation. It will be stepped in from the rear corner of the
 house, allowing the volume and roof from of the original building to remain legible and
 helping mark the addition as a later feature of the property.
- The addition will maintain the asymmetrical massing associated with the house's style and will match the existing stucco and clay tile cladding materials.

Windows & Doors

• The window patterns of the existing house will be maintained and the kitchen window of the addition that faces the street has an appropriate three-part configuration.

- The new aluminum-clad wood windows proposed for the addition and for replacing inappropriate existing windows will closely match the existing wood casement windows.
- A condition of approval is added to change the design and/or size of the window proposed at the previously altered opening at Bedroom #3, which is visible from the street, to better reflect windows traditionally found at bedroom window openings.

Secretary of the Interior's Standards for Rehabilitation Analysis

Staff believes the proposed work can comply with the Rehabilitation Standards if the recommended conditions are imposed, as follows:

- 1. A property shall be used for its historic purpose or be placed in a new use that requires minimal change to the defining characteristics of the building and its site and environment.
 - The property was developed as a single-family residence and will remain a single-family residence.
- 2. The historic character of a property shall be retained and preserved. The removal of historic materials or alteration of features and spaces that characterize a property shall be avoided.
 - The existing home contains an unpermitted patio enclosure at the western rear side
 of the home facing Cordova Avenue. The project proposes to replace this
 inappropriate structure with a new 198 SF addition. The unpermitted patio does not
 have historic materials or features that characterize the property, and the proposed
 addition will be consistent with the Spanish Colonial Revival style.
 - The project proposes to replace two louvered windows and two sliding windows with aluminum wood clad casement windows that will match the existing windows on the property.
 - The project does not propose to remove any original features or historic materials on the historic residence.
- 3. Each property shall be recognized as a physical record of its time, place, and use. Changes that create a false sense of historical development, such as adding conjectural features or architectural elements from other buildings, shall not be undertaken.
 - The addition will be a straightforward design and will read as an addition because of
 its offset from the side façade and deferral to the main volume of the front portion of
 the house. It does not add conjectural features or elements from other buildings that
 may create a false sense of historical development.
- 4. Most properties change over time; those changes that have acquired historic significance in their own right shall be retained and preserved.
 - Standard 4 is not applicable to this project because the unpermitted covered patio
 has not acquired historic significance in its own right and does not contribute to the
 overall historic character of the property.
- 5. Distinctive features, finishes, and construction techniques or examples of craftsmanship that characterize a property shall be preserved.
 - Staff believes that the property's character-defining features will be retained at a level that allows for ongoing contributing status of the historic district.
- 6. Deteriorated historic features shall be repaired rather than replaced. Where the severity of deterioration requires replacement of a distinctive feature, the new feature shall match

the old in design, color, texture, and other visual qualities and, where possible, materials. Replacement of missing features shall be substantiated by documentary, physical, or pictorial evidence.

- Two existing louvered metal windows and two sliding metal windows are not historic features and will be replaced with new aluminum clad wood casement windows that are consistent and compatible with the original wood casement windows.
- 7. Chemical or physical treatments, such as sandblasting, that cause damage to historic materials shall not be used. The surface cleaning of structures, if appropriate, shall be undertaken using the gentlest means possible.
 - Not applicable.
- 8. Significant archeological resources affected by a project shall be protected and preserved. If such resources must be disturbed, mitigation measures shall be undertaken.
 - Not applicable.
- 9. New additions, exterior alterations, or related new construction shall not destroy historic materials that characterize the property. The new work shall be differentiated from the old and shall be compatible with the massing, size, scale, and architectural features to protect the historic integrity of the property and its environment.
 - The construction of the one-story addition will not result in the loss or destruction of any character-defining features or materials that characterize the property. While the proposed addition will be visible from the street side along Cordova Avenue, it will be subordinate in massing and size, and it will not impact the front elevation of the property along East Dryden Street.
 - The offset of the addition from the west will allow the original corners of the house to remain exposed and will help differentiate the addition from the original portion of the house.
- 10. New additions and adjacent or related new construction shall be undertaken in such a manner that if removed in the future, the essential form and integrity of the historic property and its environment would be unimpaired.
 - If the addition were removed in the future, the single-family residence could be returned to its original size and footprint through the reconstruction of the rear wall without impacting the form and integrity of the original property.

Recommendation / Draft Record of Decision

Based on the above analysis, staff recommends **Approval with Conditions**. **Conditions**

1. Revise the design of the street-facing window at Bedroom #3 to better reflect the vertical orientation found at the original window openings. This could be accomplished by using two pairs of casement windows with horizontal muntins/grilles to match the other windows on the house.

Attachments

- 1. Reduced Plans
- 2. Photos of Existing Property
- 3. Location Map
- 4. Neighborhood Survey
- 5. DPR Survey Form





OUEST			
SHEET NUMBER	SHEET NAME	CURRENT REVISION	
NOMBLIX	OHELI WAWE	CONNEIVI NEVISION	
A0-100	PROJECT INFORMATION		
A0-200	GENERAL NOTES		
A0-201	ENERGY CALCULATIONS ADDITION		
A0-202	ENERGY CALCULATIONS ADDITION		
A0-205	3D VIEWS		
A0-300	MATERIAL LEGEND		
A0-301	WINDOW REPLACEMENT FORM		
A1-101	SITE PLAN		
A2-101	DEMO PLAN		
A2-102	DEMO PLAN		
A2-103	(N) MAIN HOUSE FLOOR PLAN		
A3-101	EXISTING ELEVATIONS		
A3-102	MAIN HOUSE NEW ELEVATIONS		
A3-103	EXISTING GARAGE ELEVATIONS		
A3-105	BUILDING SECTIONS		
A4-301	GLAZING DETAIL		
A4-311	PLASTER DETAILS		
A4-331	ROOF DETAILS		
A4-332	ROOF DETAIS		
A6-101	MAIN HOUSE RCP		
A6-301	PARTITION NOTES		
A6-302	PARTITION TYPE/DETAILS		
A6-303	PARTITION BASE DETAILS		
A6-401	WINDOW SCHEDULES		
A6-402	DOOR SCHEDULES		
A6-501	INTERIOR ELEVATIONS		
A6-603	WATERPROOFING DETAILS		
A6-801	EXTERIOR DOOR DETAILS		
A7-101	MAIN HOUSE ELECTRICAL PLAN		
S-0	GENERAL NOTES		
S-0.1	GENERAL NOTES		
S-1	MAIN HOUSE FRAMING & FOUNDATION PLAN		
S-2	ADU HOUSE FRAMING & FOUNDATION PLAN		
SD-1	FOUNDATION DETAILS		
SD-1.1	FOUNDATION DETAILS		
SD-2	FRAMING DETAILS		
SD-2.1	FRAMING DETAILS		

PROJECT NOTES:

ELECTRIC APPLIANCE" IN COMPLIANCE THE CITY OF GLENDALE REACH CODE ORDINANCE NO. 5999

MAXIMUM F.A.R:	2,540 S
EXISTING F.A.R:	1,334 S
PROPOSE F.A.R:	1,532 S
MAXIMUM LOT COVERAGE:	2,540 S
EXISTING LOT COVERAGE:	2,306 S
PROPOSED LOT COVERAGE:	1,936 S
((E) GARAGE CONVERTED TO ADU)	(-370 S
MINIMUM REQUIRED LANDSCAPING:	2,540 S
EXISTING LANDSCAPE:	2,673 S
PROPOSED LANDSCAPE:	-133 SF
GRAND TOTAL LANDSCAPE:	2,556 S

1. ALL NEWLY CONSTRUCTED ADU'S SHALL BE AN "ALL

MAXIMUM F.A.R: EXISTING F.A.R:	2,540 SF 1,334 SF
PROPOSE F.A.R:	1,532 SF
MAXIMUM LOT COVERAGE: EXISTING LOT COVERAGE: PROPOSED LOT COVERAGE: ((E) GARAGE CONVERTED TO ADU)	2,540 SF 2,306 SF 1,936 SF (-370 SF)
MINIMUM REQUIRED LANDSCAPING: EXISTING LANDSCAPE: PROPOSED LANDSCAPE: GRAND TOTAL LANDSCAPE:	2,540 SF 2,673 SF -133 SF 2,556 SF

ISLAM RESIDENCE

926 E DRYDEN ST. GLENDALE, CA 91207

ADDITION & REMODEL

CONSTRUCTION DOCUMENT SET

PROJECT INFORMATION

MATTHEW ISLAM OWNER NAME: 2. PROJECT ADDRESS: 926 E DRYDEN ST GLENDALE, CA 91207 3. LEGAL DESCRIPTION: ROSSMOYNE LOT 22 BLK 10 4. NO. DWELLING UNITS: 1 UNITS PLUS 1 ADU (SEPERATE PERMIT) TYPE OF CONSTRUCTION: TYPE V-B

6. OCCUPANCY: RESIDENTIAL 7. PARCEL NUMBER: 5646-006-022 8. PRIMARY ZONING: R1 II HD 9. OVERLAY DISTRICT: ROSSMOYNE HISTORIC DISTRICT 10. NO. OF STORIES:

11. SITE DIMENSIONS: 110.46 SF X 50 SF 12. SITE AREA: 6,350 SF 13. EXISTING BLD SIZE: (SFR) 1334 SF, (GARAGE) 203 SF, (PATIO) 198 SF,

(CARPORT) 404 SF 14. EXISTING PROGRAM: SINGLE FAMILY RESIDENCE 15. ACCESSORY STR. PROPOSED: (N) 740 SF ADU

16. TOTAL NEW BLD AREA: 1,532 SF + 740 SF ADU (SEPERATE PERMIT) 17. TOTAL LOT COVERAGE: 1,738 SF (E) NO, (N) NO 18. FIRE SPRINKLERS: 19. DESCRIPTION OF USES: (E) SFD, (N) FR SFR 14'-10 1/2", ADU 12'-11" (SEPERATE PERMIT)

20. HEIGHT: 21. CLIMATE ZONE: 22. YEAR (E) GARAGE BUILT: 23. WUI AREA: 24. GUSD AREA: GLENDALE 25. JURISDICTION:

SCOPE OF WORK

PERMITING OF EXISTING ENCLOSED 198 SF PATIO ADDITION. SFR INTERIOR REMODEL OF KITCHEN AND BEDROOM, 1 FULL BATHROOM, AND 1/2 BATHROOM.

APPLICABLE CODES

2023 GLENDALE BUILDING & SAFETY CODE (GBC) GLENDALE BUILDING & SAFETY REACH CODE (GRC) 2022 CALIFORNIA BUILDING CODE (CBC) 2022 CALIFORNIA RESIDENTIAL CODE (CRC) 2022 CALIFORNIA ELECTRICAL CODE (CEC) 2022 CALIFORNIA PLUMBING CODE (CPC) 2022 CALIFORNIA MECHANICAL CODE (CMC) 2022 CALIFORNIA FIRE CODE (CFC) 2022 CALIFORNIA ENERGY CODE (CENC) 2022 CALIFORNIA GREEN BUILDING CODE (CGBS)

FRONT SETBACK REQUIREMENT

SIDE SETBACK REQUIREMENT

6' (30.11-B)

25' (30.11-B)

REAR SETBACK REQUIREMENT **6'** (30.11-B)

HEIGHT REQUIREMENT

25' TO TOP PLATE & 32' TO THE HIGHEST RIDGE LINE (17.22.070)**ENCROACHMENT PLANE**

SIDE SETBACK ENCROACHMENT PLANE SLOPING UPWARD AND INWARD

TO THE SITE AT A 30-DEGREE ANGLE MEASURED FROM THE VERTICAL, COMMENCING 6' ABOVE THE EXISTING GRADE ALONG THE INTERIOR SIDE PROPERTY LINE. AB (17.40.160D)

LOT COVERAGE ALLOWED **2,540 SF** (40% OF LOT AREA, INCLUDES ALL ROOFED

STRUCTURE) (30.11-B)

DISTRICT II: 0.40 FOR THE 1ST 10,000 SQ. FT. OF LOT AREA AND 0.10 FOR THE PORTION OF LOT AREA THEREAFTER

2 CAR FOR MAIN HOUSE (30.52

40% MIN. OF LOT AREA (30.31)

DATE

KARABACHIAN

SEVAK KARABACHIAN, RA

3234 1/2 FOOTHILL BLVD

OFFICE: 818-330-9093

CA LICENSE: C-38632

MATTHEW ISLAM

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GLENDALE CA, 91207

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ARCHITECT

ARCHITECTS, INC.



926 E DRYDEN STREET GLENDALE, CALIFORNIA 91207

ADDITION AND REMODEL

PROJECT INFORMATION

PERMIT #: BSFD-018869-2024

PLANNING #: PMPA-003557-2024

ORIGINAL SHEET SIZE: 24" x 36"

PROJECT: 2024-008

As indicated

10/23/2024

A0-100



	BBREVIATIONS		
3D	THREE DIMENSIONAL	L	LENGTH
		LAM	LAMINATE
AD	AREA DRAIN	LAV	LAVATORY
AFF	ABOVE FINISH FLOOR	LAV	LEADER DRAIN
ALT	ALTERNATE	LF	LINEAR FOOT
ALUM	ALUMINUM		
ANG	AVERAGE NATURAL GRADE	LL	LIVE LOAD
AP	ACCESS PANEL		
APPROX	APPROXIMATE	MAX	MAXIMUM
		MECH	MECHANICAL
ARCH	ARCHITECTURAL	MFR	MANUFACTURER
AV	AUDIO VIDUAL	MIN	MINIMUM
		MIR	MIRROR
BLDG	BUILDING		
ВО	BOTTOM OF	N	NORTH
		NO	NUMBER
СВ	CATCH BASIN	NTS	NOT TO SCALE
CBC	CALIFORNIA BUILDING CODE		
CJ	CONTROL JOINT	OC	ON CENTER
CL	CENTER LINE	OD	OUTSIDE DIAMETER (DIM)
CLG	CEILING	OFD	OVERFLOW DRAIN
CLR	CLEAR	OPP	OPPOSITE
CMU	CONCRETE MASONRY UNITS		
CO	CLEAN OUT	PCF	POUNDS PER CUBIC FOOT
COL	COLUMN	PERF	PERFORATE(D)
CONC	CONCRETE	PL	PLATE
		PLUM	PLUMBING
CONT	CONTINUOUS	PSF	POUNDS PER SQUARE FOOT
CPT	CARPET	PSI	POUNDS PER SQUARE INCH
CT	CERAMIC TILE	PTN	PARTITION
CU	CONDENSER UNIT	PTN PTD.	PAINTED
CW	COLD WATER		
		PVC	POLYVINYL CHOLORIDE
DTL	DETAIL	PWD	PLYWOOD
DIA	DIAMETER	R	RADIUS
DIAG	DIAGONAL	RCP	REFLECTED CEILING PLAN
		RD REF	ROOF DRAIN REFERENCE
DF	DOUGLAS FIR	REV	REVISION
DN	DOWN	RM	ROOM
DR	DOOR	RO	ROUGH OPENING
DS	DOWNSPOUT		
DWG	DRAWING	S	SOUTH
		SD	STORM DRAIN
E	EAST	SEC	SECURITY
		SCHED	SCHEDULE
EA = a	EACH	SECT	SECTION
EC	EXPOSED CONSTRUCTION	SF	SQUARE FEET
EJ	EXPANSION JOINT	SHTG	SHEATHING
EL	ELEVATION	SIM	SIMILAR
ELEC	ELECTRICAL	SPEC	SPECIFICATION
ELEV	ELEVATOR	SQ	SQUARE
EQ	EQUAL	ST.STL.	STAINLESS STEEL
EQPT	EQUIPMENT	STC	SOUND TRANSMISSION CLASS
EXT	EXTERIOR	STD	STANDARD
		STL	STEEL
- 4	FIDE ALADAA		
FA 	FIRE ALARM	STOR	STORAGE
FD	FLOOR DRAIN	STRUCT	STRUCTURAL
FDN	FOUNDATION	T&B	TOP AND BOTTOM
FF	FINISH FLOOR	T&G	TONGUE AND GROOVE
FIXT	FIXTURE	TC	TOP OF CURB
FLR	FLOOR	TEMP	TEMPERATURE
FT	FOOT OR FEET	THK	THICKNESS
		THR	THRESHOLD
GA	GAUGE	T.O.	TOP OF
GALV	GALVANIZED AFTER WELD	TOC	TOP OF CURB
GAW	GALVANIZED AFTER WELD	TP	TOP OF PAVING
GC	GENERAL CONTRACTOR	TV	TELEVISION
GL	GLASS	TW	TOP OF WALL
GND	GROUND		
GP	GYPSUM PLASTER	TYP	TYPICAL
GWB	GYPSUM WALL BOARD	UNO	UNLESS NOTED OTHERWISE
		UL	UNDERWRITERS'S LABORATORY
Н	HEIGHT	OL .	5.12 ELLING EADORATORY
HDR	HEADER	VENT	VENTILATION
HW	HARDWOOD	VGDF	VERTICAL GRAIN DOUGLAS FIR
HDWD	HOT WATER	-	- - - - -
		W	WEST
ID	INSIDE DIAMETER	W/	WITH
IV	INVERT ELEVATION	WC	WATER CLOSET
IN	INCH	WD	WOOD
INCL	INCLUDING		
	INTERIOR	WDB	WOOD FLOOR
	· · · — · · · * · ·	WDF	WOOD FLOOR
INT	IRRIGATION VALVE		
INT	IRRIGATION VALVE	WDP	WOOD PANELING
INT IV	IRRIGATION VALVE JOINT	WDP WIN	WINDOW
INT IV		WDP WIN W/O	WINDOW WITHOUT
INT IV JT		WDP WIN	WINDOW

GENERAL NOTES - CONTINUED

- TOILETS SHALL HAVE 24" FRONT CLEARANCE AND A 30" MINIMUM WIDTH CLEARANCE.
- HOSE BIBS SHALL BE FITTED WITH A NON-REMOVABLE BACKFLOW PREVENTION VALVE.
- DUCTS SHALL BE SIZED PER CHAPTER 6 OF THE APPLICABLE MECHANICAL CODE.
- ELEMENTS OF APPLIANCES WHICH CREATE A GLOW, SPARK, OR FLAME SHALL BE LOCATED A MINIMUM OF 18" ABOVE GARAGE FLOOR. (MC 308.1).
- PROVIDE PASSAGEWAY 24" WIDE OF SOLID CONTINUOUS FLOORING FROM ATTIC ACCESS TO
- FAU CONTROLS. LENGTH OF PASSAGEWAY SHALL NOT EXCEED 20 FEET. (MC 904.11).
- PROVIDE A MINIMUM 36 INCH LANDING MEASURED IN THE DIRECTION OF TRAVEL AT ALL EXTERIOR DOORS.
- CONTRACTOR TO PROVIDE KIT-KAT BARS AT ALL SITE VISITS PERFORMED BY ARCHITECT.
- REQUIRED EGRESS DOORS SHALL NOT SWING OVER A LANDING THAT IS MORE THAN 1.5 INCH IN EIGHT BELOW THE THRESHOLD.
- ALL STAIRWAYS SHALL HAVE AN ILLUMINATION LEVEL ON TREAD RUNS OF NOT LESS THAN 1 FOOT-CANDLE (11 LUX).
- IN ANY INTERIOR AREA USED FOR CHARGING ELECTRIC VEHICLES, ELECTRIC EQUIPMENT SHALL BE INSTALLED PER LOS ANGELES COUNTY ELECTRICAL CODE.
- UNDER-FLOOR VENTING ADDITIONAL NOTES ONE VENTILATION OPENING SHALL BE PLACED WITHIN 3 FEET OF EACH CORNER OF THE BUILDING. THE NET FREE VENTILATION AREA SHALL NOT BE LESS THAN 1/150 OF THE CRAWL SPACE AREA. OPENINGS SHALL HAVE CORROSION-RESISTANT WIRE MESH OR OTHER APPROVED MATERIAL WITH 1/8 INCH MINIMUM AND ¼ INCH MAXIMUM OPENING. UN-VENTED UNDER-FLOOR SPACE SHALL COMPLY WITH SECTION 408.3.
- SPECIAL INSPECTOR MUST BE EMPLOYED BY THE OWNER OR DESIGN PROFESSIONAL IN CHARGE ACTING AS THE OWNER'S AGENT. SPECIAL INSPECTOR MAY NOT BE EMPLOYED BY THE CONTRACTOR (CBC 1704.2).
- ALL INSTALLED LUMINAIRES SHALL BE HIGH EFFICIENCY FIXTURES (CENC 150.0(K)1.A)

WATER CLOSET 1.28 GALLONS / FLUSH

FIXTURE WATER USE VALUES MAXIMUMS: SHOWERHEADS, RESIDENTIAL 2.0 GPM @80 PSI LAVATORY FAUCETS, RESIDENTIAL 0.8 GPM @ 20 PSI AND MAX 1.5 GPM @ 60 PSI KITCHEN FAUCETS 1.8 GPM @ 60 PSI

FIRE PROTECTION NOTES

- IF REQUIRED BY CITY ORDINANCES OR FIRE DEPARTMENT, FIRE SPRINKLERS SHALL BE INSTALLED AND ONE-HOUR FIRE SEPARATIONS SHALL BE PROVIDED. CONTRACTOR SHALL PROVIDE SPRINKLER PLAN TO FIRE MARSHALL FOR REVIEW AND APPROVAL PRIOR TO INSTALLATION.
- SMOKE ALARM SHALL BE INTERCONNECTED HARDWIRED WITH BATTERY BACKUP AND SHALL BE INSTALLED IN ACCORDANCE WITH NFPA 72. BATTERY SMOKE ALARM PERMITTED IN EXISTING BUILDINGS WHERE NO CONSTRUCTION IS TAKING PLACE. SMOKE ALARMS SHALL BE TESTED AND MAINTAINED IN ACCORDANCE WITH MANUFACTURER'S INSTRUCTIONS, SMOKE ALARMS SHALL BE REPLACED AFTER 10 YEARS FROM THE DATE OF MANUFACTURED MARKED ON THE UNIT. CONVENTIONAL IONIZATION SMOKE ALARMS THAT ARE SOLELY BATTERY POWERED SHALL BE EQUIPPED WITH 10 YEAR BATTERY AND HAVE A SILENCE FEATURE.

GENERAL NOTES

- THE GENERAL CONTRACTOR SHALL VERIFY ALL CONDITIONS AND DIMENSIONS AT THE PROJECT SITE AS DESCRIBED IN THE CONTRACT DOCUMENTS PRIOR TO STARTING CONSTRUCTION, AND SHALL CROSS-CHECK DETAILS AND DIMENSIONS ON THE CIVIL, ARCHITECTURAL, AND STRUCTURAL DRAWINGS. ANY DISCREPANCIES SHALL BE REPORTED TO THE OWNER PRIOR TO CONSTRUCTION. ALL TRADES SHALL VERIFY AT THE PROJECT SITE, CONDITIONS AND MEASUREMENTS RELATED TO THEIR WORK AND COORDINATE THEIR WORK THROUGH THE GENERAL CONTRACTOR WITH ALL TRADES WORKING IN THE VICINITY OF THEIR WORK.
- ITEMS MARKED N.I.C. ON THE DRAWINGS ARE NOT PART OF THIS CONTRACT.
- DETAILS MARKED "TYPICAL" SHALL APPLY IN ALL CASES, UNLESS SPECIFICALLY DETAILED OTHERWISE. WHERE NO DETAIL IS SHOWN, CONSTRUCTION SHALL BE AS SHOWN FOR OTHER
- DO NOT SCALE DRAWINGS.
- NO OMISSIONS OR CHANGES SHALL BE MADE WITHOUT WRITTEN APPROVAL OF THE OWNER.
- NO SUBSTITUTIONS SHALL BE MADE WITHOUT WRITTEN APPROVAL OF THE OWNER.
- ALL DIMENSIONS ARE FACE OF STUD WALL, CENTERLINE OF COLUMN, OR FACE OF CONCRETE UNLESS NOTED OTHERWISE.
- NO MATERIALS FROM THE WORK ARE TO BE STOCK-PILED ON PUBLIC RIGHT-OF-WAYS ALL RUBBISH AND DEBRIS IS TO BE REMOVED FROM THE SITE.
- ALL WORKMANSHIP SHALL BE PERFORMED BY SKILLED LABORERS USING THE BEST STANDARD PRACTICE OF THE TRADE.
- DAMAGE DONE TO CITY AND/OR ADJOINING PROPERTY, OR EXISTING STRUCTURES NOT INCLUDED IN THIS CONTRACT, SHALL BE RESTORED TO EXISTING CONDITIONS AT THE EXPENSE OF THE CONTRACTOR.
- MECHANICAL SYSTEM SHALL BE DESIGN-BUILD BY THE CONTRACTOR AND SHALL CONFORM TO ALL TITLE 24 AND MECHANICAL CODE REQUIREMENTS. 1/150 SF OF ATTIC AREA IS TO BE VENTED. CONTRACTOR TO PROVIDE VENTILATION AS PER ELEVATIONS.
- PROVIDE GALVANIC INSULATION BETWEEN DISSIMILAR METALS.
- CLASS "A" ROOFING IS REQUIRED FOR FIRE PROTECTION.
- ALL GYPSUM BOARD SHALL BE %" TYPE "X". WATER RESISTANT (W/R) SHALL BE %" TYPE "X" WATER RESISTANT UNLESS OTHERWISE NOTED. USE MOLD-RESISTANT GYPSUM BOARD AT ALL WET LOCATIONS.
- CONTRACTOR SHALL VERIFY ALL UTILITIES AND NOTIFY THE OWNER OF ANY DISCREPANCIES PRIOR TO COMMENCING CONSTRUCTION.
- WHERE DOORS ARE LOCATED NEXT TO A WALL, THERE SHALL BE 4" MINIMUM CLEARANCE BETWEEN WALL FINISH SURFACE AND FACE OF DOOR IN A 30 DEGREE POSITION, UNLESS DETAILED OR DIMENSIONED OTHERWISE.
- WHERE THE CHOICE OF FINISH COLOR IS POSSIBLE, IT IS TO BE SELECTED BY THE OWNER.
- ABOVE GROUND GAS METERS, REGULATORS, AND PIPING EXPOSED TO VEHICULAR DAMAGE DUE TO THEIR PROXIMITY TO ALLYS, DRIVEWAYS, OR PARKING AREAS, SHALL BE PROTECTED IN AN APPROVED MANNER. (MC 308.1).
- ALL MANUFACTURED DOORS AND WINDOWS SHALL BE LABELED AND CERTIFIED BY THE CALIFORNIA ENERGY COMMISSION AND UL LABELED FOR RATED DOORS AND/OR WINDOWS.
- ALL SLOPES ADJACENT TO BUILDINGS SHALL SLOPE AWAY AT A 2% GRADE MINIMUM FOR ALL GRADES, ELEVATIONS, AND DRAINAGE.
- PROPERTY ADDRESS SHALL BE NUMBERS IN CONTRAST WITH BACKGROUND, BE ARABIC OR ALPHABETICAL LETTERS AND BE A MINIMUM OF 4" HIGH WITH A MINIMUM STROKE OF 1/2".
- GLASS PANES WITHIN 18" ABOVE FINISH FLOOR OR LESS SHALL BE TEMPERED.
- RADIANT BARRIER REQUIRED AT ALL NEW ROOF CONSTRUCTION.

504.3.2).

- WALL COVERINGS IN SHOWERS AND TUBS SHALL BE CEMENT PLASTER, TILE, OR EQUAL TO 70" ABOVE THE DRAIN. ENCLOSURES MUST BE APPROVED SAFETY GLAZING AND DOORS MUST SWING OUT OF SHOWERS. WINDOWS IN ENCLOSURE WALLS SHALL BE LABELED SAFETY GLAZING WHEN LESS THAN 60" ABOVE THE DRAIN.
- ALL SHOWERS AND TUB-SHOWERS SHALL HAVE EITHER A PRESSURE BALANCE OR A THERMOSTATIC MIXING VALVE. (PC 418).
- ADDITIONAL VENTING NOTES A MINIMUM OF 1 INCH AIRSPACE SHALL BE PROVIDED BETWEEN INSULATION AND ROOF SHEATHING. UN-VENTED ATTIC ASSEMBLIES SHALL MEET ALL THE CONDITIONS IN SECTION R806.4.
- PROVIDE A MINIMUM OF 30" VERTICAL CLEARANCE ABOVE COOK-TOP TO UNPROTECTED COMBUSTIBLE MATERIALS.
- CLOTHES DRYER SHALL BE VENTED TO EXTERIOR WITH 4" SMOOTH METAL DUCT AND BACK-DRAFT DAMPER. DUCT SHALL NOT EXCEED 14'-0" LENGTH WITH A MAXIMUM OF 2 ELBOWS. DUCT LENGTH SHALL BE REDUCED BY 2 FEET FOR EVERY ELBOW IN EXCESS OF THE TWO (MC
- ALL BEDROOMS SHALL HAVE A WINDOW THAT IS DESIGNATED AN ESCAPE WINDOW. THE ESCAPE WINDOW SHALL HAVE A MINIMUM NET CLEAR OPENABLE AREA OF 5.75 SF, WITH A MINIMUM NET CLEAR OPENABLE WIDTH OF 20" AND HEIGHT OF 24". THE WINDOW SILL HEIGHT SHALL NOT BE MORE THAN 44" ABOVE FINISHED FLOOR. (1026.1, 1026.2, 1026.2.1, 1026.3) CONTRACTOR TO VERIFY PROPER DIMENSIONS PRIOR TO ORDERING WINDOWS.
- AN ATTIC ACCESS OPENING SHALL BE PROVIDED INTO ALL ATTIC SPACES WITH A MINIMUM OPENING DIMENSION OF 22"X30". 30" MINIMUM CLEAR HEADROOM IS REQUIRED ABOVE THE OPENING. (R807.1) PROVIDE SWITCH AND LIGHT.

KARABACHIAN ARCHITECTS, INC

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OWNER


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PROJECT ADDRESS: **926 E DRYDEN STREET**

ADDITION AND REMODEL

GLENDALE, CALIFORNIA 91207

GENERAL NOTES

PERMIT #: BSFD-018869-2024

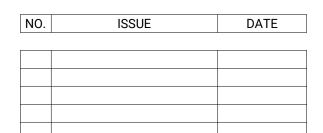PLANNING #: PMPA-003557-2024

ORIGINAL SHEET SIZE: 24" x 36"


PROJECT: 2024-008

SCALE:

DRAWN BY:

DATE: 10/23/2024



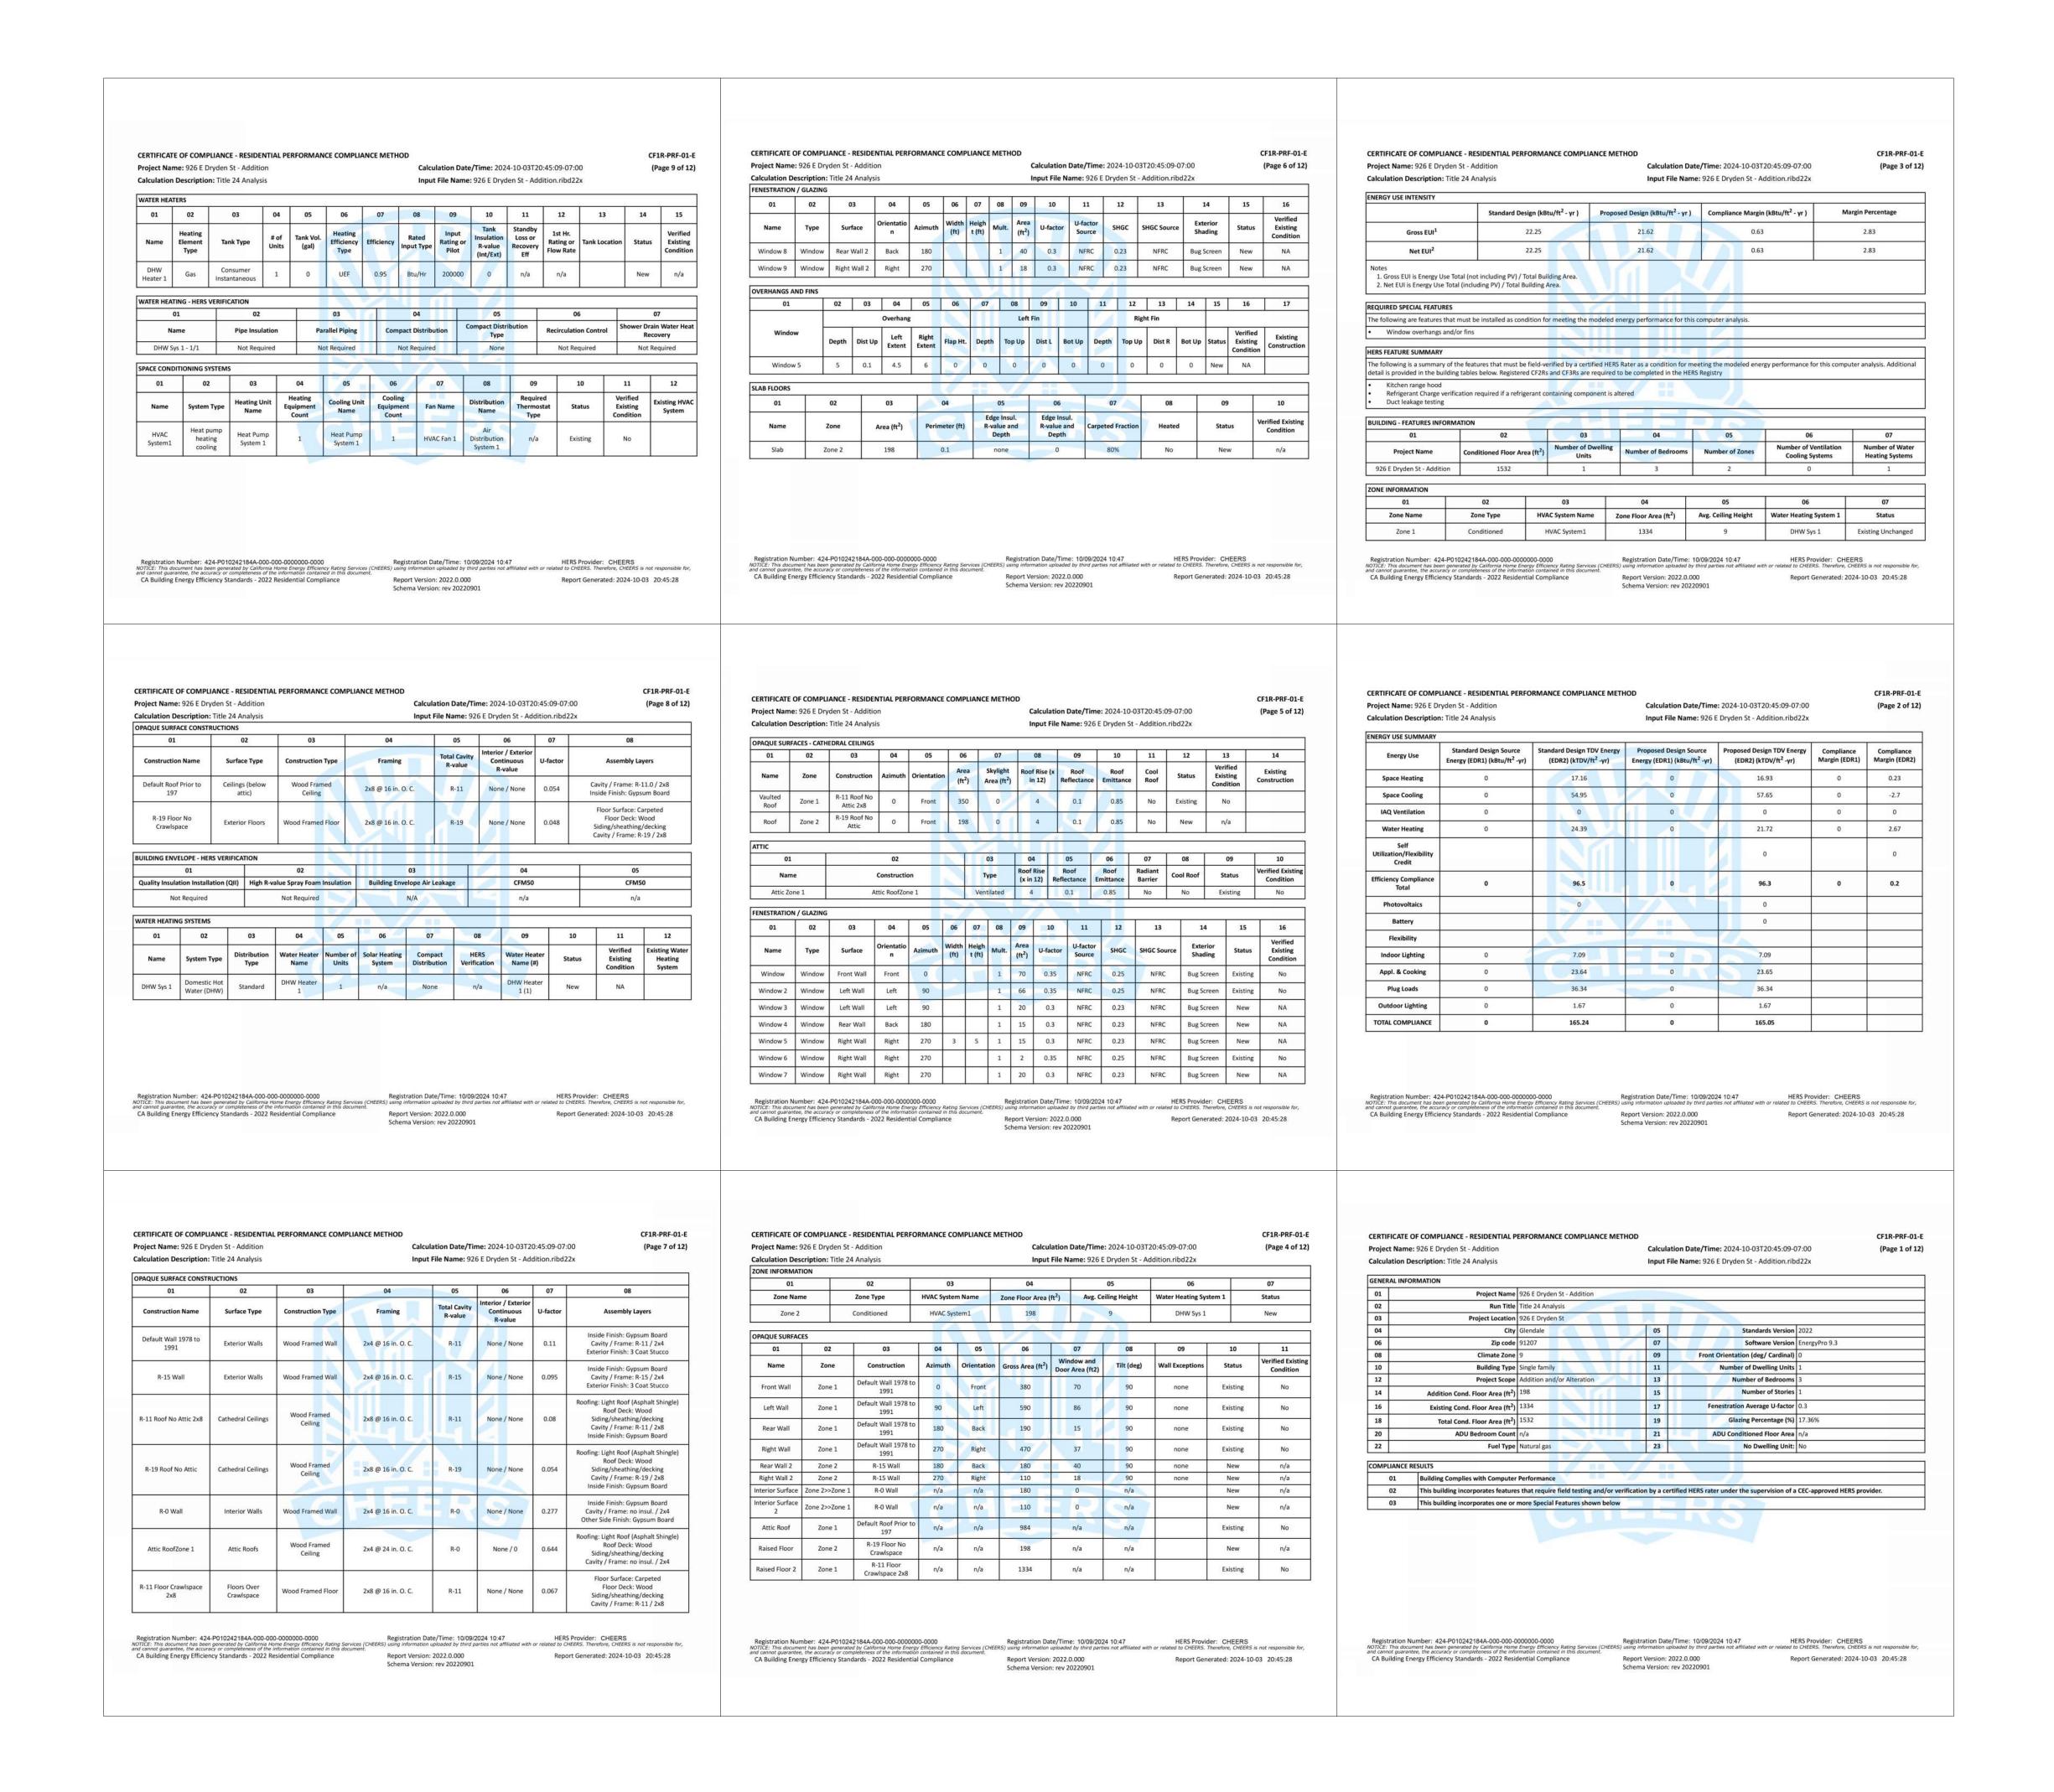



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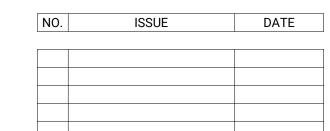
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PROJECT ADDRESS: 926 E DRYDEN STREET GLENDALE, CALIFORNIA 91207

ADDITION AND REMODEL

TITLE:

ENERGY CALCULATIONS ADDITION

PERMIT #:BSFD-018869-2024

PLANNING #: PMPA-003557-2024

ORIGINAL SHEET SIZE: 24" x 36"

PROJECT: 2024-008

SCALE:

DRAWN BY:

DATE: 10/23/2024

SHEET NUMBER:

10 001



CERTIFICATE OF COMPLIANCE - RESIDENTIAL PERFORMANCE COMPLIANCE METHOD Project Name: 926 E Dryden St - Addition Calculation Date/Time: 2024-10-03T20:45:09-07:00 (Page 12 of 12) Calculation Description: Title 24 Analysis Input File Name: 926 E Dryden St - Addition.ribd22x
DOCUMENTATION AUTHOR'S DECLARATION STATEMENT 1. I certify that this Certificate of Compliance documentation is accurate and complete.
Documentation Author Name: Patric Novshadian Documentation Author Signature: Patric Novshadian
Company: Pat's Mechanical Engineering Group Signature Date: 10/09/2024
Address: 9154 Tujunga Canyon Blvd CEA/ HERS Certification Identification (if applicable):
City/State/Zip: Los Angeles, CA 91042 Phone: 818-281-0470
RESPONSIBLE PERSON'S DECLARATION STATEMENT I certify the following under penalty of perjury, under the laws of the State of California: 1. I am eligible under Division 3 of the Business and Professions Code to accept responsibility for the building design identified on this Certificate of Compliance.
 I certify that the energy features and performance specifications identified on this Certificate of Compliance conform to the requirements of Title 24, Part 1 and Part 6 of the California Code of Regulations. The building design features or system design features identified on this Certificate of Compliance are consistent with the information provided on other applicable compliance documents, worksheets, calculations, plans and specifications submitted to the enforcement agency for approval with this building permit application.
Responsible Designer Name: Sevak Karabachian
Company: Karabachian Architects, Inc. Date Signed: 10/09/2024
Address: License: 3234 1/2 Foothill Blvd C-38632
City/State/Zip: Phone: Glendale, CA 91214 6265525746
Digitally signed by California Home Energy Efficiency Rating Services (CHEERS). This digital signature is provided in order to secure the content of this registered document, and in no way implies Registration Provider responsibility for the accuracy of the information. Registration Number: 424-P010242184A-000-000-0000000 Registration Date/Time: 10/09/2024 10:47 HERS Provider: CHEERS NOTICE: This document has been generated by California Home Energy Efficiency Rating Services (CHEERS) using information uploaded by third parties not affiliated with or related to CHEERS. Therefore, CHEERS is not responsible for, and cannot guarantee, the accuracy or completeness of the information contained in this document. CA Building Energy Efficiency Standards - 2022 Residential Compliance Report Version: 2022.0.000 Report Generated: 2024-10-03 20:45:28 Schema Version: rev 20220901
CERTIFICATE OF COMPLIANCE - RESIDENTIAL PERFORMANCE COMPLIANCE METHOD Project Name: 526 E Dryslen St - Addition Calculation Date/Time: 2024-10-03720-45-09-07-00 (Page 11 of 12) Input file Name: 926 E Dryslen St - Addition ribid2x TWAC DISTRIBUTION - HEIS VERFICKTION 61 02 03 04 05 06 07 08 09 Rume Dort Loakage Dust tealage Verified Dust Verified Dust Doslon Buried Dusts Despi Buried Dusts Insuring Complete Doslon Buried Dusts Despi Buried Dusts Insuring Complete Doslon Buried Dusts Despi Buried Dusts Insuring Complete Doslon Buried Dusts Doslon Dust Required Not Required Not Required To Resident Not Required Not Required Not Required To Resident Not Required Not Required To Resident Not Required Not Required Not Required Not Required To Resident Not Required Not
CERTIFICATE OF COMPLIANCE - RESIDENTIAL PERFORMANCE COMPLIANCE METHOD Calculation Date/Time: 2024-10-03T20-45:09-07:00 (Page 10 of 12) (Page 10 of 1



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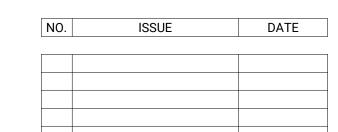
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PROJECT ADDRESS: **926 E DRYDEN STREET** GLENDALE, CALIFORNIA 91207

ADDITION AND REMODEL

ENERGY CALCULATIONS ADDITION

PERMIT #:BSFD-018869-2024

PLANNING #: PMPA-003557-2024

ORIGINAL SHEET SIZE: 24" x 36"

PROJECT: 2024-008 SCALE:

DRAWN BY:

DATE: 10/23/2024

SHEET NUMBER:

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KARABACHIAN ARCHITECTS, INC. **ARCHITECT**

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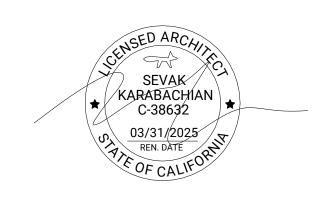
BIRD'S EYE AXON - NORTHWEST

2 BIRD'S EYE AXON - NORTHEAST

▲ BIRD'S EYE AXON - SOUTHWEST

BIRD'S EYE AXON - SOUTH EAST

DATE ISSUE



PROJECT ADDRESS: **926 E DRYDEN STREET** GLENDALE, CALIFORNIA 91207

ADDITION AND REMODEL

3D VIEWS

PERMIT #:BSFD-018869-2024

PLANNING #: PMPA-003557-2024

ORIGINAL SHEET SIZE: 24" x 36"

PROJECT: 2024-008 SCALE:


DRAWN BY:

DATE: 10/23/2024


FINISH MATERIAL 926 E DRYDEN ST, GLENDALE, CALIFORNIA 91207

WINDOW

ANDERSON E-SERIES WINDOW AWNING WHITE COLOR FINISH

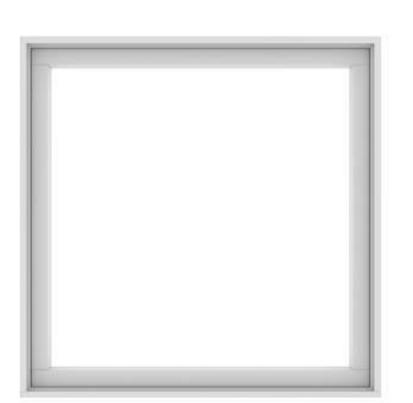


E-SERIES FRENCH CASEMENT ACTIVE LEFT - PASSIVE RIGHT OPERATION WHITE COLOR FINISH

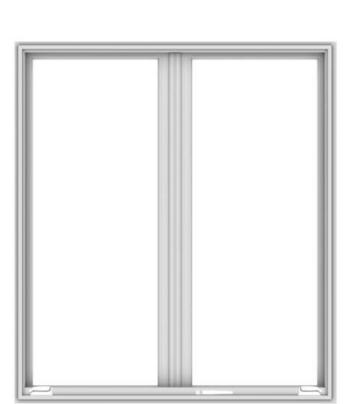


WINDOW

ANDERSON **E-SERIES CASEMENT** LEFT OPERATION WHITE COLOR FINISH

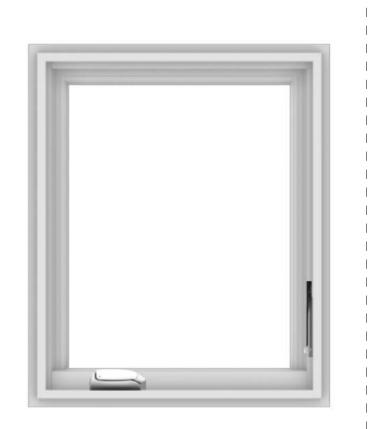

EXTERIOR DOOR

ANDERSON E-SERIES INSWING DOOR 2 PANEL FRENCH PASSIVE LEFT - ACTIVE RIGHT OPERATION WHITE COLOR FINISH

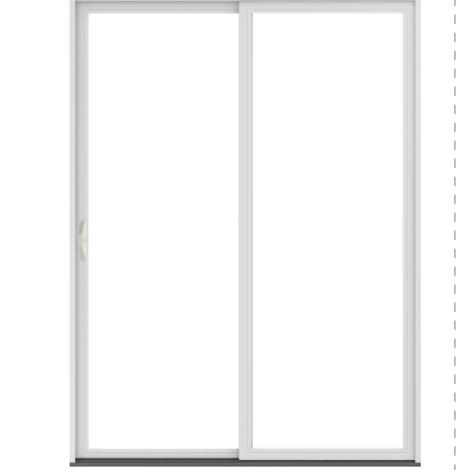

OWNER

ARCHITECT

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KARABACHIAN ARCHITECTS, INC.

CONSULTANTS


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EXTERIOR STUCCO

PERMA-FLEX STUCCO GRADE ACRYLIC FINISH COLOR: WHITE (TO MATCH EXISTING FACADE COLOR)




FINE

ROOFING

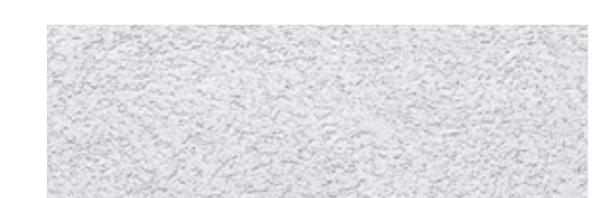REDLAND CLAY TILE ALFARO 300 SERIES TERRA COTTA BLEND (3010) COLOR TO MATCH EXISTING CLAY TILE ROOF





3010 Terra Cotta Blend

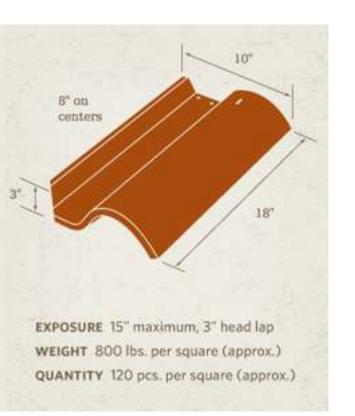

EXTERIOR LIGHT FIXTURE

SONNEMAN MEZZA VETRO 8" SCONCE COLOR: TEXTURED WHITE

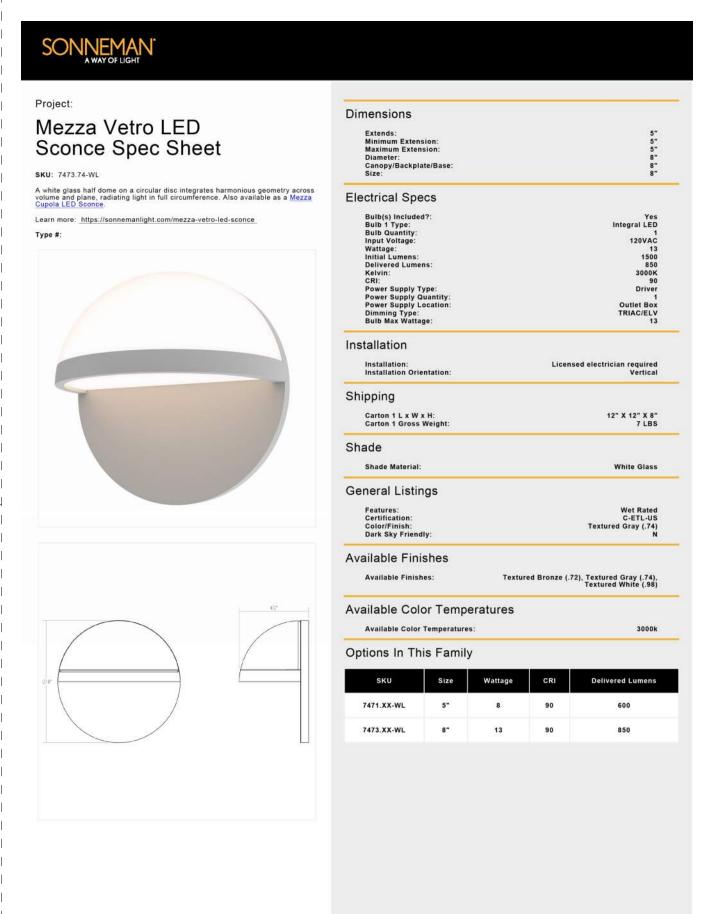

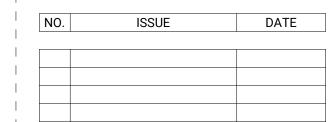



PROJECT ADDRESS:

926 E DRYDEN STREET GLENDALE, CALIFORNIA 91207

ADDITION AND REMODEL

MATERIAL LEGEND

PERMIT #:BSFD-018869-2024

PLANNING #: PMPA-003557-2024

ORIGINAL SHEET SIZE: 24" x 36"

PROJECT: 2024-008

DRAWN BY:

SCALE:

10/23/2024



ARCHITECT

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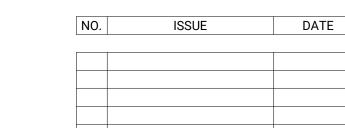
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PROJECT ADDRESS:

926 E DRYDEN STREET GLENDALE, CALIFORNIA 91207

ADDITION AND REMODEL

WINDOW REPLACEMENT FORM

PERMIT #:BSFD-018869-2024

PLANNING #: PMPA-003557-2024

ORIGINAL SHEET SIZE: 24" x 36"


PROJECT: 2024-008

SCALE: DRAWN BY:

DATE: 10/16/2024

SHEET NUMBER:



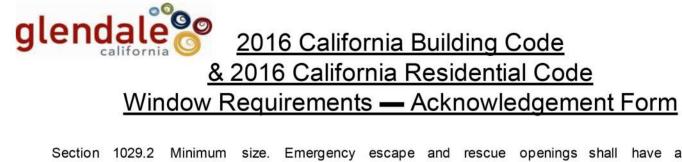

Section 1029.2 Minimum size. Emergency escape and rescue openings shall have a minimum net clear opening of 5.7 square feet (0.53 m²).

Exception: Grade floor openings shall have a minimum net clear opening of 5 square feet (0.465m^2) .

Exception: See the Historical Building Code for the Historic portion of qualified historic

Section 1029.2.1 Minimum dimensions. The minimum net clear opening height dimension shall be 24 inches (610 mm). The minimum net clear opening width dimension shall be 20 inches (508 mm).

The net clear opening dimensions shall be the result of normal operation of the opening. Section 1029.3 Maximum height from the floor. Emergency escape and rescue openings shall

have the bottom of the clear opening not greater than 44 inches (1118 mm) measured from the floor. The requirements listed above are duplicated in Section R310 of the 2013 California Residential Code. Acknowledgement:

I attest that I have read the foregoing requirements that pertain to emergency escape and rescue openings. I understand that the net clear opening dimensions of a window may be significantly smaller than the nominal dimensions of a window, and that prior to securing a permit for the installation and/or replacement of a window I am responsible for ensuring compliance. I further acknowledge that emergency escape and rescue windows that do not meet these minimum standards should not be installed, because windows that do not meet <u>all</u> of the standards may be required to be removed at the owner's expense.


Additionally, I acknowledge that windows that differ in style and/or appearance from windows that have been approved by Planning Department staff may not be substituted, regardless of weather such windows may appear to be similar. I acknowledge that prior approval for substitution of any window (s) must be secured from the Planning Department prior to installation of any windows. I acknowledge that failure to secure Planning Department approval prior to any window substitutions may result in a requirement to remove such windows at the owner's expense, regardless of inspection and/or approval of same by a building inspector.

I attest that as the owner of the property or as the owner's agent, I have read the foregoing information. Furthermore I attest that as the owner of the property or the owner's agent, I understand the foregoing conditions and will ensure compliance with same.



Window Acknowledgment

Rev 11/22

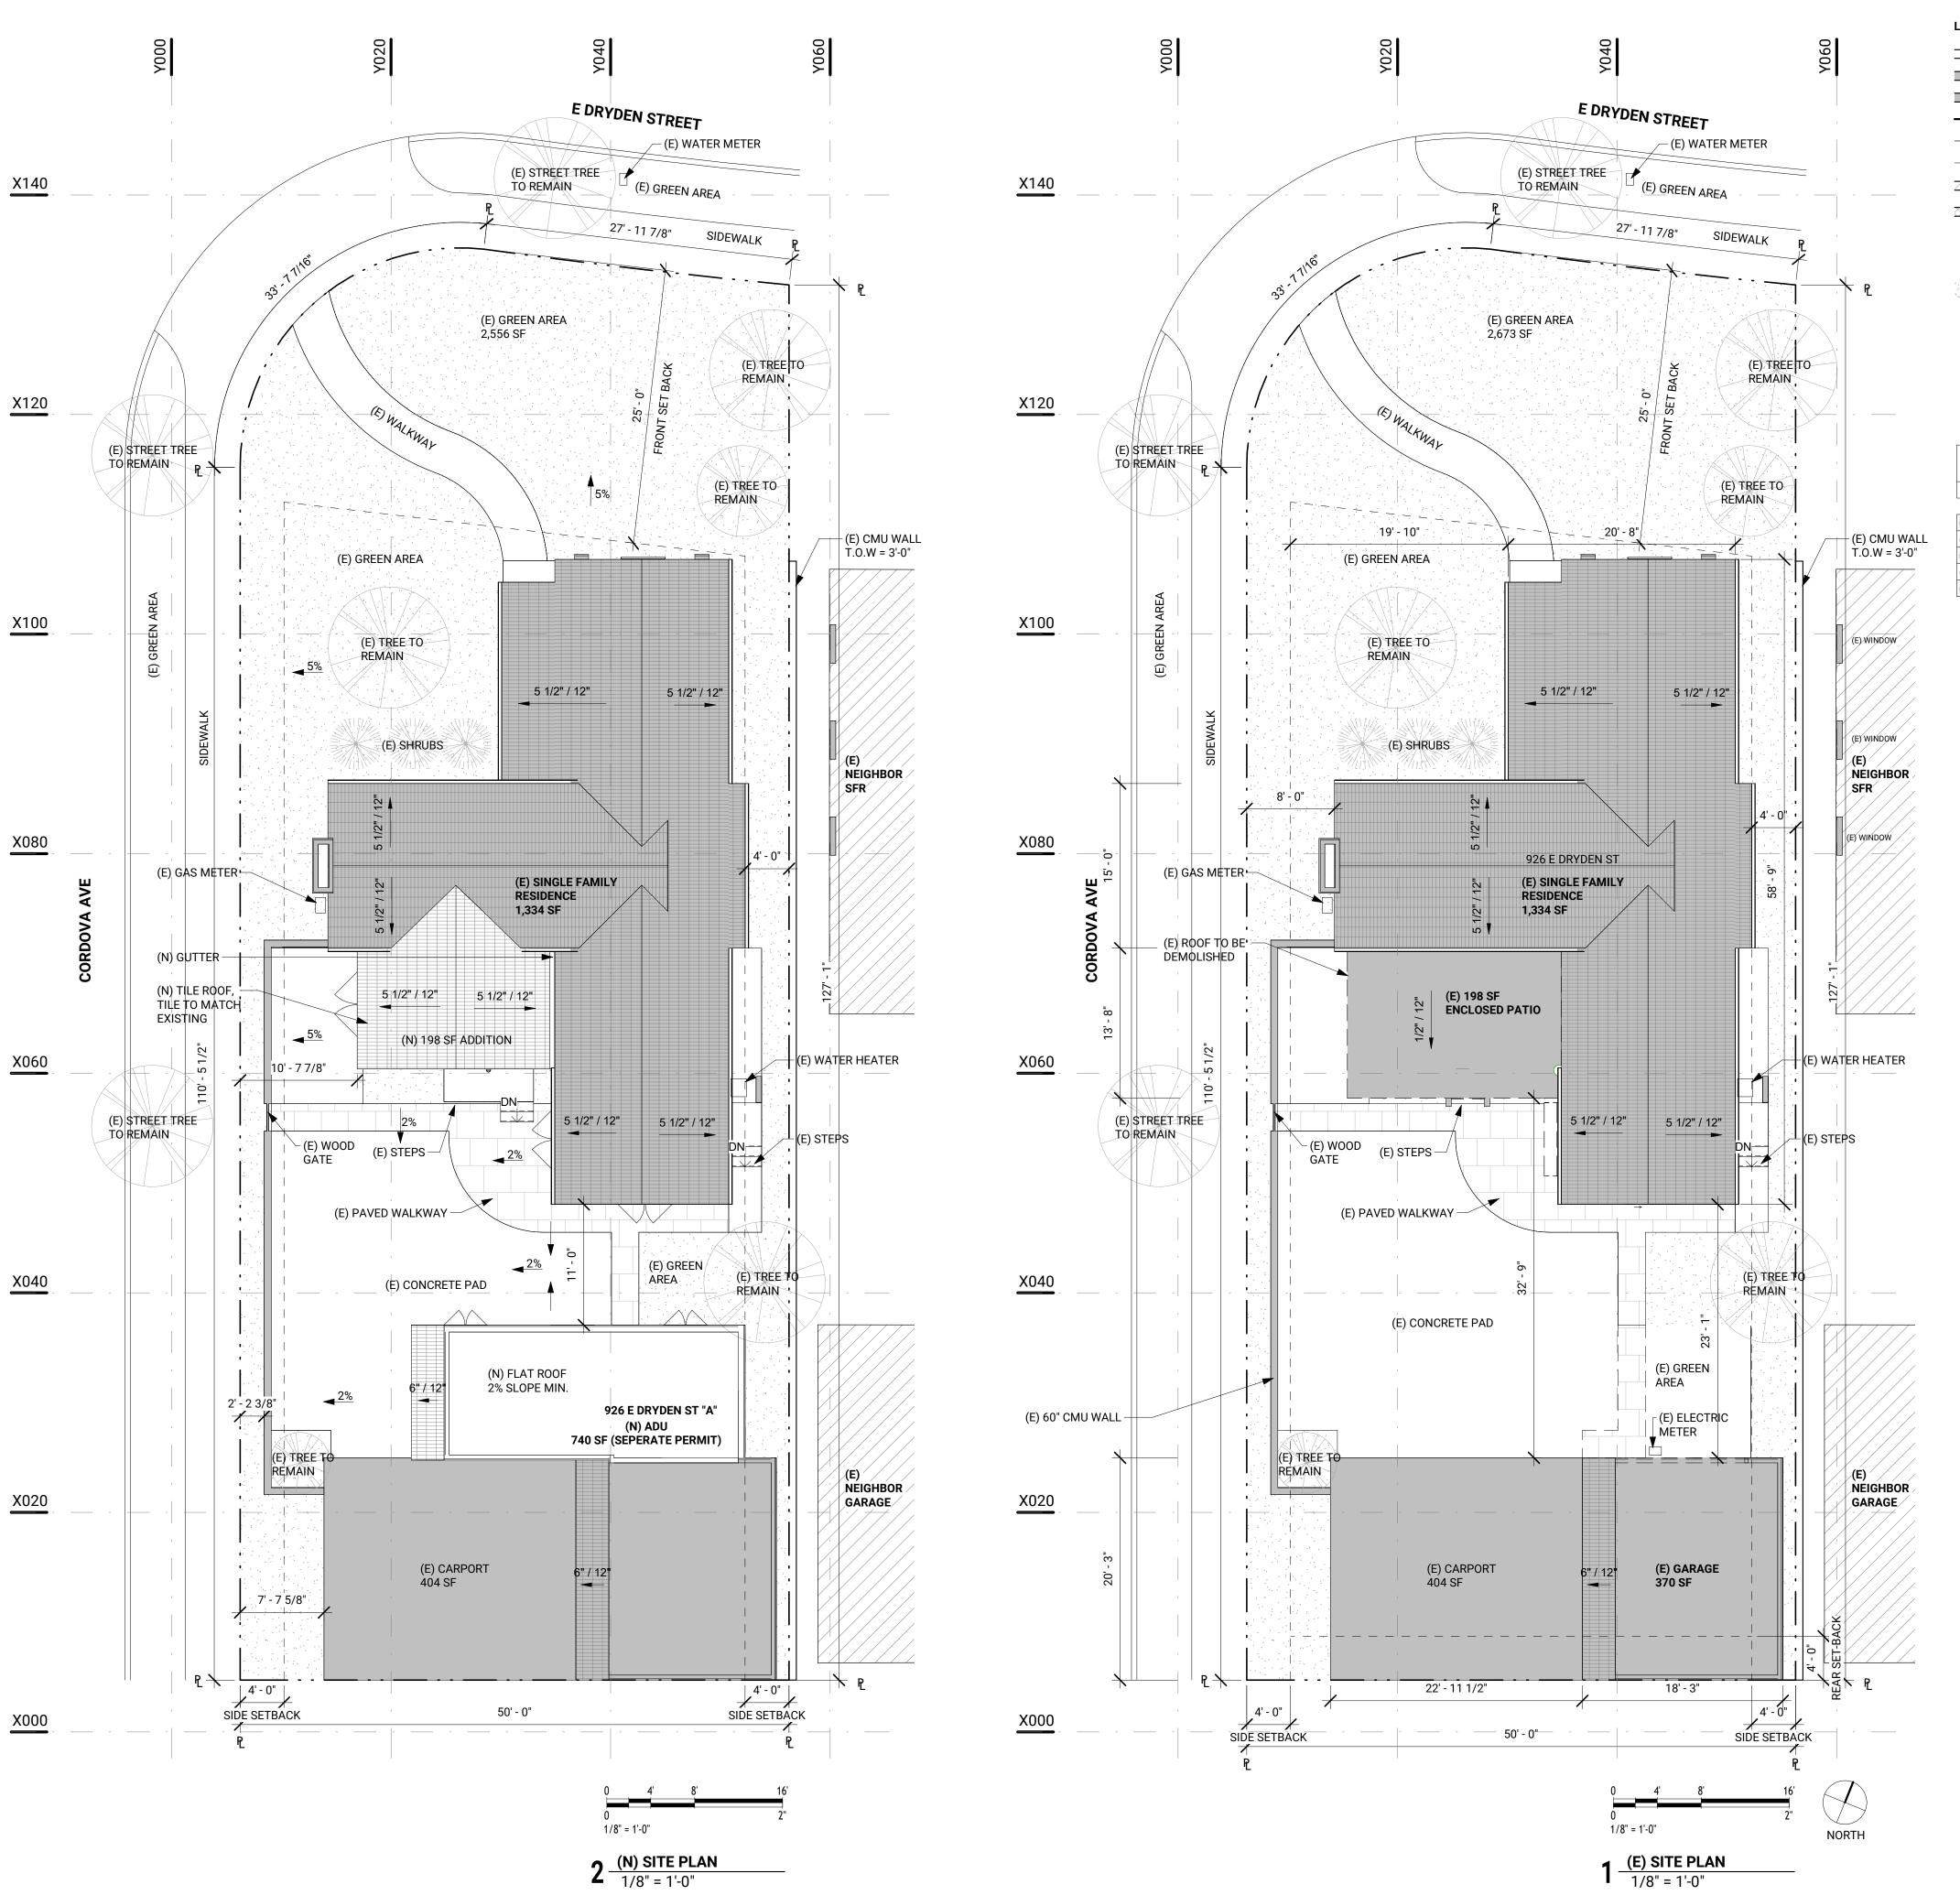

LEGEND:

NEW WALL DEMO WALL EXISTING WALL PROPERTY LINE ROOF OVERHEAD

SETBACK LINE **NEW ADDITION** 1HR RATED PARTITION,


SEE A6-302 PARTITION TAG. REFER TO SHEET A6-301

LANDSCAPE AREA

DRAINAGE LEGEND:

GENERAL DRAINAGE ARROW 2% TYPICAL AT CONCRETE WALKWAYS, LANDINGS, AND DRIVEWAYS. PROVIDE A MINIMUM GRADE FALL OF 6" WITHIN THE FIRST 10 FEET OF FOUNDATION WALL. CRC401.3

AREA CALCULATION			
LEVEL	AREA		
(E) SINGLE FAMILY RESIDENCE	1332 SF		
(E) CARPORT	404 SF		
(E) GARAGE (TO BE CONVERTED TO NEW ADU)	370 SF		
(E) ENCLOSED PATIO	198 SF		
(N) ADU ADDITION (SEPERATE PERMIT)	370 SF		

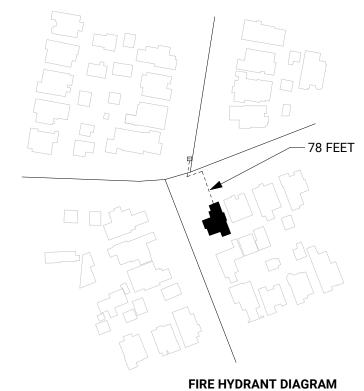

LANDSCAPE NOTES:

PROTECTED OAK SYCAMORE BAY TREES OR CITY STREET TREES ON THE PROPERTY AND WITHIN 20' OF THE PROPERTY ARE INACCESSIBLE TO THE PROPOSED CONSTRUCTION ACTIVITY AND WILL EXPERIENCE NO IMPACT. NO PROTECTIVE FENCING IS REQUIRED.

A. PROVISIONS SHALL BE MADE FOR CONTRIBUTORY DRAINAGE AT ALL TIMES. B. OWNER SHALL MAINTAIN DRAINAGE DEVICES AND KEEP FREE OF DEBRIS. C. A PROPERTY LINE SURVEY, PREPARED BY A CALIFORNIA LICENSED LAND SUPVEYOR MAY BE REQUIRED BY THE BUILDING OFFICAL BASED UPON SITE CONDISIONS IN ACCORDANCE WITH LACBC SECTION 108.1.

D. NO WORK IS ALLOWED WITHIN THE PROTECTED ZONE OF OAK TREE WITHOUT AN OAK TREE REPORT AND PERMIT. E. SURROUND THE CONSTRUCTION AREA WITH SILT FENCE, GRAVEL BAGS OR

FIBER ROLLS DURING RAINY SEASON BETWEEN OCT 15TH AND APRIL 15TH. F. FINISH FLOOR SHALL BE A MINIMUM OF 8 INCHES ABOVE FINISH GRADE IMMEDIATELY OUTSIDE THE BUILDING. G. PROVIDE A MINIMUM GRADE FALL OF 6 INCHES WITHIN THE FIRST 10 FEET

(5% SLOPE) FROM FOUNDATION WALL. H. DOWNSPOUTS SHALL DISCHARGE AT LEAST 5 FEET AWAY FROM EXTERIOR

I. SHEET FLOW DRAINAGE SHALL MAINTAIN A MINIMUM 1/4" PER FOOT SLOPE. J. ALL DRAINAGE ON SITE MUST BE DIRECTED TO THE STREET. K. DRAINAGE TO THE ALLEY IS NOT ALLOWED.

KARABACHIAN ARCHITECTS, INC. **ARCHITECT**

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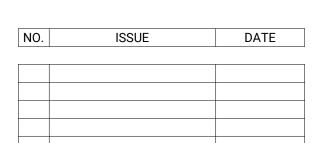
OWNER

MATTHEW ISLAM 926 E DRYDEN ST. GLENDALE CA, 91207 M: 878-307-7853 E: MATTHEWISLAM17@GMAIL.COM

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PROJECT ADDRESS: **926 E DRYDEN STREET** GLENDALE, CALIFORNIA 91207

ADDITION AND REMODEL

SITE PLAN

PERMIT #:BSFD-018869-2024

PLANNING #: PMPA-003557-2024

ORIGINAL SHEET SIZE: 24" x 36"

PROJECT: 2024-008 SCALE:

As indicated

10/23/2024

DATE:

ARCHITECT

LEGEND:

_ _ _ _ _

DEMOLITION CALCULATION

WALL #01 17'-6"

WALL #03 11'-8"

WALL #1 18'-0" WALL #2 11'-0" WALL #3 12'-4" WALL #4 15'-0" WALL #5 20'-5" WALL #6 15'-10" WALL #7 4'-10" WALL #8 15'-10" WALL #9 1'-6"

WALL #10 20'-5" WALL #11 15'-0" WALL #12 23'-4" WALL #13 1'-6"

WALL #14 15'-10"

A) AREA OF WALLS TO BE DEMOLISHED

TOTAL: 29'-2" X 7'-6" TALL = **218.75 SF**

C) TOTAL AREA OF EXISTING WALLS:

TOTAL: 190'-2" X 8'-6" TALL = 1,616 SF

(D) TOTAL AREA OF EXISTING ROOF: 1,334 SF

DEMOLITION CALCULATION: (A+B) / (C+D) = X

(218.75 SF + 198 SF) / (1,616 SF + 1,334 SF) = (416.75 SF) / (2,950 SF) = 0.14 X 100 = **14**%

B) AREA OF EXISTING ROOF TO BE DEMOLISHED: 198 SF

NEW WALL

DEMO WALL

EXISTING WALL

PROPERTY LINE

ROOF OVERHEAD

SETBACK LINE

NEW ADDITION

SEE A6-302

1HR RATED PARTITION,

PARTITION TAG. REFER TO SHEET A6-301

LANDSCAPE AREA

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OWNER


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PROJECT ADDRESS:

926 E DRYDEN STREET GLENDALE, CALIFORNIA 91207

ADDITION AND REMODEL

DEMO PLAN

PERMIT #:BSFD-018869-2024

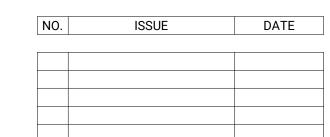
PLANNING #: PMPA-003557-2024


ORIGINAL SHEET SIZE: 24" x 36"

PROJECT: 2024-008

As indicated

10/23/2024

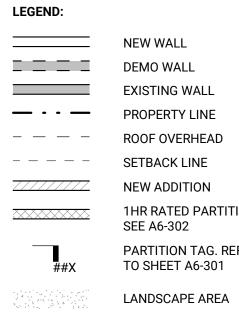

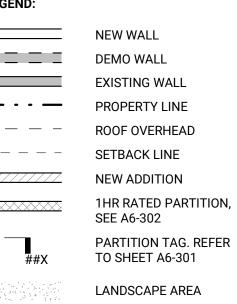

KARABACHIAN ARCHITECTS, INC. **ARCHITECT**

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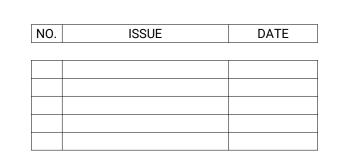
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PROJECT ADDRESS: **926 E DRYDEN STREET** GLENDALE, CALIFORNIA 91207

ADDITION AND REMODEL

DEMO PLAN

PERMIT #:BSFD-018869-2024

PLANNING #: PMPA-003557-2024

ORIGINAL SHEET SIZE: 24" x 36"


PROJECT: 2024-008

As indicated

DATE: 10/23/2024

SHEET NUMBER:

© KARABACHIAN.COM **A2-102**

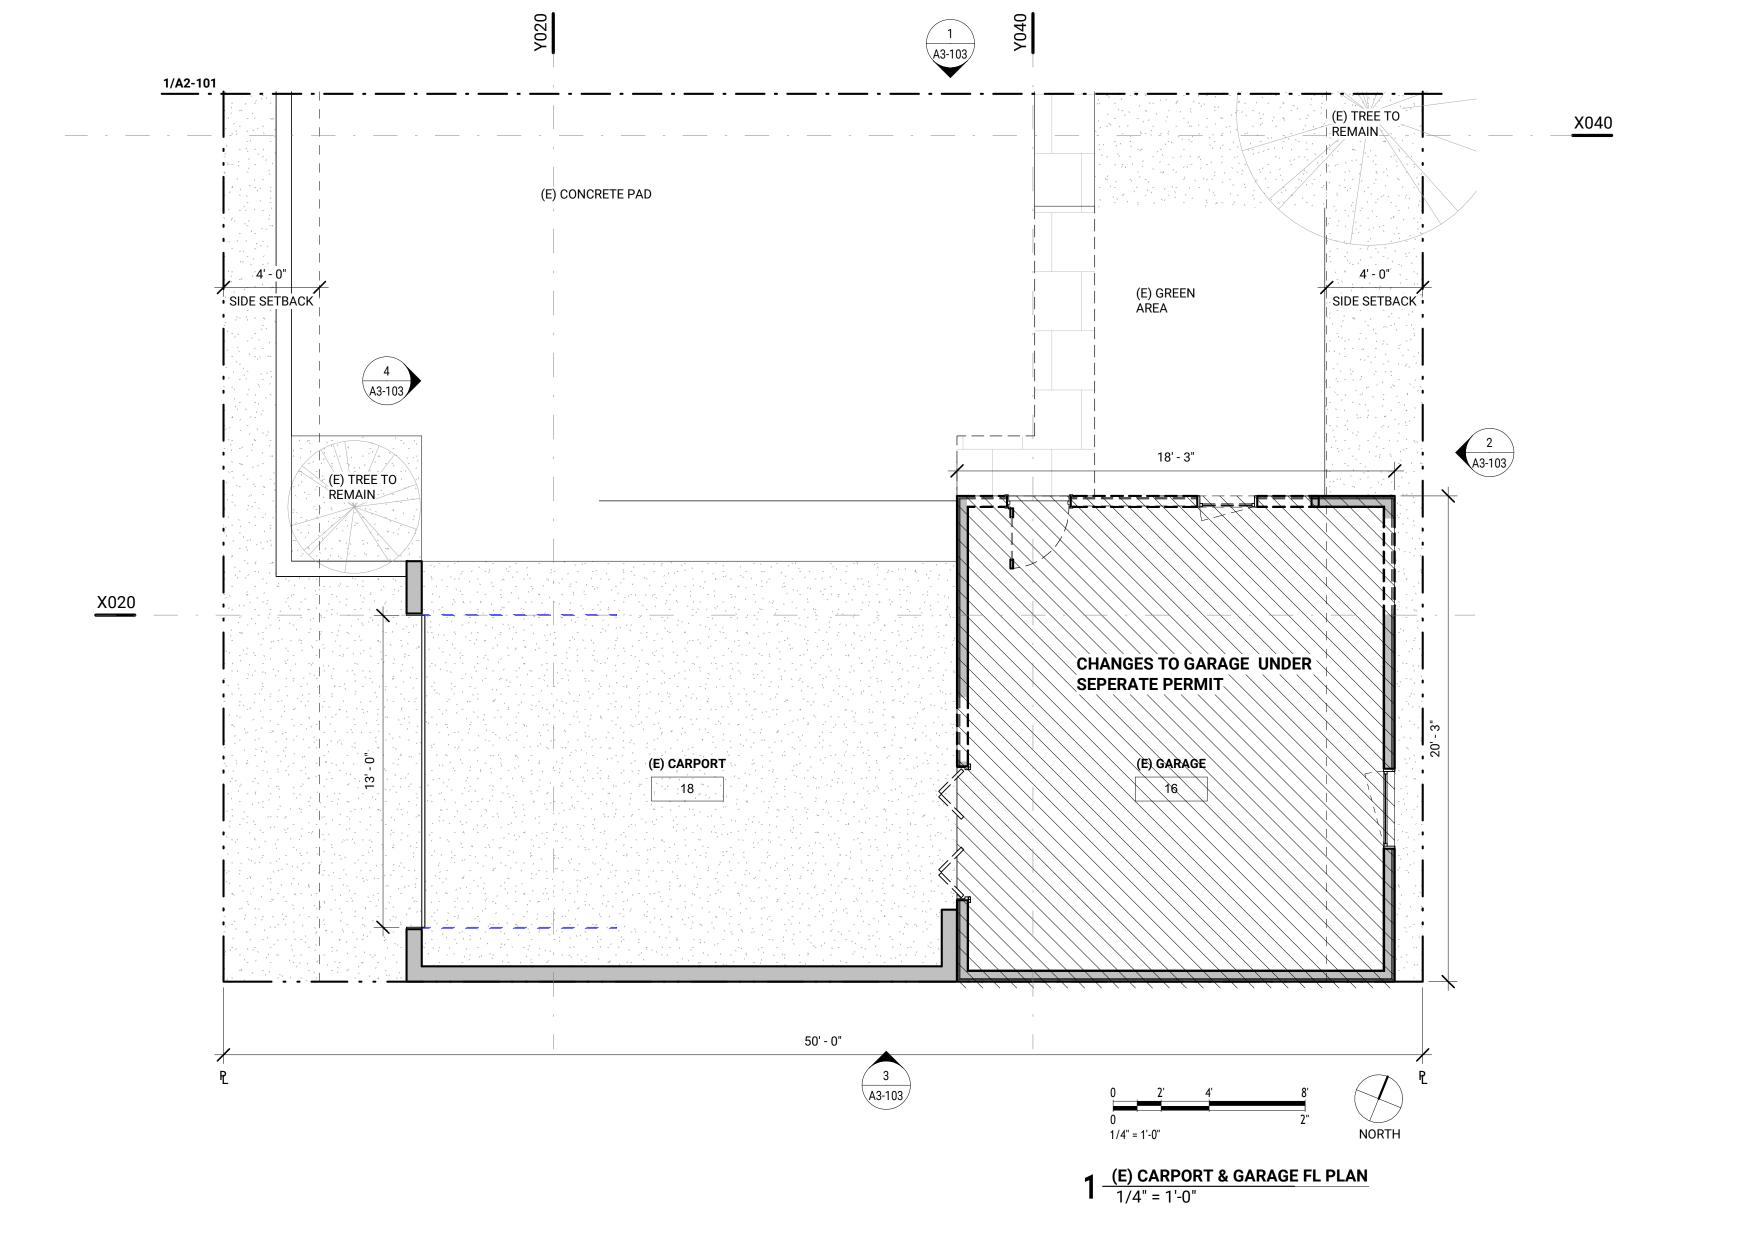

BUILDING NOTES:

- ATTIC AREA HAVING CLEAR HEADROOM OF 30" MUST HAVE AN ACCESS OPENING (22" X 30" MINIMUM). ACCESS SHALL BE LOCATED IN A HALLWAY OR OTHER READILY
- ACCESSIBLE LOCATION. IT IS NOT ALLOWED WITHIN A SMALL CLOSET SPACE. (R807.1) PROVIDE 1-HOUR-RATED ON THE UNDERSIDE OF ROOF EAVES WHERE THE FIRE SEPARATION DISTANCE BETWEEN THE EDGE OF THE PROJECTION AND THE ADJACENT PROPERTY LINE IS LESS THAN 5'. [CRC TABLE R302.1(1)]

MECHANICAL NOTES:

- 1. BATHROOMS THAT CONTAIN A TUB, SHOWER OR TUB/SHOWER MUST HAVE EXHAUST FANS CONTROLLED BY A HUMIDISTAT.
- MECHANICAL EQUIPMENT (WATER HEATERS, HVAC, ET.) UNDER SEPARATE REVIEW AND PERMITS.
- HEATER SHALL BE CAPABLE OF MAINTAINING A MINIMUM ROOM TEMPERATURE OF 68° F AT A POINT 3 FEET ABOVE THE FLOOR AND 2 FEET FROM EXTERIOR WALLS IN ALL HABITABLE ROOMS AT THE DESIGN TEMPERATURE. (CRC R303.10)
- NEW INSTALLATION OF HEAT PUMP WATER HEATERS (HPWH) SHALL HAVE ALL THE FOLLOWING:
 - A. A 240V ELECTRICAL RECEPTACLE IS WITHIN 3 FEET FROM THE WATER HEATER AND ACCESSIBLE WITH NO OBSTRUCTIONS.
 - A CONDENSATE DRAIN NO MORE THAN 2 INCHES HIGHER THAN THE BASE ON WATER HEATER FOR NATURAL DRAINING.
 - A SINGLE 240-VOLT HPWH THAT MEETSD THE REQUIREMENTS OF NEEA ADVANCED WATER HEATER SPECIFICATION.
 - THE INSTALLATION SHALL BE IN ACCORDANCE WITH MANUFACTURER'S SPECIFICATIONS.

PLUMBING NOTES:

- EFFECTIVE JAN 1, 2015 CALIFORNIA SB 407 REQUIRES REPLACEMENT OF ALL NONCOMPLIANT PLUMBING FIXTURES IN PROPERTIES BUILT ON OR BEFORE JAN, 1994 WITH WATER CONSERVING PLUMBING FIXTURES.
- SHOWER STALLS AND BATHTUB WALLS SHALL BE FINISHED WITH A NONABSORBENT SURFACE FOR A MINIMUM OF 6-0" ABOVE THE FLOOR (CBC 1210,CRC R307.2)
- CEMENT, FIBER-CEMENT, FIBER-MAT REINFORCED CEMENT, GU\SS MAT GYPSUM OR FIBER REINFORCE GYPSUM BACKERS SHALL BE USED AS A BASE FOR WALL TILE IN TUB AND SHOWER AREAS AND WALL AND CEILING PANELS IN SHOWER AREAS (CRC R702.4.2)
- SHOWERS AND TUB SHOWER COMBINATIONS SHALL HAVE VALVES THAT ARE PRESSURE BALANCING AND THERMOSTATIC. (CPC 408.3)
- MAXIMUM FLOW RATES FOR ALL PLUMBING FIXTURES PER CGBSC 4.303:
- WATER CLOSETS SHALL NOT EXCEED 1.28 GALLONS PER FLUSH. SHOWERHEADS SHALL HAVE A MAXIMUM FLOW RATE OF 2.0 GALLONS PER
- LAVATORY FAUCETS SHALL NOT EXCEED 1.2 GALLONS PER MINUTE AT 60 PSI
- KITCHEN FAUCETS SHALL NOT EXCEED 1.8 GALLONS PER MINUTE AT 60 PSI
- WATER CLOSET SHALL BE SET NO CLOSER THAN 15" FROM IT'S CENTER TO ANY SIDE WALL OR OBSTRUCTIN OR NO CLOSER THAN 30' CENTER TO CENTER TO ANY SIMILAR FIXTURE AND THE CLEAR SPACE IN FRONT OF A WATER CLOSET, LAVATORY, OR A BIDET SHALL BE AT LEAST 24" CPC 402.5 SHOW ON FLOOR PLAN.
- A SHOWER OR TUB EQUIPPED WITH A SHOWERHEAD SHALL HAVE A MINIMUM OF 6'-8" CEILING HEIGHT ABOVE A MINIMUM AREA OF 30" X 30" AT THE SHOWERHEAD (CRC R305.1 EXCEPTIONS 2)
- BATHROOMS, WATER CLOSET COMPARTMENTS AND OTHER SIMILAR ROOMS SHALL BE PROVIDED WITH MECHANICAL VENTILATION CAPABLE OF 50 CFM EXHAUSTED DIRECTLY TO THE OUTSIDE REGARDLESS OF NATURAL VENTILATION AND FENESTRATION SUCH AS WINDOWS AND DOORS. (CRC R303.3)
- ALL NEW WATER HEATER IN ALL NEWLY CONSTRUCTED SFD/ADU'S SHALL BE AN "ALL ELECTRIC APPLIANCE/EQUIPMENT" IN COMPLIANCE THE CITY OF GLENDALE REACH CODE ORDINANCE NO. 5999. COORDINATE WITH TITLE-24COMPLIANCE FORMS.

AGING-IN-PLACE DESIGN NOTES:


- ELECTRICAL RECEPTACLE OUTLETS, SWITCHES AND CONTROLS INTENDED TO BE USED BY OCCUPANTS SHALL BE LCATED NO MORE THAN 48" MEASURED FROM THE TOP OF THE OUTLET BOX AND NOT LESS THAN 15" MEASURED FROM THE BOTTOM OF THE OUTLET BOX. ABOVE THE FINISH FLOOR.
- SPECIFY DOORBELL CONTROLS TO NOT EXCEED 48" ABOVE EXTERIOR FLOOR, MEASURED FROM THE TOP OF THE DOORBELL BUTTON ASSEMBLY.
- INFORMATION AND/OR DRAWINGS DRAWINGS IDENTIFIYING THE LOCATION OF GRAB BAR REINFORCEMENT SHALL BE PLACED IN THE OPERATIONAL AND MAINTENANCE MANUAL IN ACCORDANCE WITH THE CALIFORNIA BUILDING.

SMOKE ALARM REQ:

SMOKE ALARMS SHALL COMPLY WITH SPECIFIC LOCATION REQUIREMENTS PER NFPA 72 SECTION 29.8.3.4. (CRC R314.3.3, CBC 907.2.11.8)

STANDARDS CODE, CHAPTER 4, DIVISION 4.4.

- A. AN APPROVED SMOKE ALARM SHALL BE INSTALLED FOR NEW CONSTRUCTION AND ALTERATION, REPAIR OR ADDITIONS REQUIRING PERMIT EXCEEDING \$1000. (CRC
- R14.8.2) BATTERY OPERATED SMOKE ALARMS PERMITTED IN EXSITING BUILDINGS WHERE NO COSTRUCTION IS TAKING PLACE OR IN BUILDING INDERGOING ALTERATION OR REPAIR THAT DO NOT RESULT IN THE REMOVAL OF INTERIOR WALLS OR CEILING FINISHES, UNLESS THERE IS AN ATTIC, CRAWL SPACE OR BASEMET WHICH COULD PROVIDE
- ACCESS FOR WIRING. (CRC R314.6 EXCEPTIONS 1, 3, CBC 907.2.11.9) SMOKE ALARMS SHALL BE INTERCONNECTED SUCH THAT THE ACTIVATION OF ONE ALARM WILL ACTIVATE ALL ALARMS IN THE INDIVIDUAL DWELLING UNIT. (CRC R314.4,
- SMOKE DETECTORS SHALL BE "HARD WIRED" AND SHALL BE EQUIPPED WITH BATTERY BACKUP. (CRC R314.6, CBC 907.12.6, CBC 907.2.11.9)

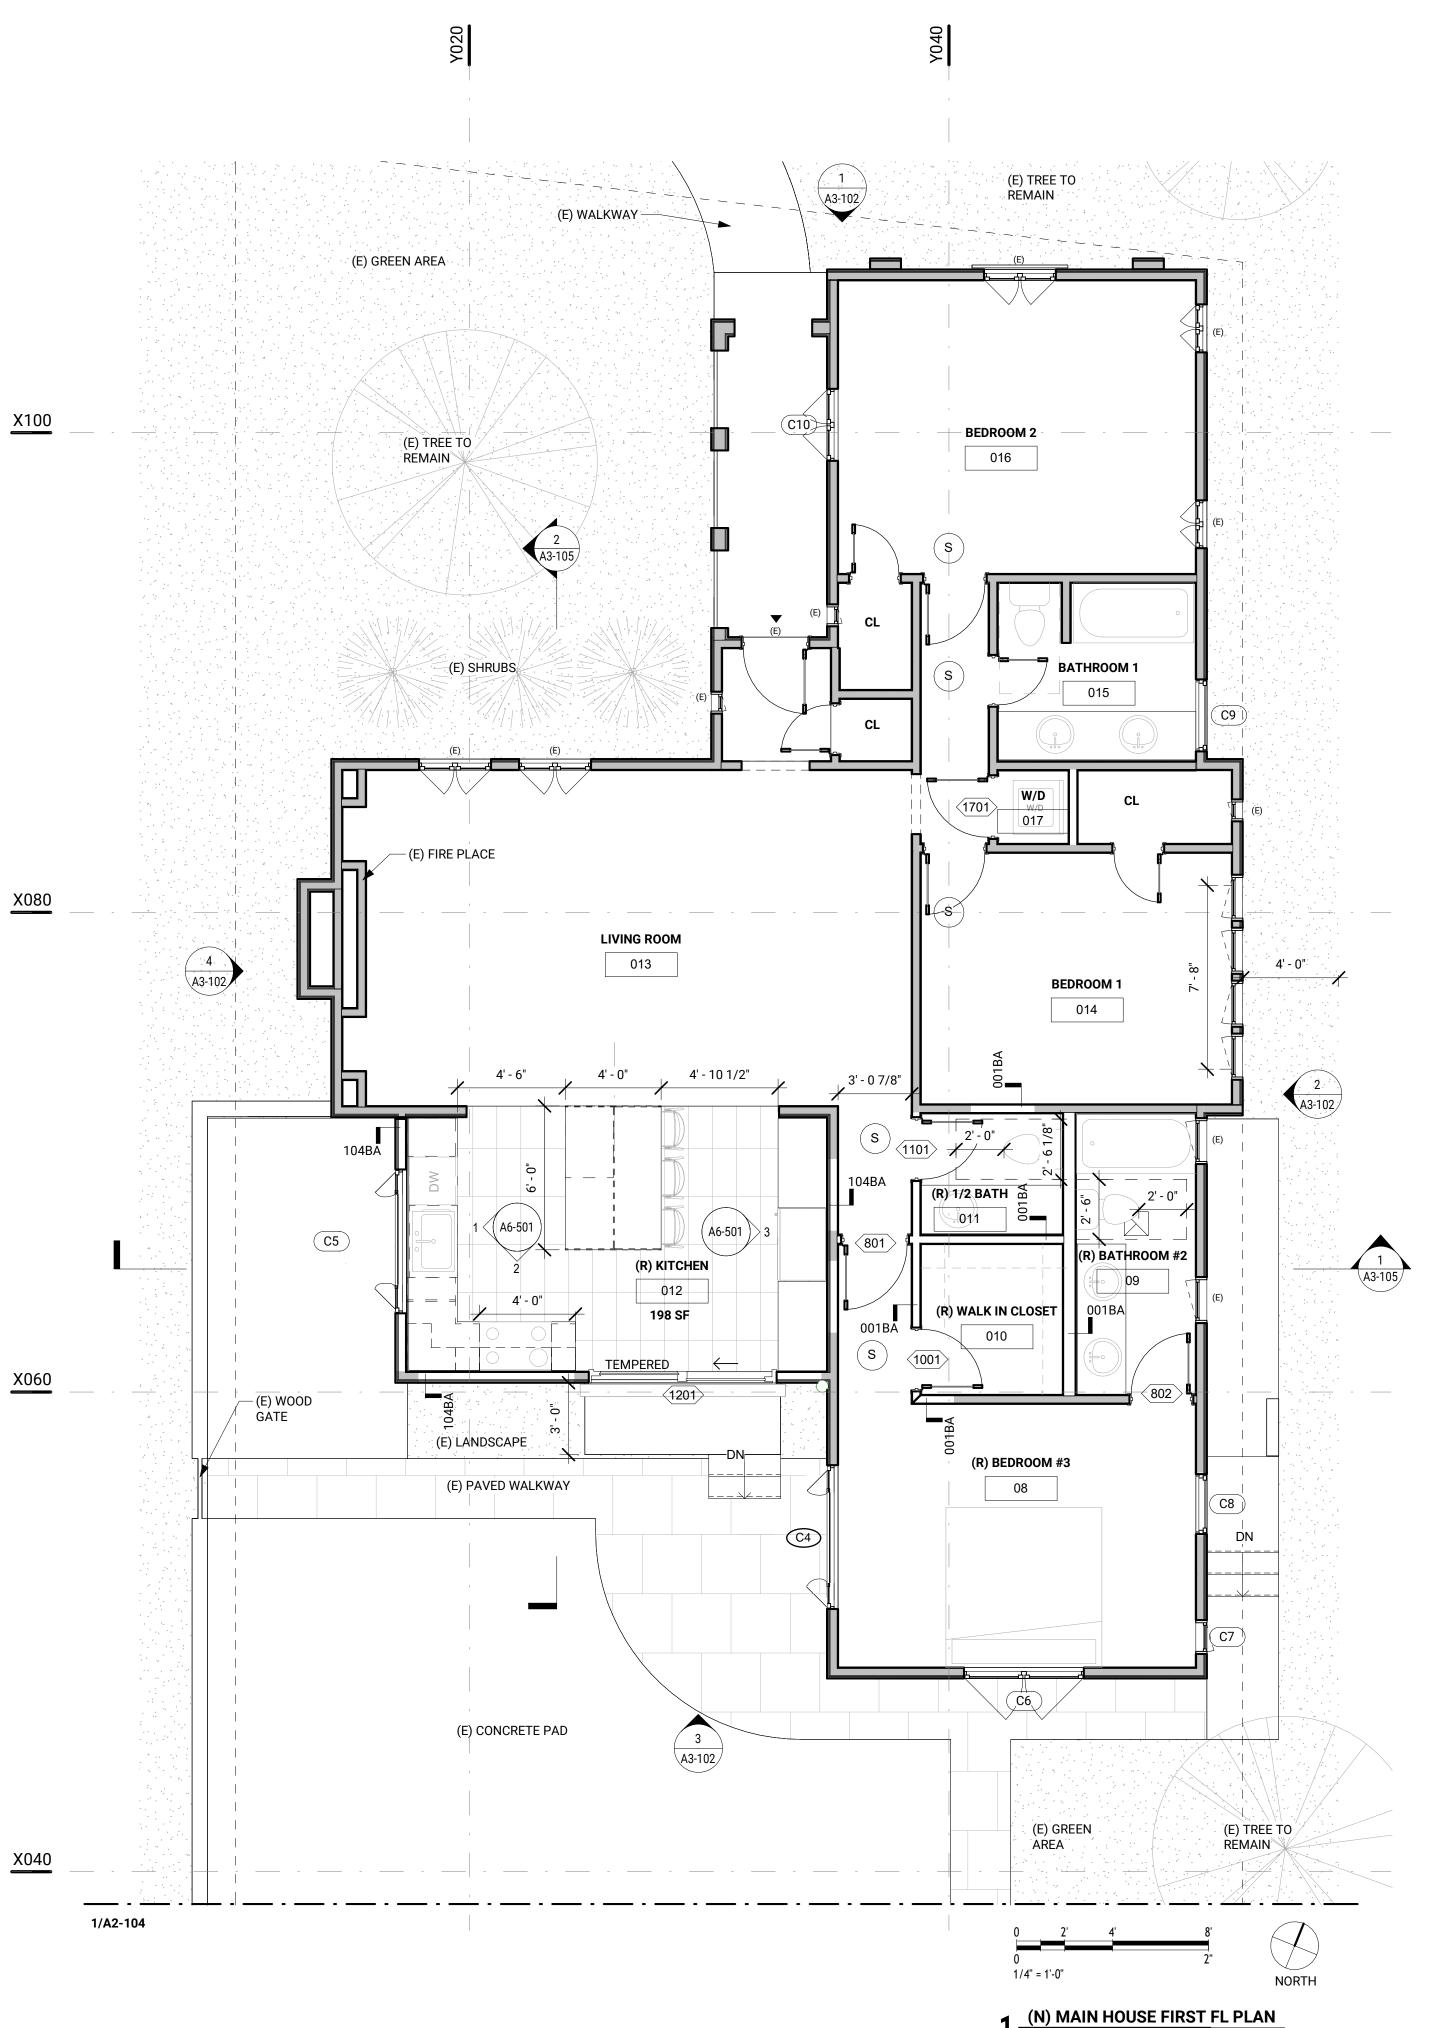

LEGEND:

NEW WALL DEMO WALL EXISTING WALL PROPERTY LINE

ROOF OVERHEAD SETBACK LINE **NEW ADDITION** 1HR RATED PARTITION, SEE A6-302

PARTITION TAG. REFER TO SHEET A6-301 LANDSCAPE AREA

GENERAL NOTES:

- THE CONSTRUCTION SHALL NOT RESTRICT A FIVE- FOOT CLEAR AND UNOBSTRUCTED ACCESS TO ANY WATER OR POWER DISTRIBUTION FACILITIES (POWER POLES, PULL-BOXES, TRANSFORMERS, VAULTS, PUMPS, VALVES, METERS, APPURTENANCES, ETC.) OR TO THE LOCATION OF THE HOOK-UP. THE CONSTRUCTION SHALL NOT BE WITHIN TEN FEET OF ANY POWER LINES WHETHER OR NOT THE LINES ARE LOCATED ON THE PROPERTY. FAILURE TO COMPLY MAY CAUSE CONSTRUCTION DELAYS AND/OR ADDITIONAL EXPENSES.
- AN APPROVED SEISMIC GAS SHUTOFF VALVE WILL BE INSTALLED ON THE FUEL GAS LINE ON THE OWN STREAM SIDE OF THE UTILITY METER AND BE RIGIDLY CONNECTED TO THE EXTERIOR OF THE BUILDING OR STRUCTURE CONTAINING THE FUEL GAS PIPING. (PER ORDINANCE 170,158) (SEPARATE PLUMBING PERMIT IS
- PLUMBING FIXTURES ARE REQUIRED TO BE CONNECTED TO A SANITARY SEWER OR TO AN APPROVED SEWAGE DISPOSAL SYSTEM. R306.3
- BATHTUB AND SHOWER FLOORS, WALLS ABOVE BATHTUBS WITH A SHOWERHEAD, AND SHOWER COMPARTMENTS SHALL BE FINISHED WITH A NONABSORBENT SURFACE. SUCH WALL SURFACES SHALL EXTEND TO A HEIGHT OF NOT LESS THAN 6 FEET ABOVE THE FLOOR. R307.2
- KITCHEN SINKS, LAVATORIES, BATHTUBS, SHOWERS, BIDETS, LAUNDRY TUBS AND WASHING MACHINE OUTLETS SHALL BE PROVIDED WITH HOT AND COLD WATER AND CONNECTED TO AN APPROVED WATER SUPPLY. R306.4
- PROVIDE ULTRA-LOW FLUSH WATER CLOSETS FOR ALL NEW CONSTRUCTION. EXISTING SHOWER HEADS AND TOILETS MUST BE ADAPTED FOR LOW WATER CONSUMPTION.
- UNIT SKYLIGHTS SHALL BE LABELED BY A LA CITY APPROVED LABELING AGENCY. SUCH LABEL SHALL STATE THE APPROVED LABELING AGENCY NAME, PRODUCT DESIGNATION AND PERFORMANCE GRADE RATING. (RESEARCH REPORT NOT REQUIRED). R308.6.9
- WATER HEATER MUST BE STRAPPED TO WALL. SEC. 507.3, LAPC
 - SMOKE DETECTORS SHALL BE PROVIDED FOR ALL DWELLING UNITS INTENDED FOR HUMAN OCCUPANCY, WHERE A PERMIT IS REQUIRED FOR ALTERATIONS, REPAIRS, OR ADDITIONS. R314.2
 - WHERE A PERMIT IS REQUIRED FOR ALTERATIONS, REPAIRS OR ADDITIONS, EXISTING DWELLINGS OR SLEEPING UNITS THAT HAVE ATTACHED GARAGES OR FUEL-BURNING APPLIANCES SHALL BE PROVIDED WITH A CARBON MONOXIDE ALARM IN ACCORDANCE WITH SECTION R315.2. CARBON MONOXIDE ALARMS SHALL ONLY BE REQUIRED IN THE SPECIFIC DWELLING UNIT OR SLEEPING UNIT FOR WHICH THE PERMIT WAS OBTAINED. R315.2
- VERY SPACE INTENDED FOR HUMAN OCCUPANCY SHALL BE PROVIDED WITH NATURAL LIGHT BY MEANS OF EXTERIOR GLAZED OPENINGS IN ACCORDANCE TO SECTION R303.1 OR SHALL BE PROVIDED WITH ARTIFICIAL LIGHT ADEQUATE TO PROVIDE AN AVERAGE ILLUMINATION OF 6 FOOT-CANDLES OVER THE AREA OF THE ROOM AT A HEIGHT OF 30 INCHES ABOVE THE FLOOR LEVEL. R303.1
- A COPY OF THE EVALUATION REPORT AND/OR CONDITIONS OF LISTING SHALL BE MADE AVAILABLE AT THE JOB SITE.
- THE EXTERIOR DOOR MUST OPEN OVER A MIN. 36" LANDING NOT MORE THAN 1.5" BELOW THE THRESHOLD. EXCEPTION: PROVIDING THE DOOR DOES NOT SWING OVER THE LANDING. LANDING SHALL BE NOT MORE THAN 7.75" BELOW THE THRESHOLD. STORM AND SCREEN DOORS ARE PERMITTED TO SWING OVER ALL EXTERIOR STAIRS AND LANDINGS. (R311.3.1)
- 14. ALL DOORS AND WINDOWS SHALL MEET CITY OF GLENDALES SECURITY ORDINANCE
- ASPHALT SHINGLES SHALL MEET THE CLASSIFICATION REQUIREMENTS OF CRC T-R905.2.4.1 OR CBC T-150.1.1 FOR THR APPROPRIATE MAXIMUM BASIC WIND

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OWNER


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PROJECT ADDRESS:

926 E DRYDEN STREET GLENDALE, CALIFORNIA 91207

ADDITION AND REMODEL

(N) MAIN HOUSE **FLOOR PLAN**

PERMIT #: BSFD-018869-2024

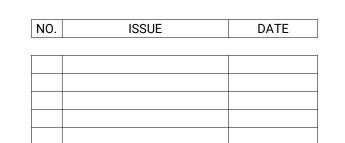PLANNING #: PMPA-003557-2024

ORIGINAL SHEET SIZE: 24" x 36"

PROJECT: 2024-008


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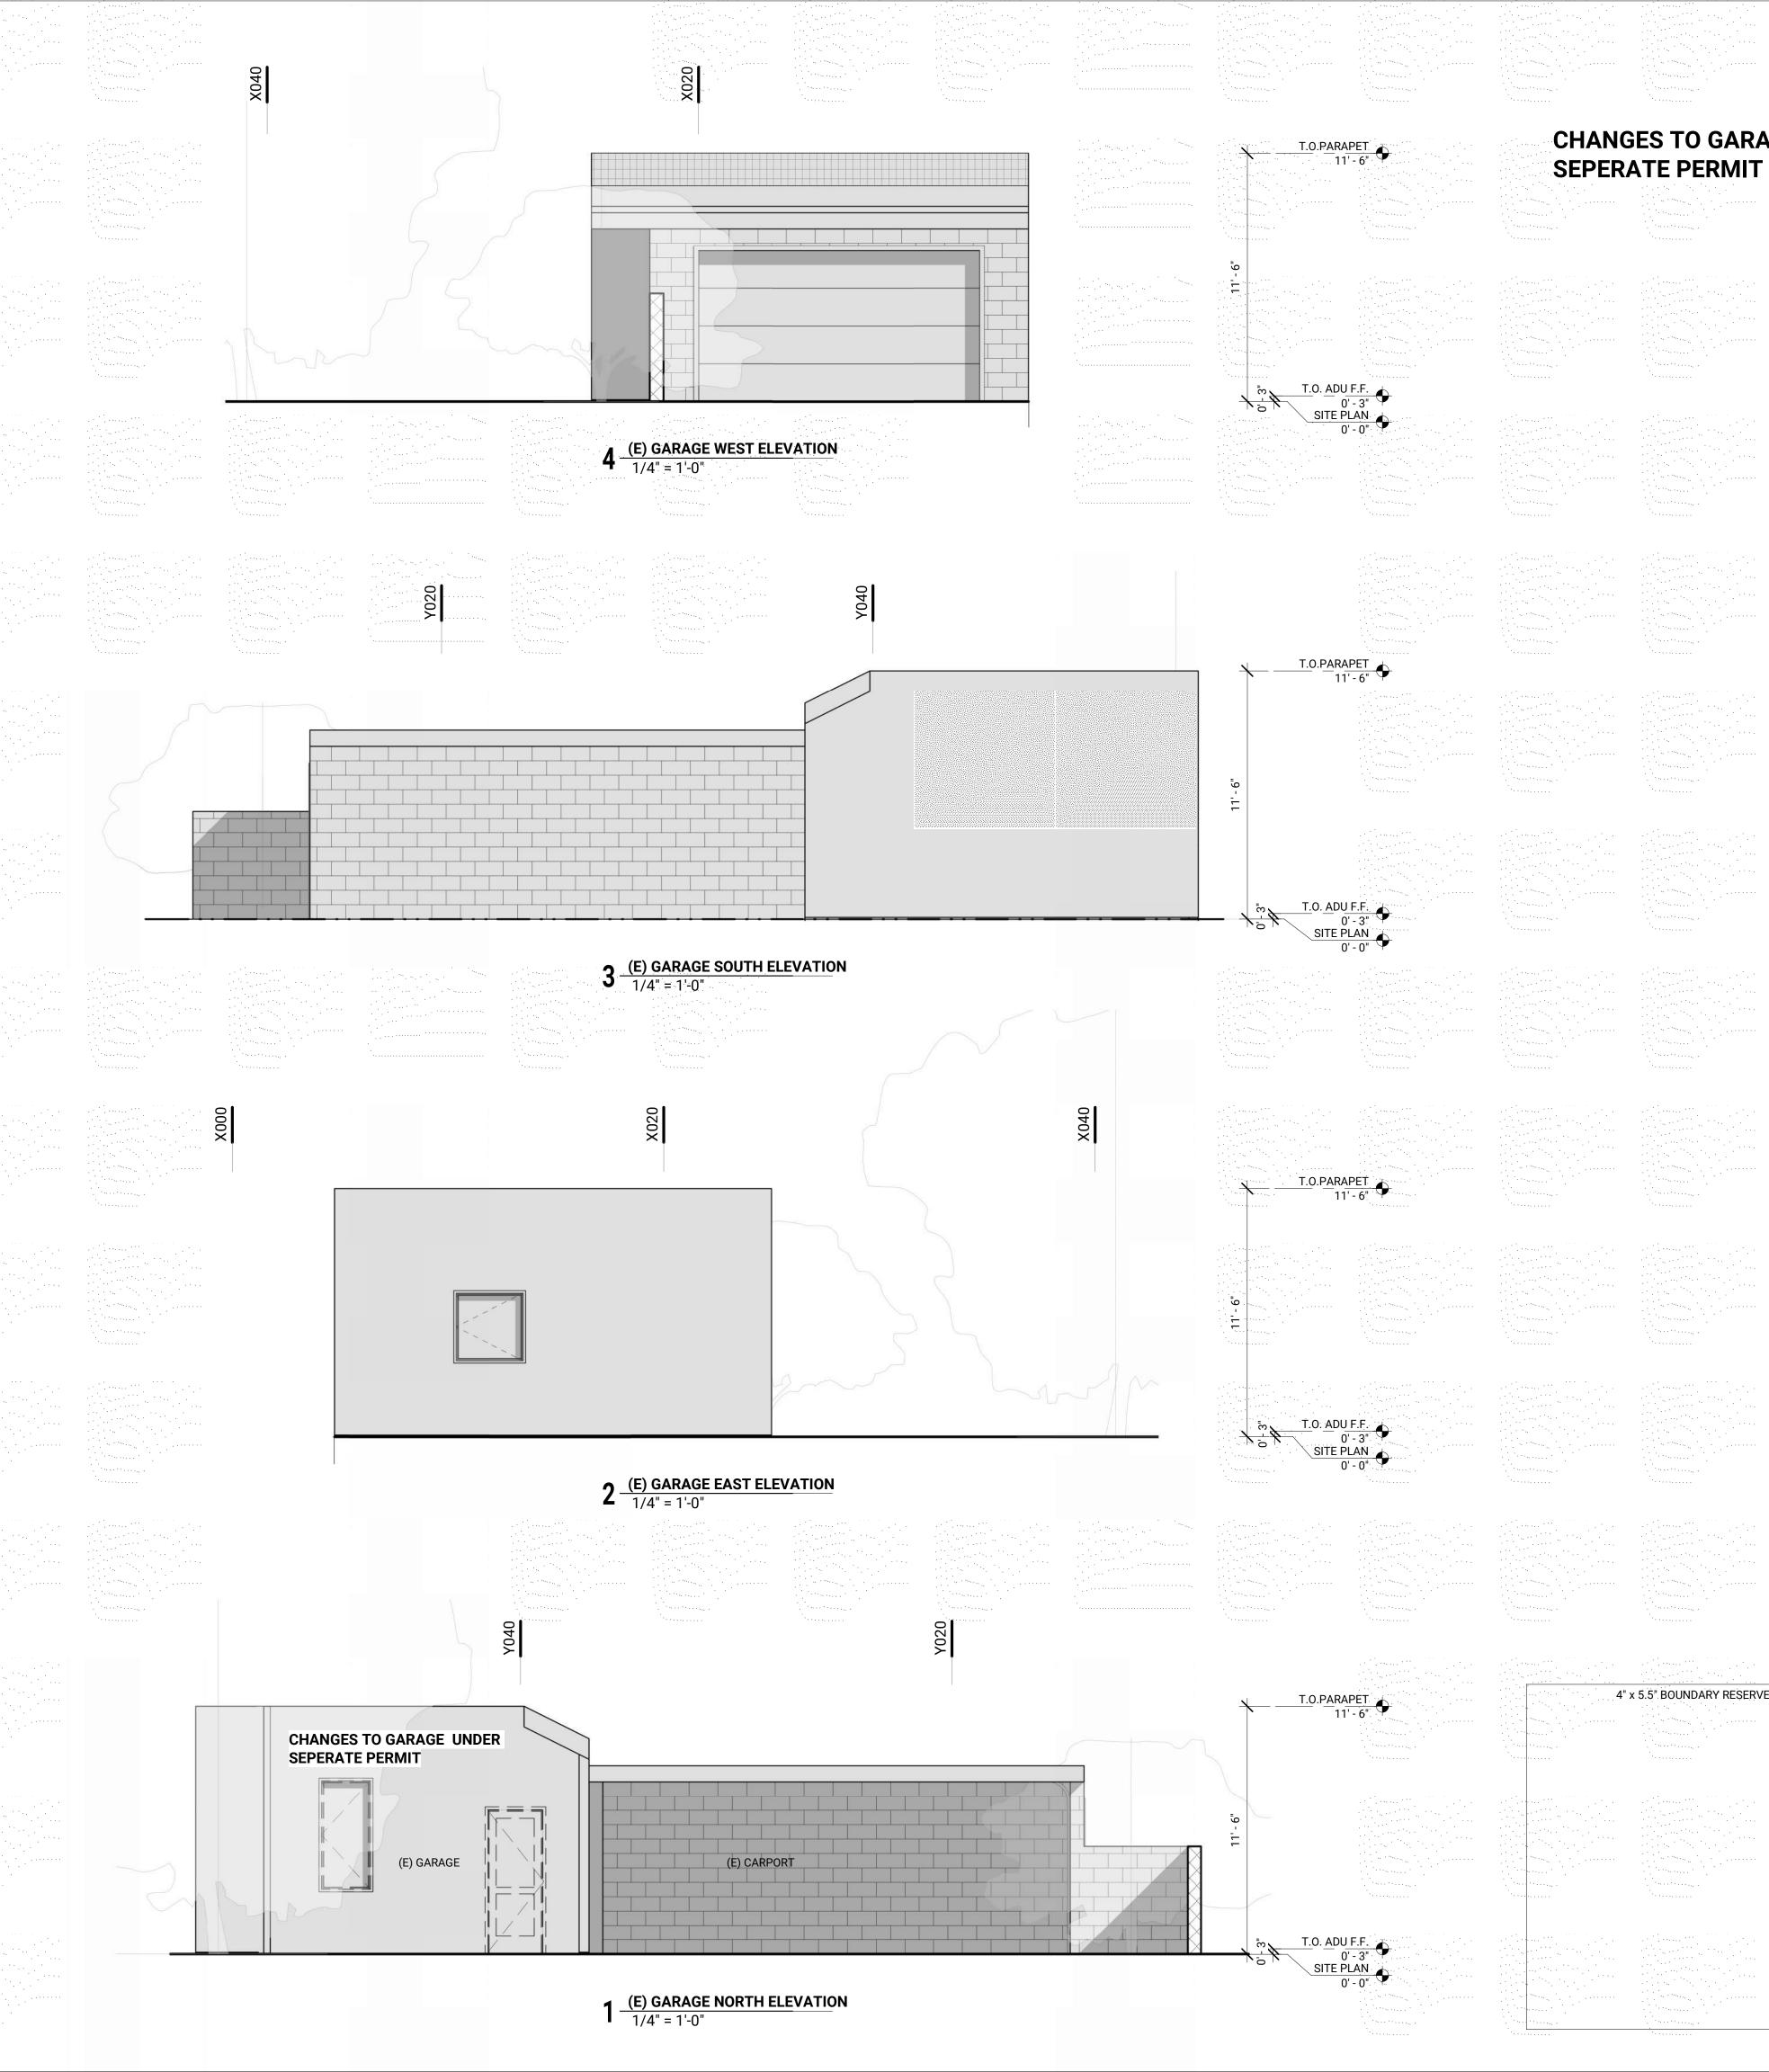
10/23/2024

SHEET NUMBER:

DATE:





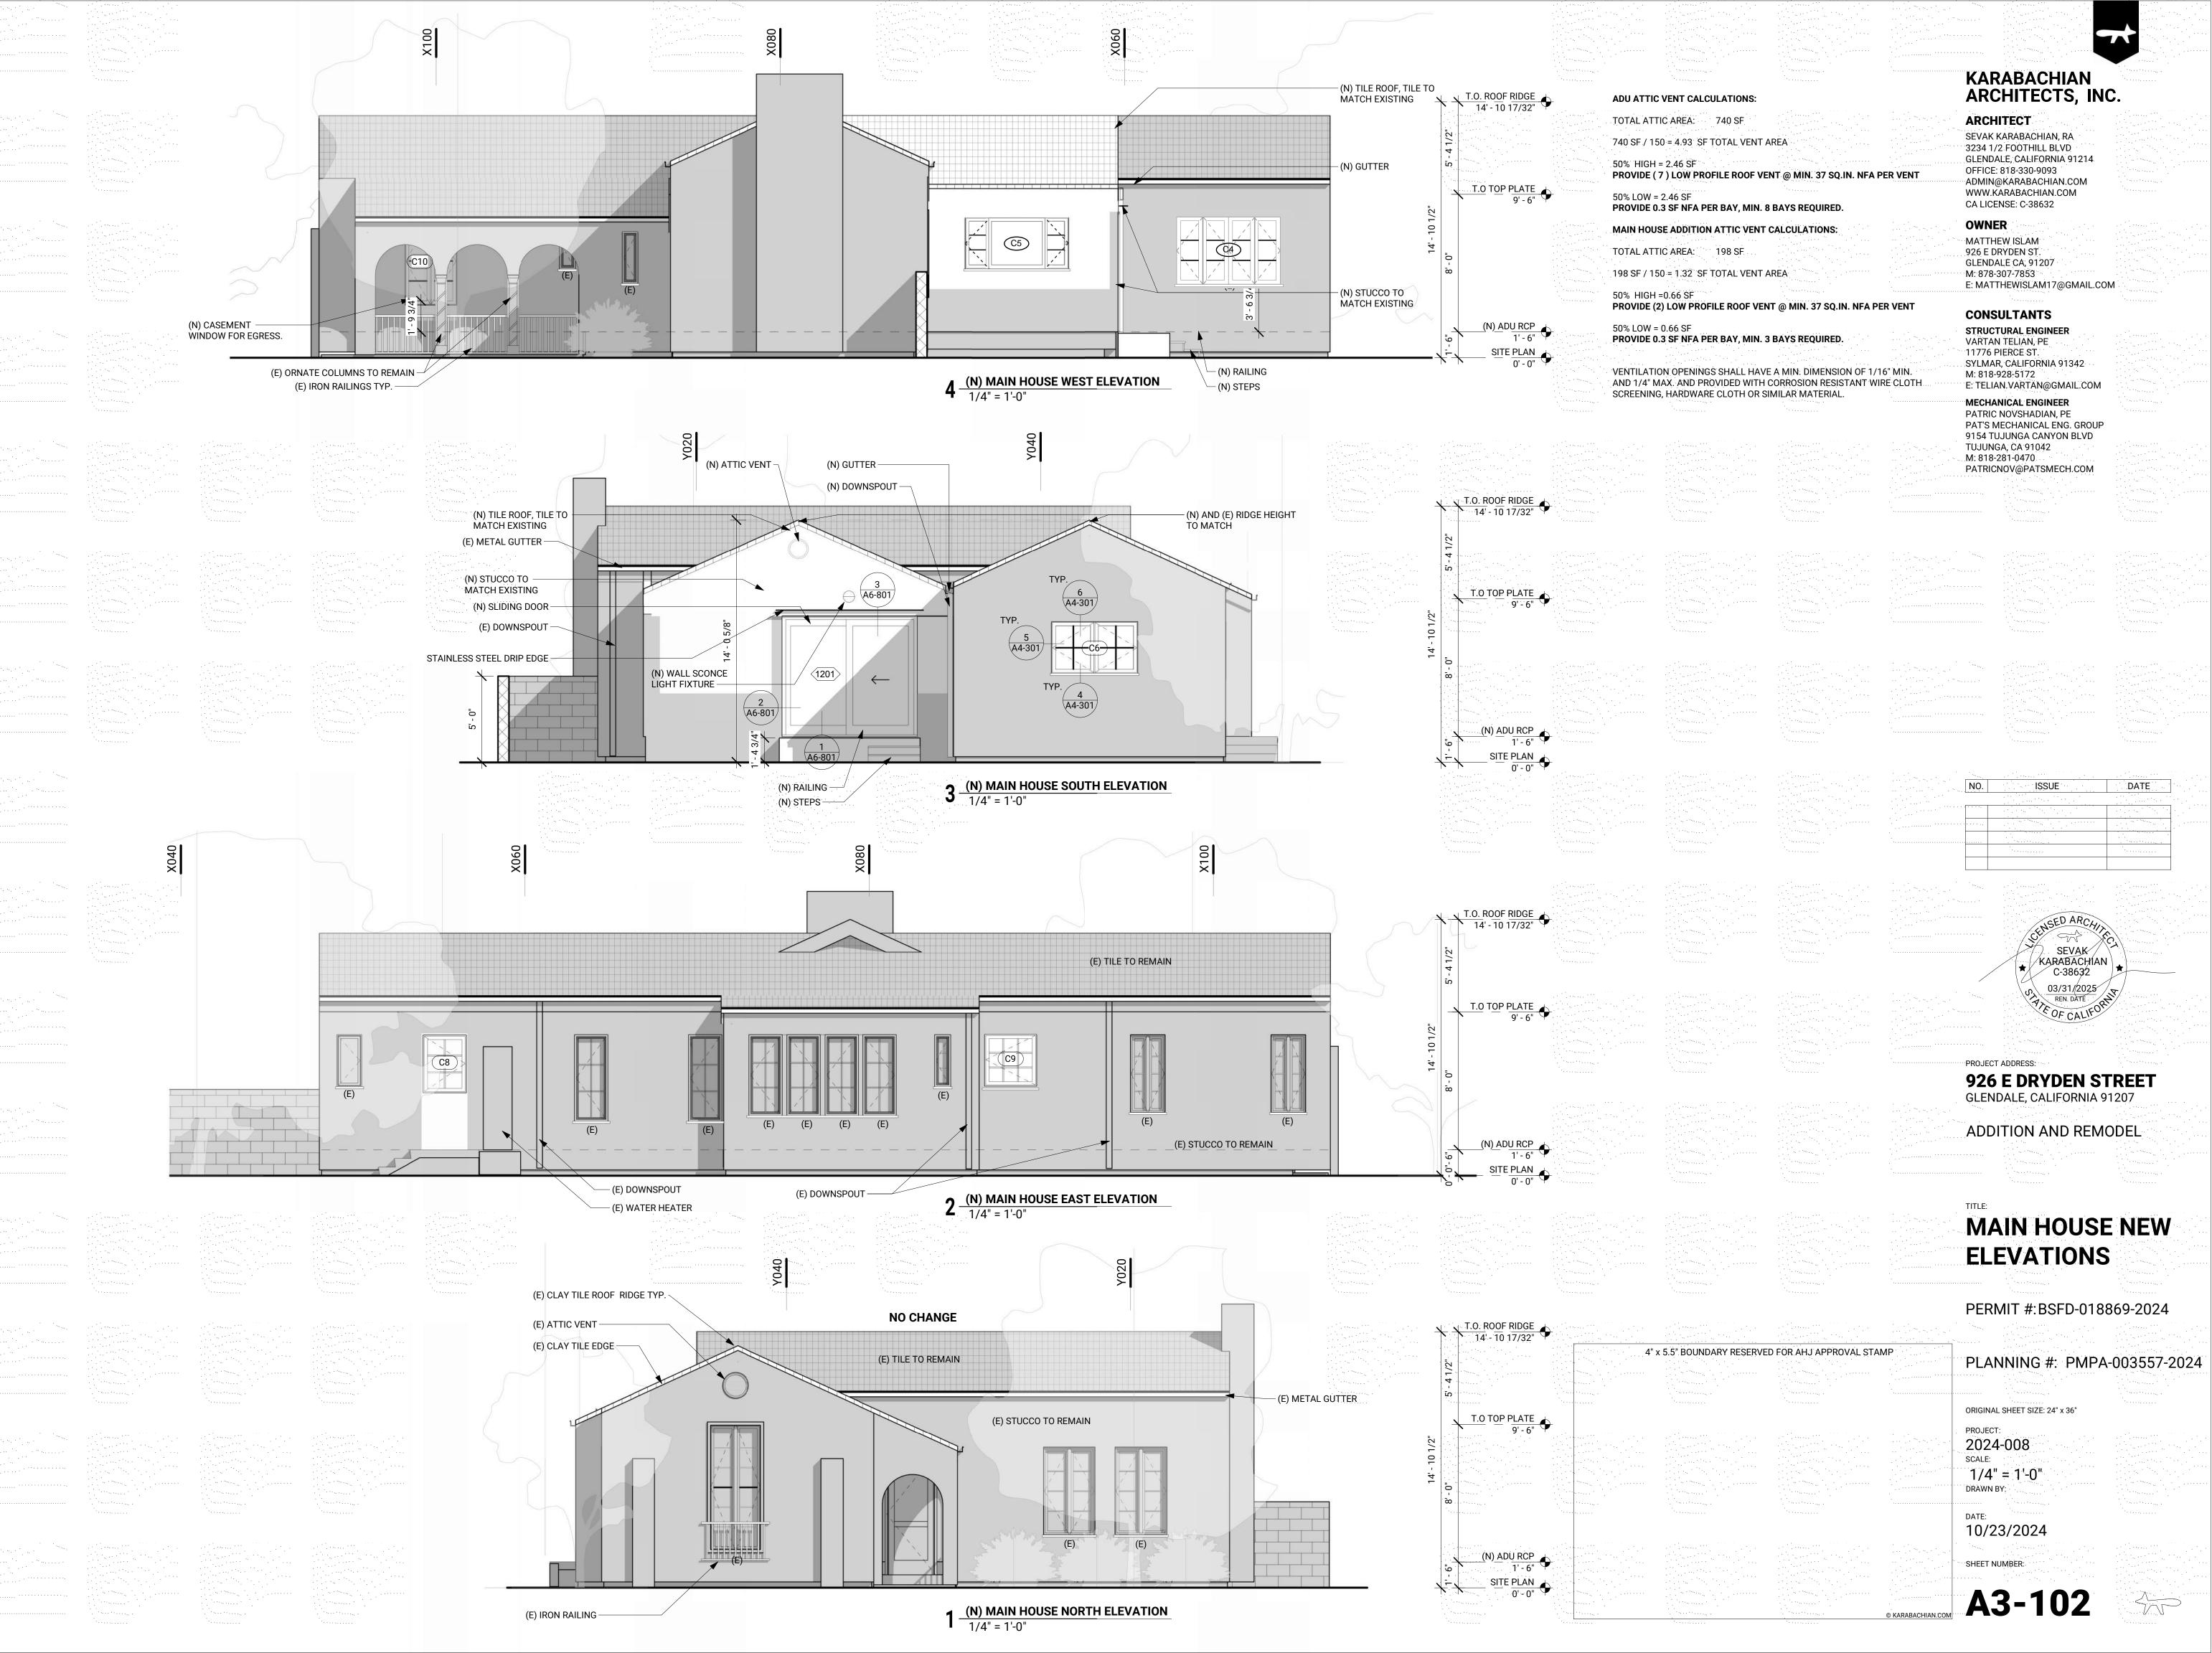

CHANGES TO GARAGE/ADU UNDER

KARABACHIAN ARCHITECTS, INC.

ARCHITECT SEVAK KARABACHIAN, RA

3234 1/2 FOOTHILL BLVD GLENDALE, CALIFORNIA 91214 OFFICE: 818-330-9093 ADMIN@KARABACHIAN.COM WWW.KARABACHIAN.COM CA LICENSE: C-38632

OWNER MATTHEW ISLAM 926 E DRYDEN ST. GLENDALE CA, 91207 M: 878-307-7853


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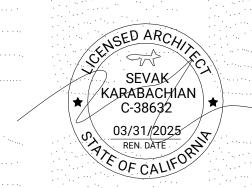
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PATRICNOV@PATSMECH.COM





926 E DRYDEN STREETGLENDALE, CALIFORNIA 91207

ADDITION AND REMODEL

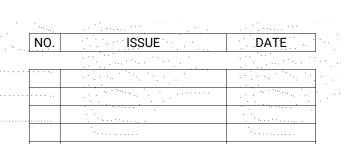EXISTING GARAGE ELEVATIONS

PERMIT #:BSFD-018869-2024

PLANNING #: PMPA-003557-2024 ORIGINAL SHEET SIZE: 24" x 36" PROJECT:

2024-008 1/4" = 1'-0"

10/23/2024

A3-103



KARABACHIAN ARCHITECTS, INC. **ARCHITECT**

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OWNER


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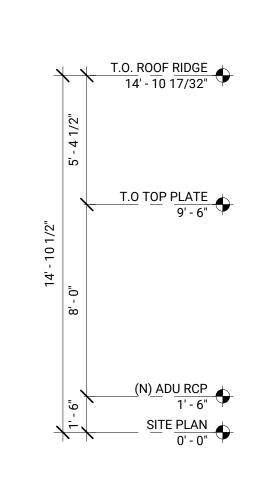
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MECHANICAL ENGINEER

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4" x 5.5" BOUNDARY RESERVED FOR AHJ APPROVAL STAMP

T.O. ROOF RIDGE 14' - 10 17/32"

T.0 TOP PLATE 9' - 6"

(N) ADU RCP 1' - 6"

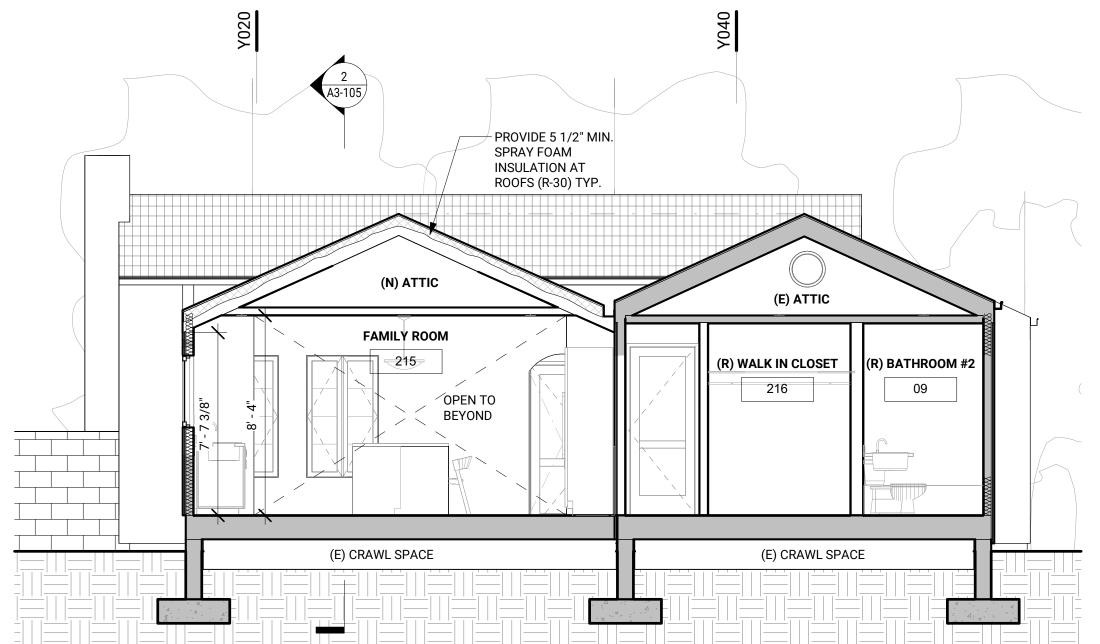ISSUE

DATE



926 E DRYDEN STREET GLENDALE, CALIFORNIA 91207 ADDITION AND REMODEL

BUILDING SECTIONS

PERMIT #:BSFD-018869-2024

PLANNING #: PMPA-003557-2024


ORIGINAL SHEET SIZE: 24" x 36" PROJECT: 2024-008


As indicated

10/23/2024

SHEET NUMBER:

A3-105

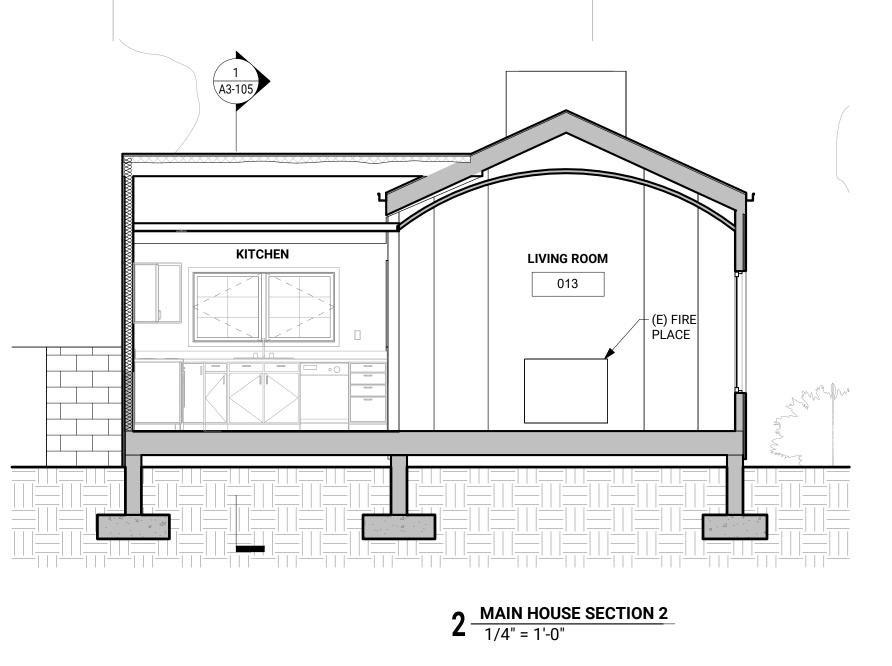

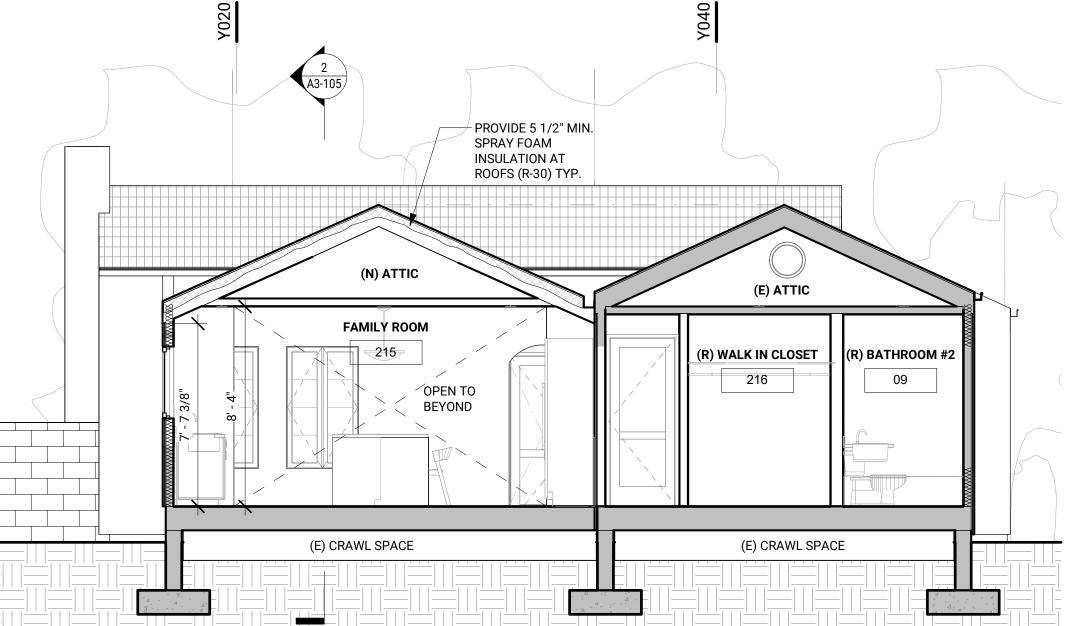

 $1 \frac{\text{MAIN HOUSE SECTION 1}}{1/4" = 1'-0"}$



VALUE USED TO DETERMINE FOAM THICKNESS FOR ROOF

INSULATION BASED ON TITLE 24 (SHEET A0-2XX)

FRAME TYPE			CAVITY INSUL.
WOOD	METAL	CONCRETE	
X			R-24 SPRAY FOAM
X			R-30 SPRAY FOAM
Х			R-24
Х			R-21
X			R-15
		Х	R-11
	X X X X X	WOOD METAL X X X X X X	WOOD METAL CONCRETE X X X X X X

FOAM-LOK[™] 2000 3G Closed-Cell Spray Insulation

on	
and Design	Physic

FOAM-LOK*
SPRAY FOAM INSULATION

Product Use and Design	
FOAM-LOK** 2000 3G is a Closed-Cell spray applied foam that delivers high R-value, which when installed following application guidelines adheres tenaciously to framing members and substrates. FOAM-LOK** 2000 3G Closed-Cell spray foam provides superior energy economy and durability while significantly reducing unmanaged moisture and air infiltration.	
As a component of a "systems approach" to proper building envelope construc- tion, FOAM-LOK" 2000 3G Closed-Cell spray foam provides exceptional performance in minimizing heat transfer, moisture gain, air leakage, and im- proving racking strength.	
TVDE-LU III IV V (AAD) Comptonedies	

	minimizing heat transfer, m strength.	
	/, V (A&B) Construction Product Applications	
alls ucts inks oors ping	Ceilings Freezers Foundations Cold Storage Concrete Slabs	Vented Attics Unvented Attics Vented Crawlspa Unvented Crawls


I, IV, V (A&B) Construction ded Product Applications		Tensile Strength	ASIM D1623	40 lb/in*
		Water Vapor Transmission	ASTM E96	.98 perms @ 1.5"
· Ceilinas	• Vented Attics	Water Resistance Barrier	ICC-ES AC71	1.25"
· Freezers	· Unvented Attics	Water Absorption	ASTM D2842	1.8%
Foundati Cold Store	age Unvented Crawlspaces	Dimensional Stability 7 days at 158°F, 98%RH	ICC-ES AC71 ASTM D2842 ASTM D2126 ASTM E119 NFPA 259 ASTM C 1338	9.0%
Concrete Slabs led Processing Parameters		Commercial Fire Resistance	ASTME119	1, 2 & 3 Hour Ratings*
		Flammability	NFPA 259	1885 Btu/ft² 21.5 M
-	Processing Parameters	Fungus Testing	ASTM C 1338	No Growth
Dynamic Pressure	1,000 - 1,400 psi	*For specific construction re please contact lcynene-Lapo	guirement of ASTI	M E119 and NFPA 285
nperature	25 - 122 °F (-4 - 50°C)	FOAM-LOK TM 2000 3G meet		

Equipment Dynamic Pressure	1,000 - 1,400 psi	*For specific construction rec please contact Icynene-Lapol	guirement of ASTM E119 and NFPA 285 testi la Technical Group or your sales representative
Ambient Temperature	25 - 122 °F (-4 - 50°C)	FOAM-LOK [™] 2000 3G meets ASTM C1029 Type II classification.	
Preheat Temperature	65 - 85°F (18 - 30°C)	Credentials/Certifications	
Hose Heat Temperature	115 - 125°F (46 - 51°C)	• ICC ESR-4501	
Drum Storage Temperature	65 - 85°F (18 - 30°C)	FOAM-LOK™ 2000 3G is a Class I formulation, as Tested per AST	
Shelf Life:	12 months when stored properly.	and at a thickness of 3.5 inch shown below: (UL 723, NFPA	nes possesses the flammability characteristics 255, UBC 8-1)
Optimum hose pressure and temp	erature may vary as a function of the type of	ASTM Method E84	Class I

is li	the responsibility of the applicator to properly interpret equipment technical terature, particularly information that relates acceptable combinations of un chamber size, proportioner output, and material pressures.
	2:1 transfer pumps are recommended for material transfer from container

٠	CAUTION: Extreme care must be taken when removing and reinstalling
	drum transfer pumps so as NOT to reverse the "A" and "B" components.
•	Donot circulate or mix other suppliers "A" or "B" component into FOAM-LOK " containers.
	The plural component proportioner must be capable of supplying each

		$\overline{}$	*NFPA 286		
tilation Rate hanges Per Hour)	Sprayers, Helpers, Informed	Re-Occupancy Period	Location	SPF Thickness *	
t 40.0 ACH	Trade Workers & Contractors	TOTAL GUILET	Wall Cavities	Up to 12 in (305mm)	
	1 Hour	2 Hours	Ceiling Cavities	Up to 12 in (305mm)	
	- 1			t be covered with 1/2" of gypsum board, or D or Fireshell F10E intumescent paint coating at a rmal barrier.	

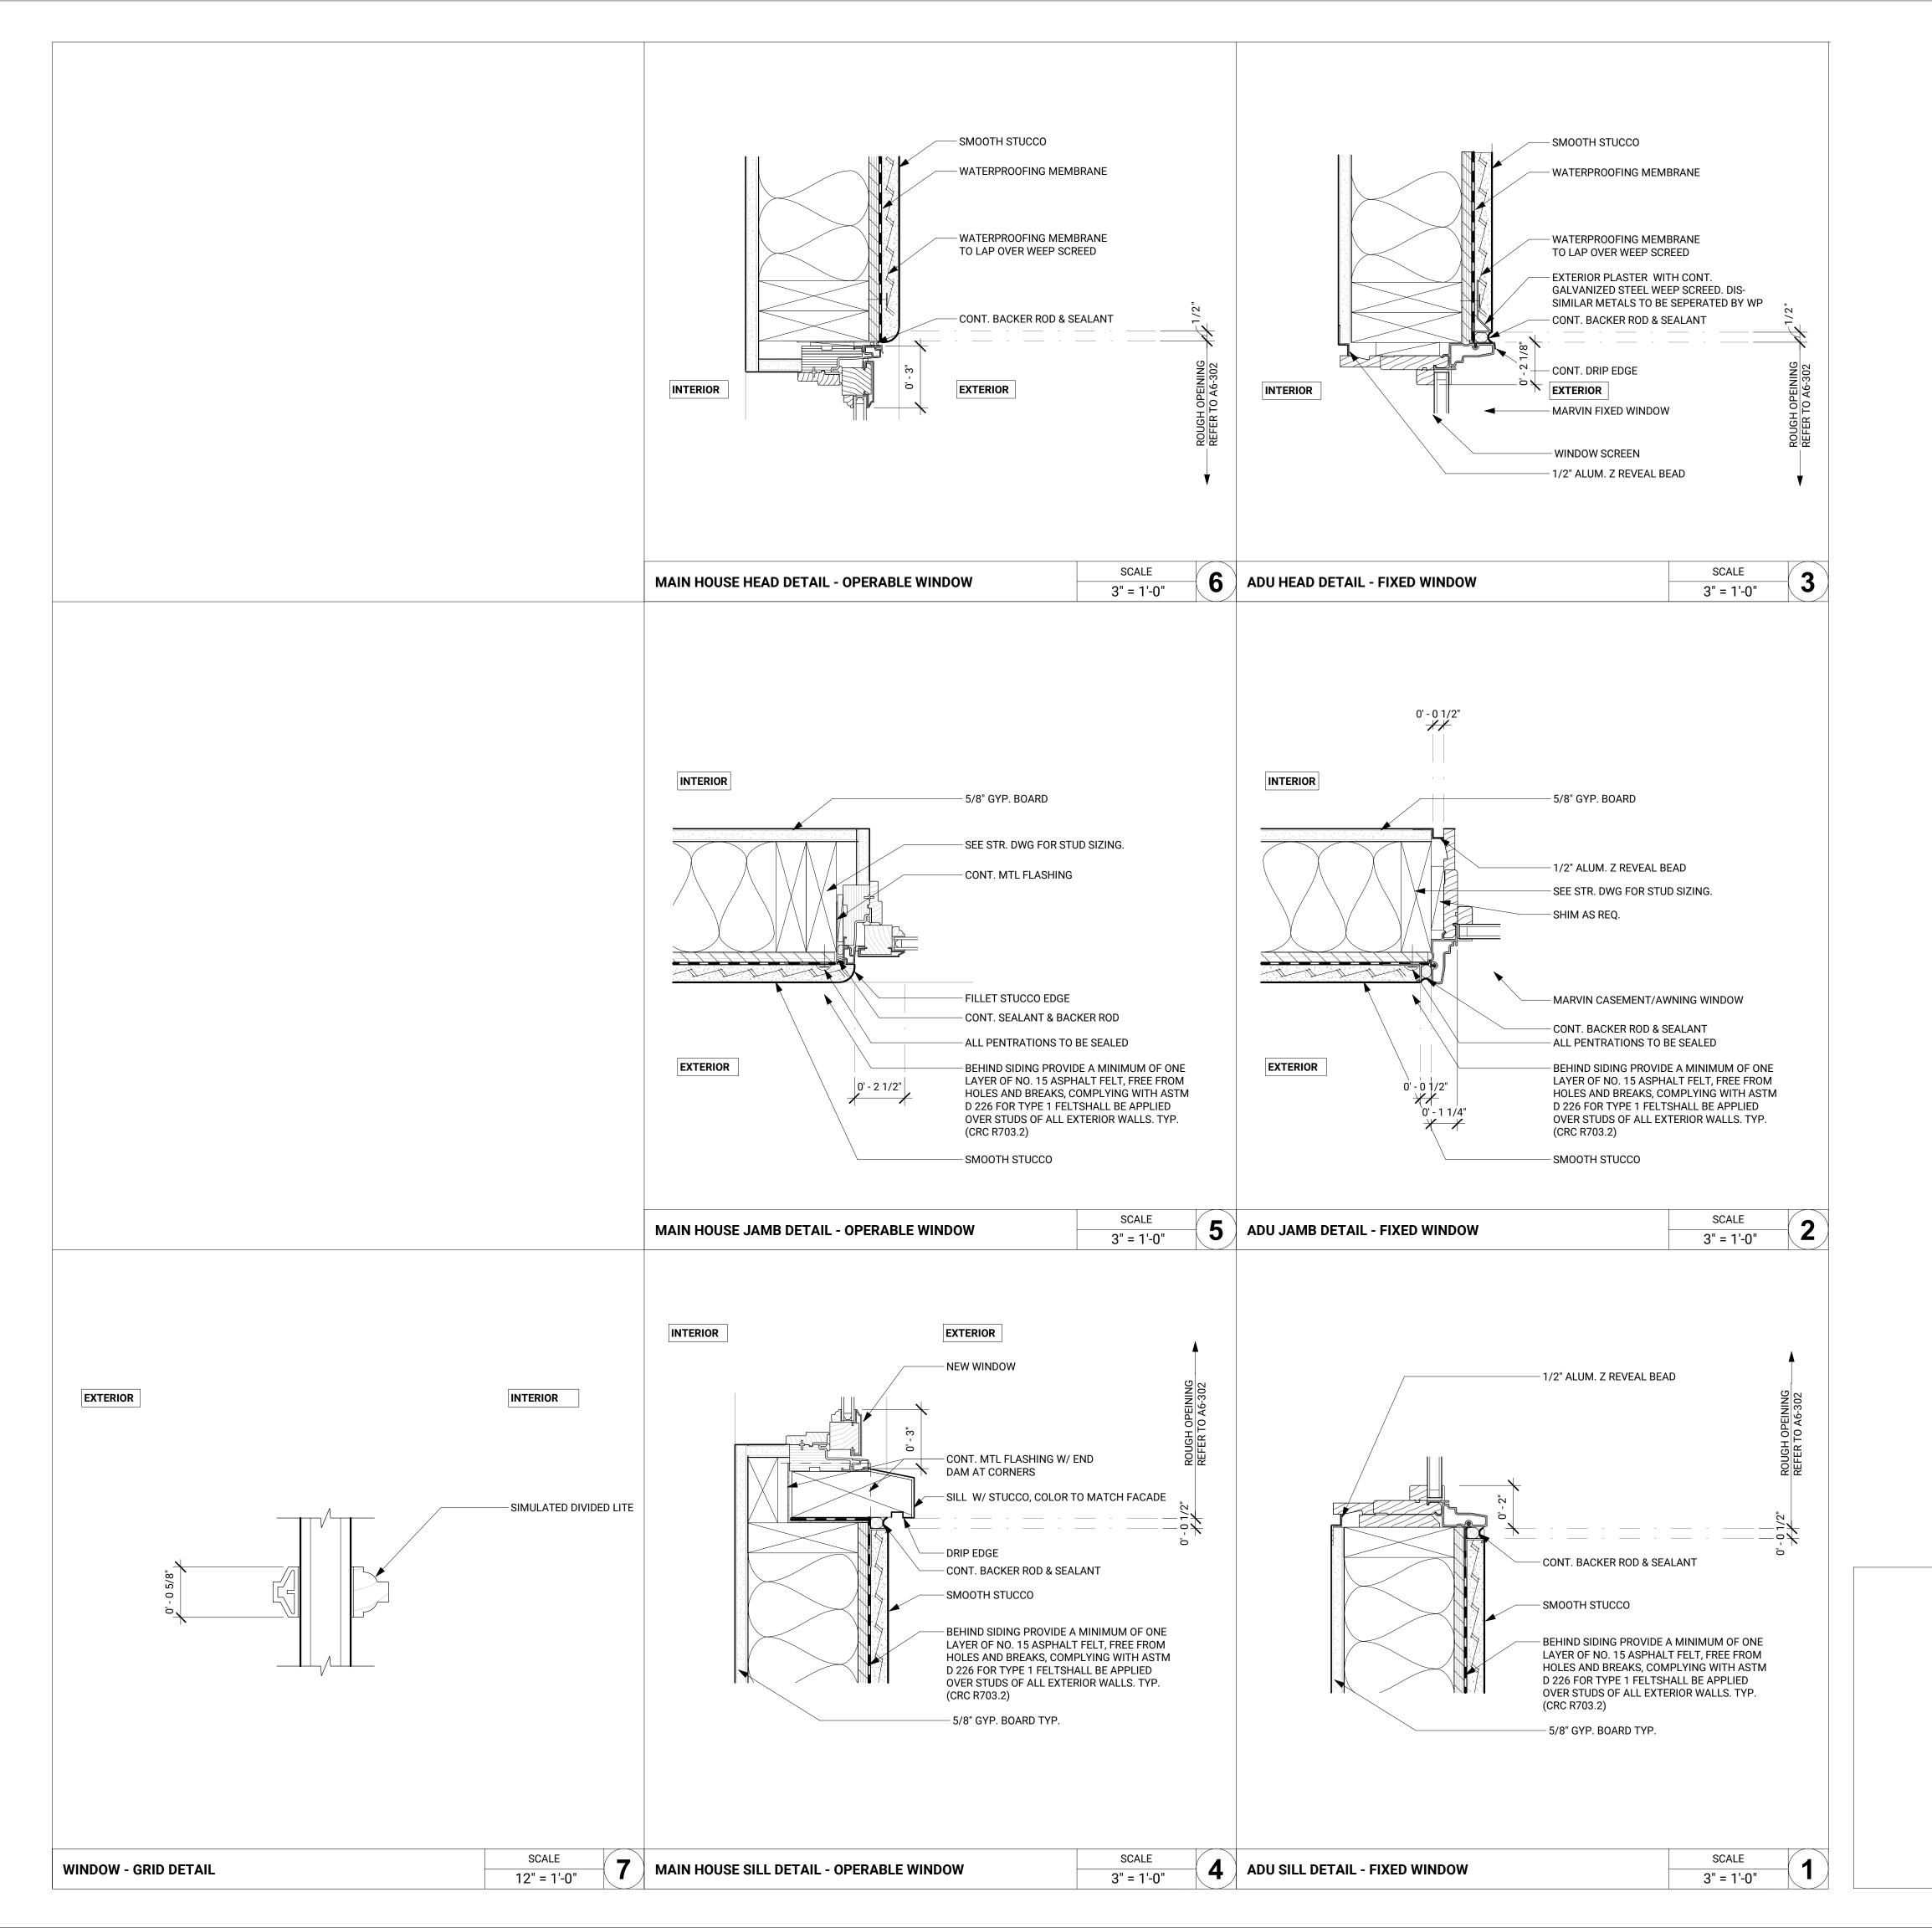



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DATE ISSUE



PROJECT ADDRESS: **926 E DRYDEN STREET**

GLENDALE, CALIFORNIA 91207

ADDITION AND REMODEL

GLAZING DETAIL

PERMIT #:BSFD-018869-2024

4" x 5.5" BOUNDARY RESERVED FOR AHJ APPROVAL STAMP

PLANNING #: PMPA-003557-2024


ORIGINAL SHEET SIZE: 24" x 36"

PROJECT:

2024-008

As indicated

10/23/2024

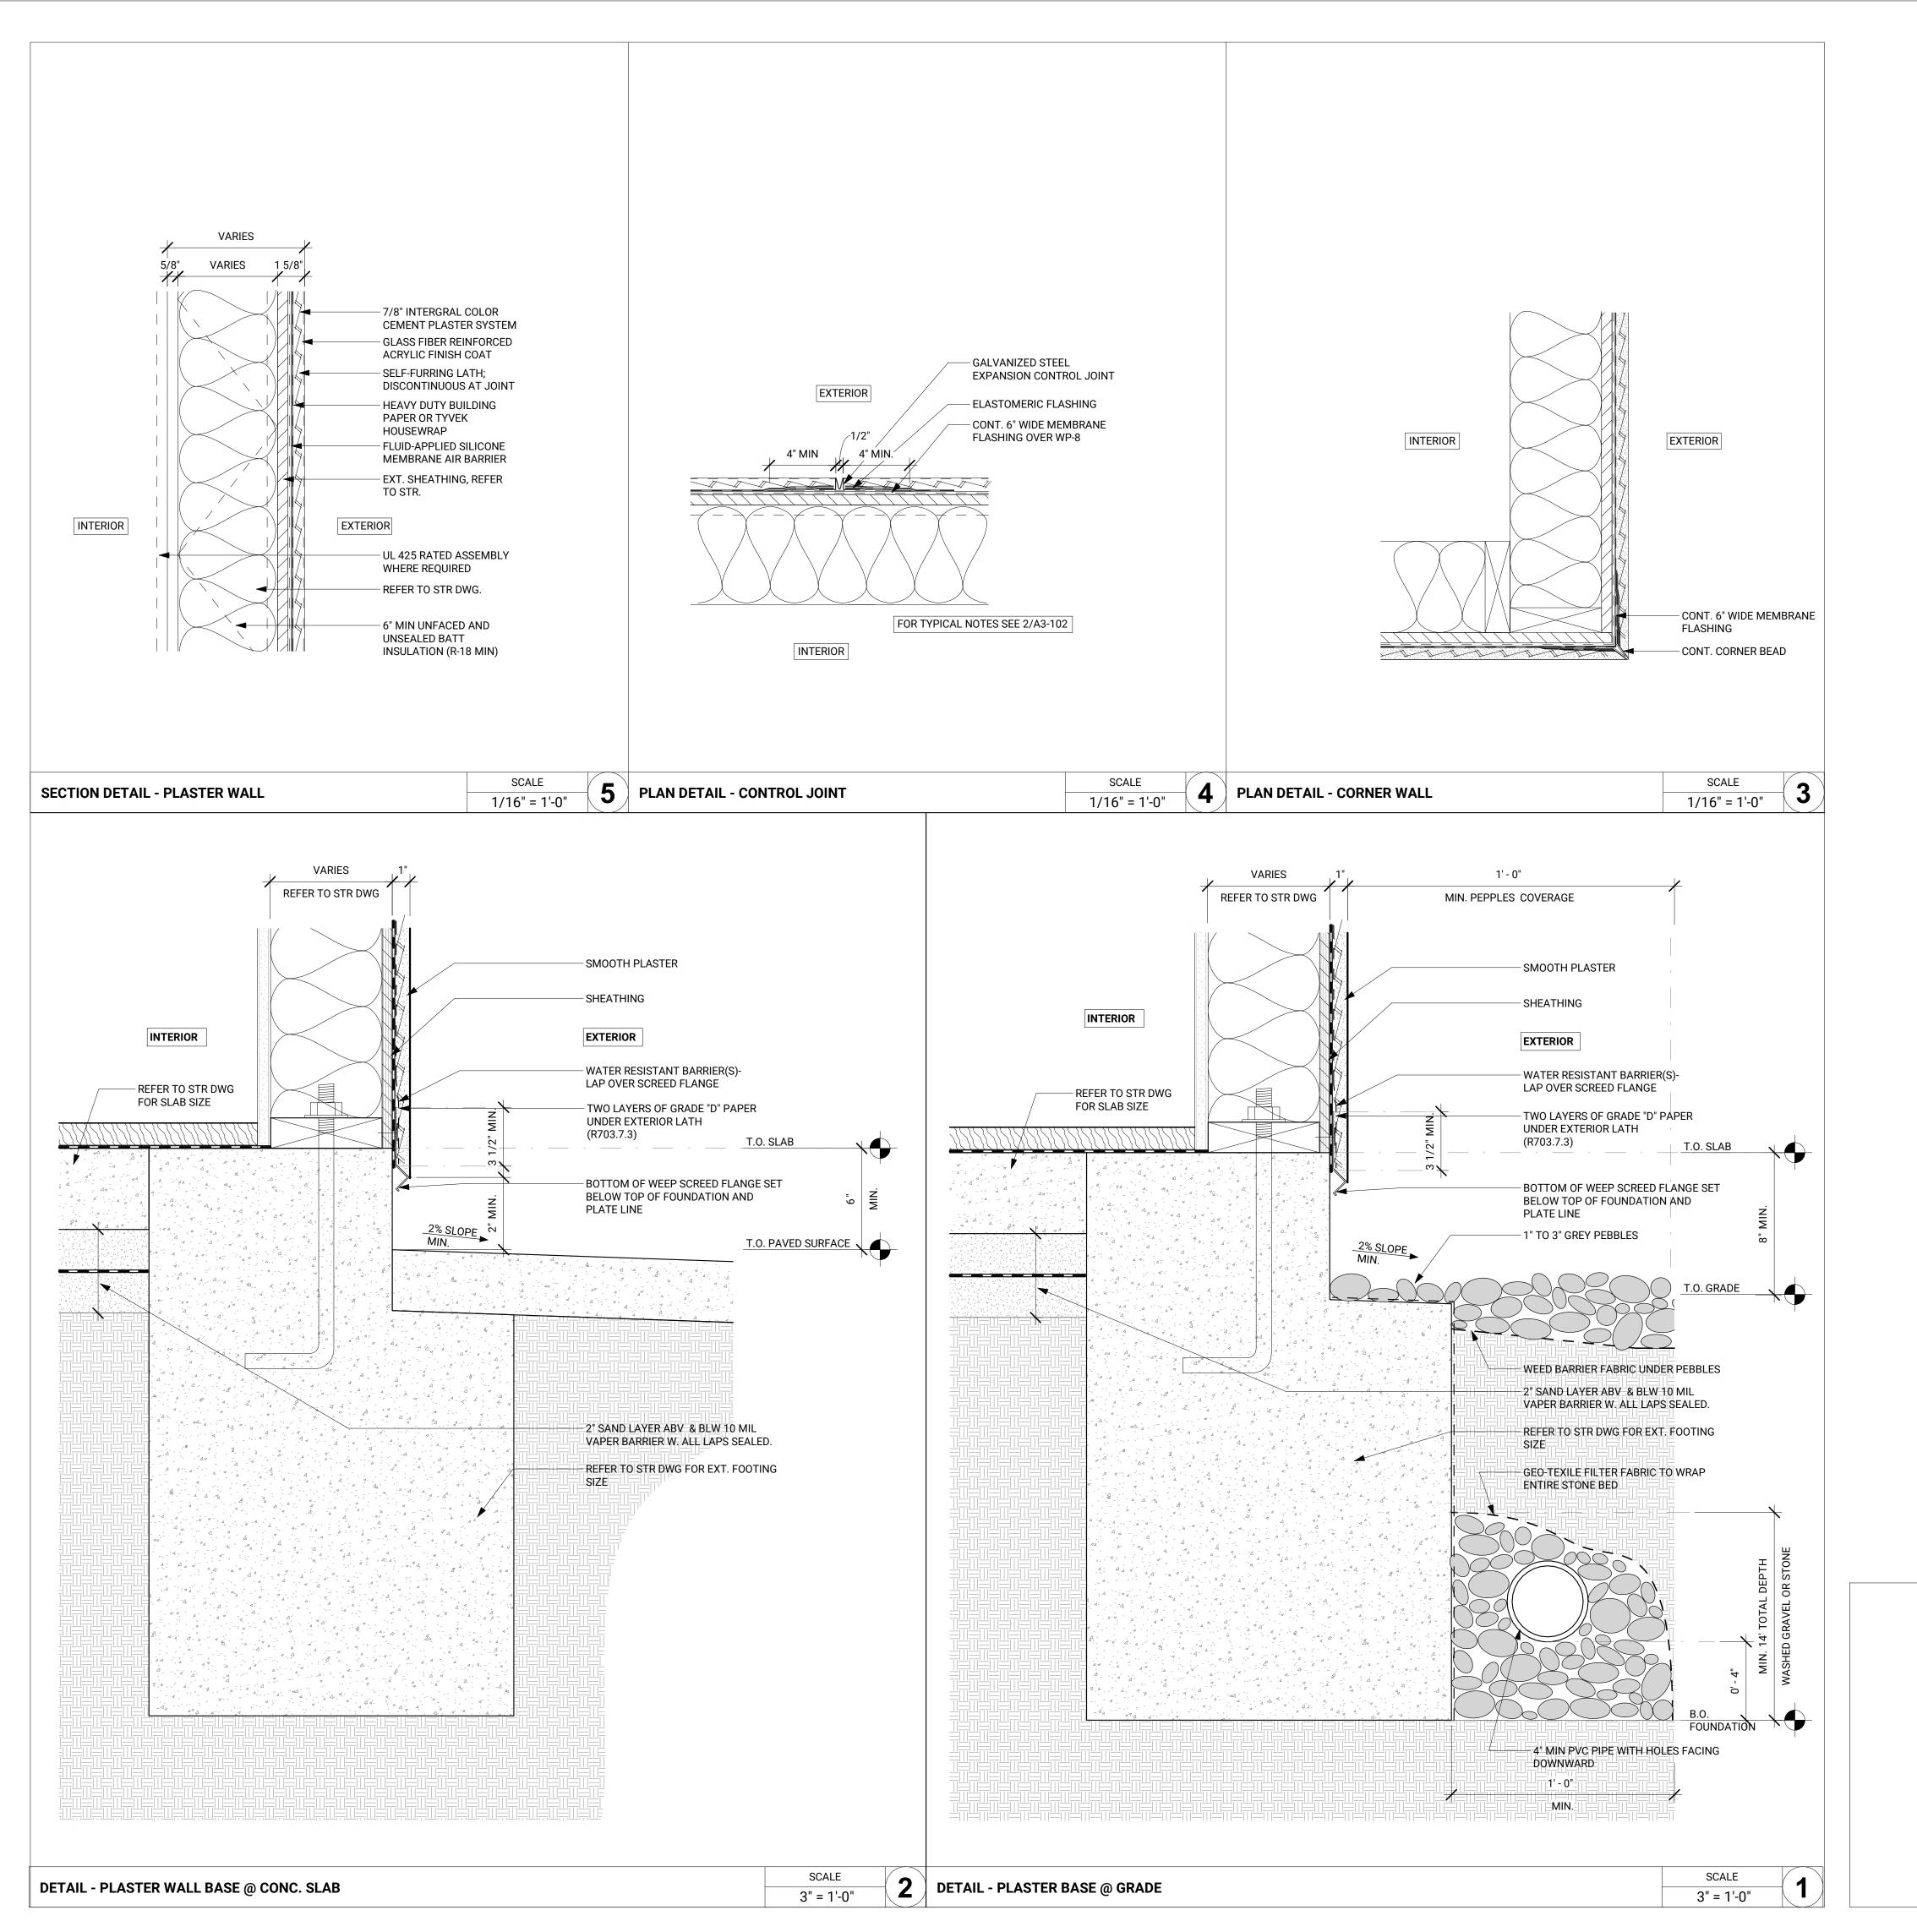



ARCHITECT

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TUJUNGA, CA 91042
M: 818-281-0470
PATRICNOV@PATSMECH.COM

NO. ISSUE DATE



PROJECT ADDRESS:

926 E DRYDEN STREET
GLENDALE, CALIFORNIA 91207

ADDITION AND REMODEL

TITLE

PLASTER DETAILS

PERMIT #:BSFD-018869-2024

4" x 5.5" BOUNDARY RESERVED FOR AHJ APPROVAL STAMP

PLANNING #: PMPA-003557-2024

ORIGINAL SHEET SIZE: 24" x 36"

PROJECT:

2024-008 SCALE:


As indicated

DATE: 10/23/2024

SHEET NUMBER:

1_211



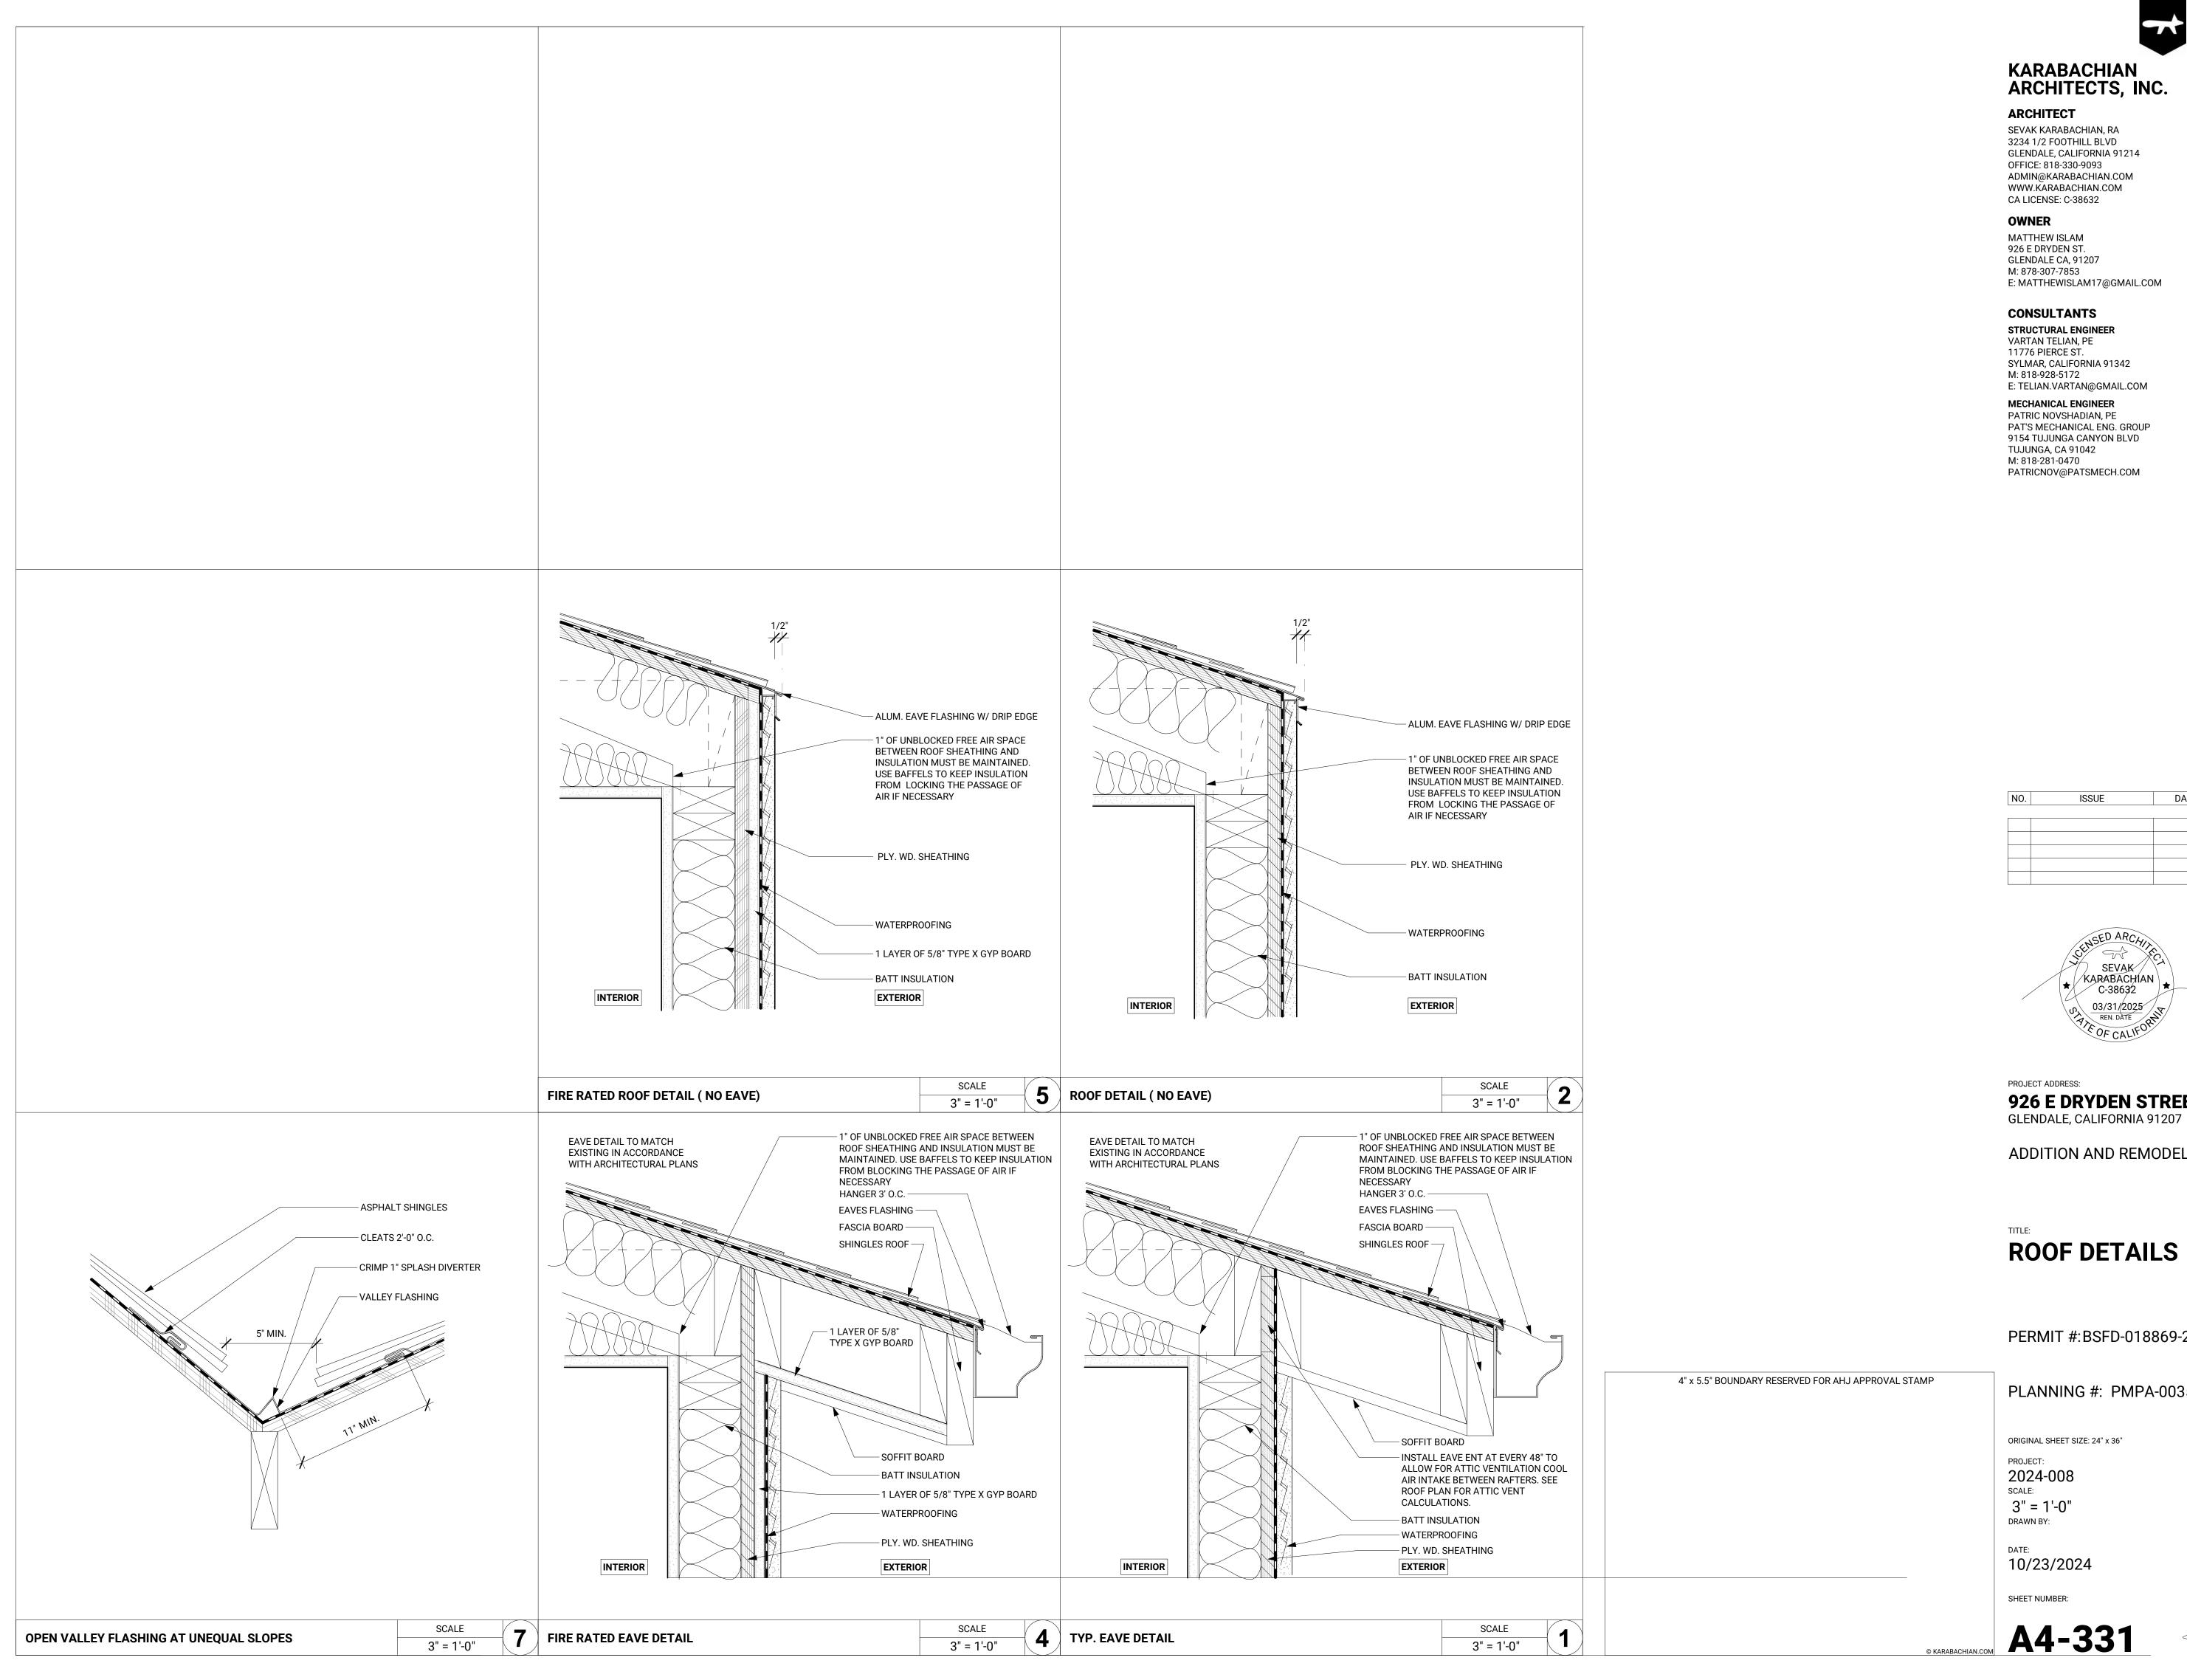



ARCHITECT

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DATE ISSUE



PROJECT ADDRESS: **926 E DRYDEN STREET**

ADDITION AND REMODEL

ROOF DETAILS

PERMIT #:BSFD-018869-2024

PLANNING #: PMPA-003557-2024


ORIGINAL SHEET SIZE: 24" x 36"

2024-008

3" = 1'-0" DRAWN BY:

10/23/2024



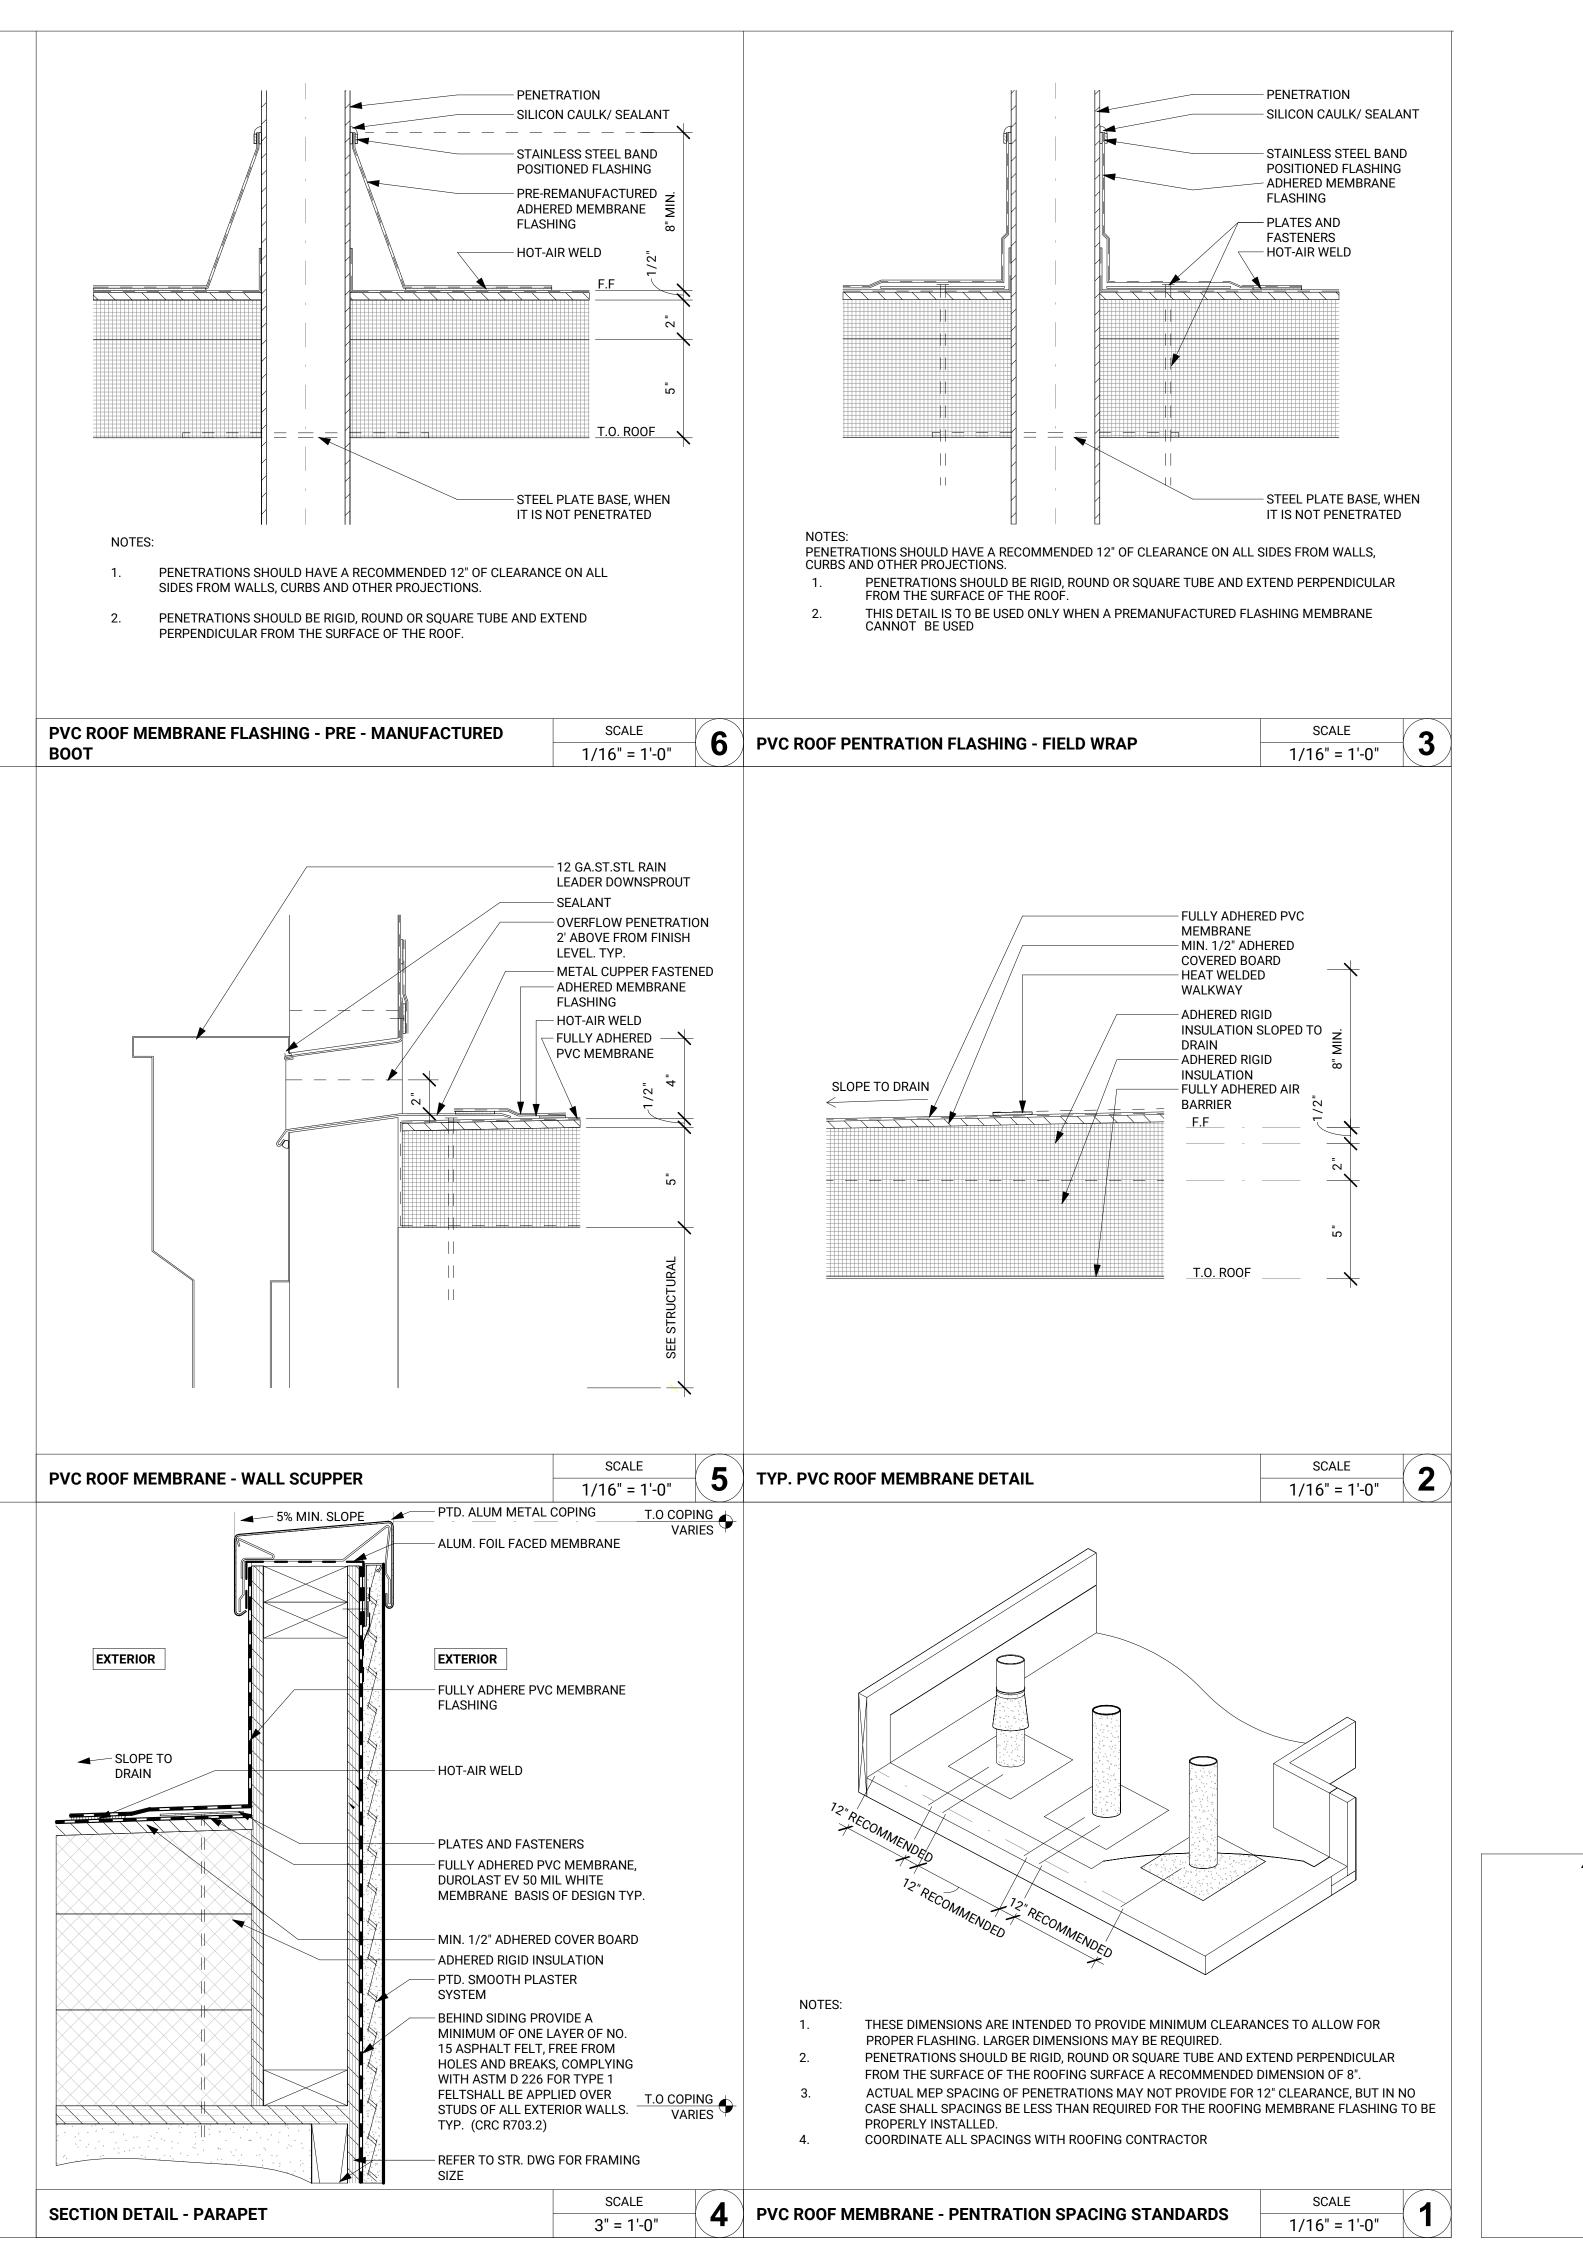



ARCHITECT

SEVAK KARABACHIAN, RA 3234 1/2 FOOTHILL BLVD GLENDALE, CALIFORNIA 91214 OFFICE: 818-330-9093 ADMIN@KARABACHIAN.COM WWW.KARABACHIAN.COM CA LICENSE: C-38632

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9154 TUJUNGA CANYON BLVD TUJUNGA, CA 91042 M: 818-281-0470 PATRICNOV@PATSMECH.COM

NOT FOR CONSTRUCTION

NO.	ISSUE	DATE

PROJECT ADDRESS:

926 E DRYDEN STREET GLENDALE, CALIFORNIA 91207

ADDITION AND REMODEL

TIT

ROOF DETAIS

PERMIT #: BSFD-018869-2024

4" x 5.5" BOUNDARY RESERVED FOR AHJ APPROVAL STAMP

PLANNING #: PMPA-003557-2024

ORIGINAL SHEET SIZE: 24" x 36"

PROJECT:

2024-008 SCALE:

As indicated DRAWN BY:


10/23/2024


SHEET NI IMRER:


A A 222



A4-3

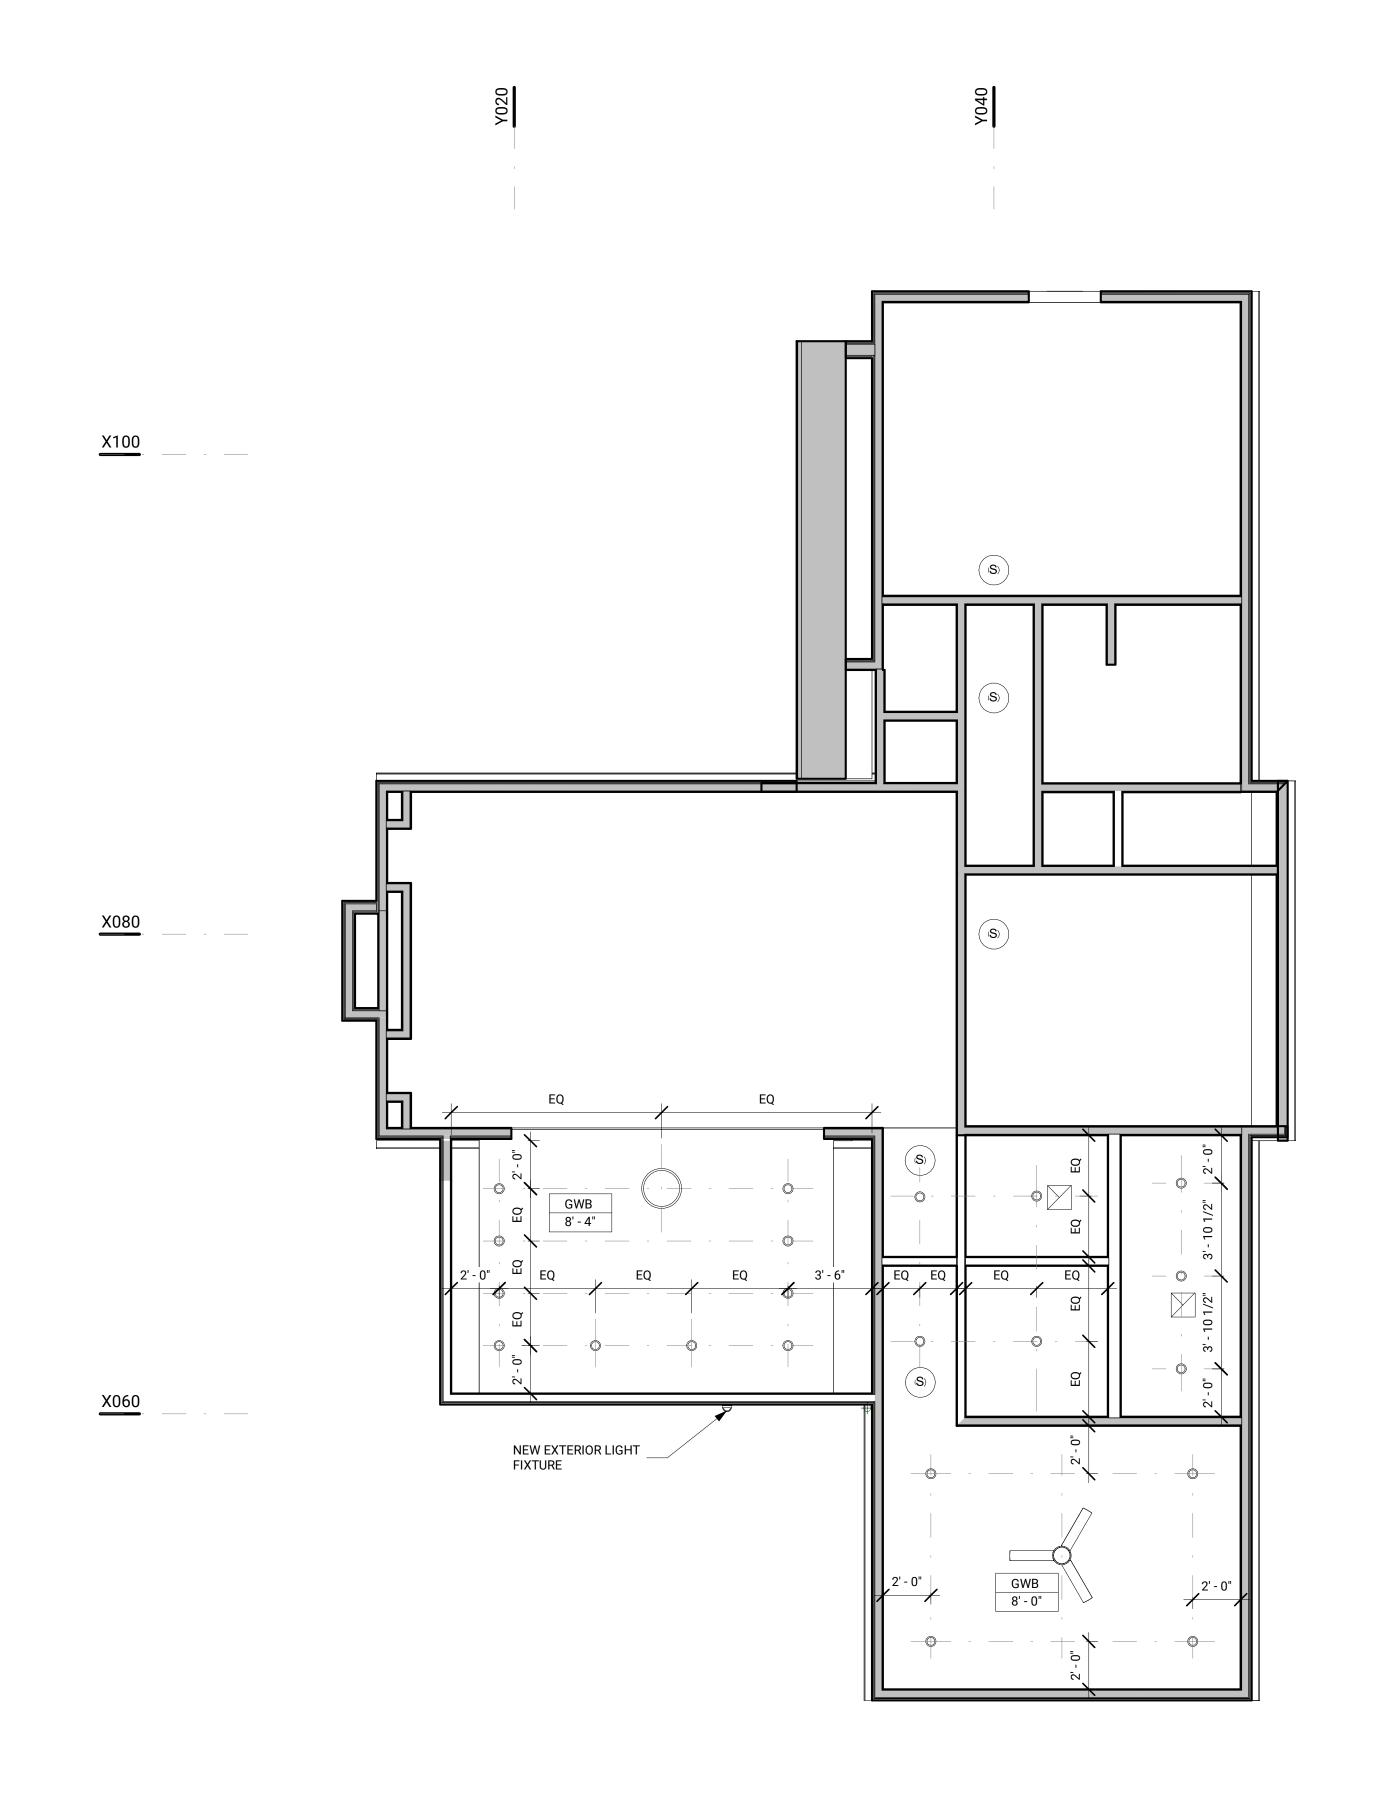

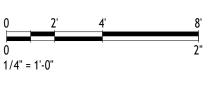

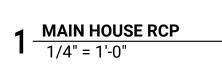



LEGEND RCP	
	RECESSED DOWN LIGHT
	WALL MOUNTED LIGHT FIXTURE
	LINEAR AND/OR BUILT=IN FIXTURE
\odot	RECESSED SPRINKLER HEAD
\bigcirc	PENDANT LIGHT FIXTURE
	RECESS WALL MOUNTED LIGHT FIXTURE
$\overline{\searrow}$	WALL MOUNTED SPRINKLER HEAD
(s)	COMBINATION SMOKE AND CARBON MONOXIDE ALARM
	EXHAUST FAN 50CFM INTERMITTENT AT ALL BATHROOM LOCATIONS FANS SHALL BE ENERGY STAR COMPLIANT AND DUCTED TO TERMINATE OUTSIDE OF THE BUILDING. FANS MUST BE CONTROLLED BY A HUMIDITY CONTROL.
GWB VARIES	CEILING MATERIAL CEILING HEIGHT
	CEILING FAN W/ LIGHT FIXTURE
	CONTINOUS LINEAR SLOT DIFFUSER

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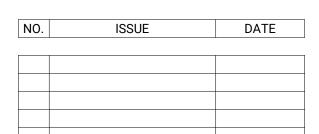
MATTHEW ISLAM 926 E DRYDEN ST. GLENDALE CA, 91207 M: 878-307-7853 E: MATTHEWISLAM17@GMAIL.COM

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M: 818-281-0470 PATRICNOV@PATSMECH.COM






PROJECT ADDRESS: **926 E DRYDEN STREET** GLENDALE, CALIFORNIA 91207

ADDITION AND REMODEL

MAIN HOUSE RCP

PERMIT #:BSFD-018869-2024

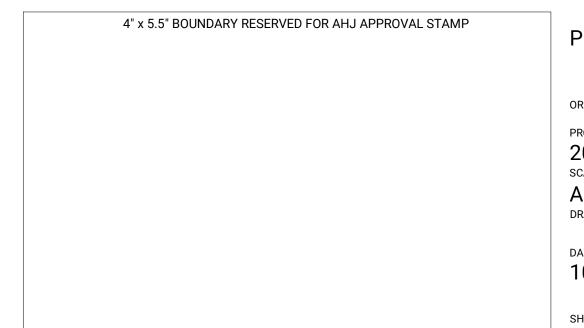

PLANNING #: PMPA-003557-2024

ORIGINAL SHEET SIZE: 24" x 36"


PROJECT: 2024-008


As indicated DRAWN BY:

10/23/2024





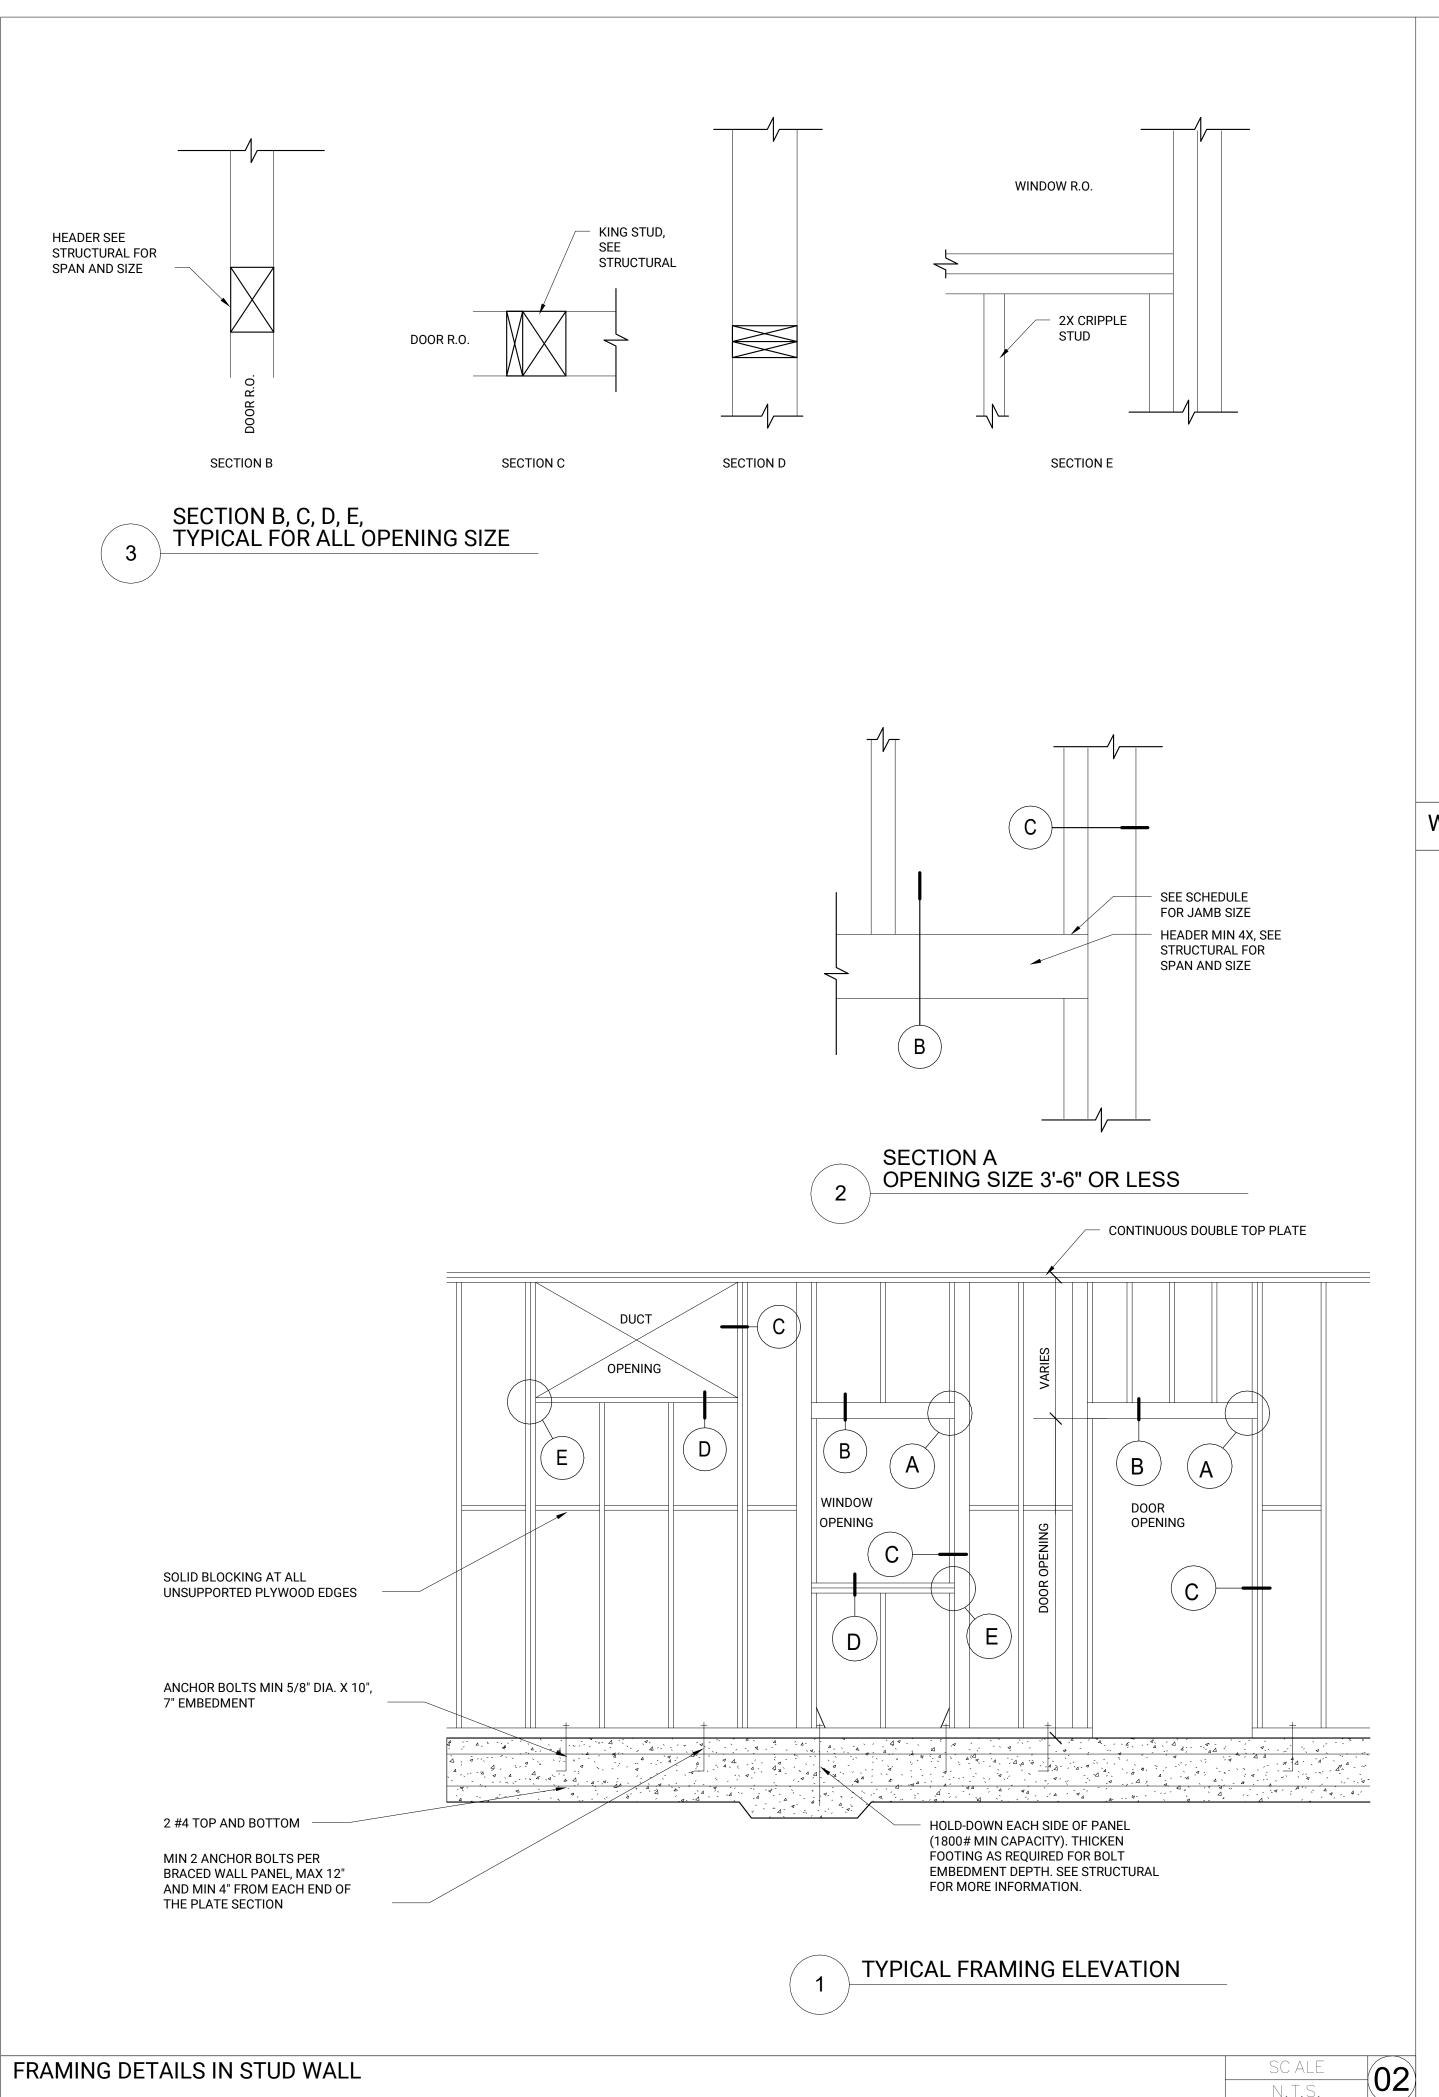

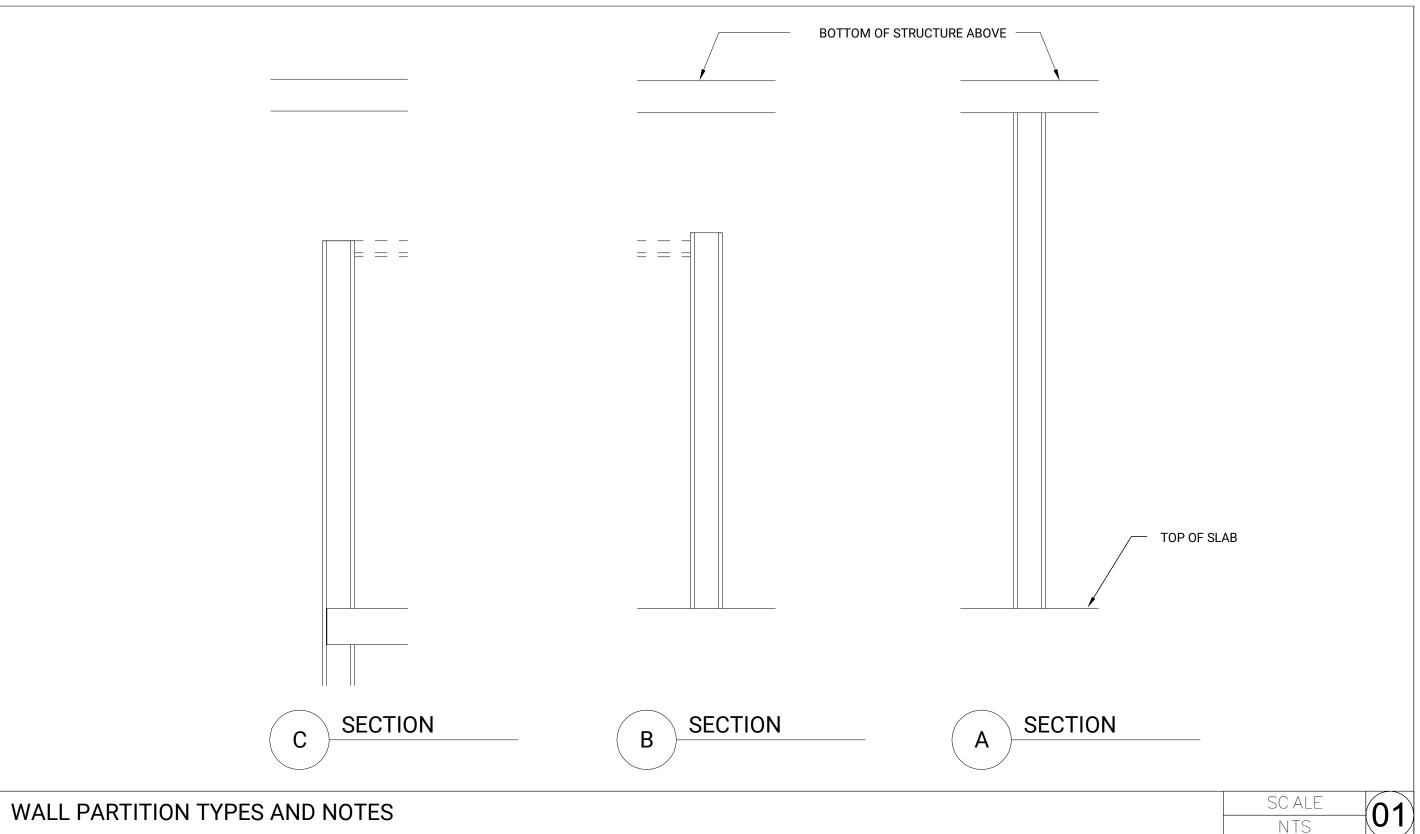

A. PARTITIONS GENERAL NOTES:

- 1. PARTITION TYPES ARE IDENTIFIED ON A 2-101 SERIES FLOOR PLANS.
- 2. PARTITION TAGS INDICATE THE REQUIRED FIRE RATING FOR ASSOCIATED PARTITION CONSTRUCTION AS DESCRIBED.
- 3. FIRE RESISTANT PARTITION ASSEMBLIES SHALL BE CONSTRUCTED OF MATERIALS AND IN THE MANNER DESCRIBED IN THE U400 SERIES PARTITION DESIGN IN THE UL FIRE RESISTANCE DIRECTORY AND THE GYPSUM ASSOCIATION FIRE RESISTANCE DESIGN MANUAL GA-600.
- 4. PARTITION TAG INDICATES THE COMPLETE WALL ASSEMBLY WITH EXCEPTION OF FINISHES. REFER TO ROOM FINISH SCHEDULE FOR FINISH REQUIREMENTS. WHERE ASSEMBLY HAS MULTIPLE TAGS REFER TO PLANS FOR THICKNESS OF THE PARTITION.
- 5. DIMENSIONS SHOWN ON PLANS ARE MEASURED TO FACE OF FINISHES.
- 6. ALL WOOD STUD PARTITIONS SHALL BE COORDINATED WITH ADJACENT TRADES FOR THE LATERAL BRACING AND BRIDGING

B. PARTITION TYPE NAMING CONVENTION

THE PARTITION TAG CONSISTS OF 4 DIGITS. REFER TO THE EXPLANATION OF EACH DIGIT BELOW:



REFERS TO THE

0- NON RATED

1- I HOUR

2-2 HOUR

3-3 HOUR 4 -4 HOUR

REQUIRED FIRE RATING


OF THE PARTITION.



SHEET A6-302

DETAILS.



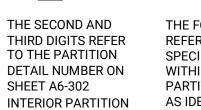

THE FOURTH DIGIT REFERS TO THE SPECIFIC TYPE WITHIN THE PARTITION DETAIL, AS IDENTIFIED IN THE TYPE CHART BELOW.

234AA

THE FIFTH DIGIT

REFERS TO THE

TYPE SHOWN IN

SECTION CHART

ABOVE.

SPECIFIC SECTION

* THE TYPE CHART ON EACH PARTITION DETAIL DESCRIBES SPECIFIC VARIATIONS. A VARIATION IN A PARTITION TYPE MAY BE DEFINED BY THE INFORMATION IN ANY ONE COLUMN, OR MULTIPLE COLUMNS. COLUMNS INCLUDED ON THE CHARTS VARY ACCORDING TO THE MATERIALS USED IN THE PARTITION ASSEMBLIES. THE FOLLOWING IS AN EXAMPLE OF A CHART FOUND ON THE PARTITION TYPE DETAIL SHEET.

TYPE	STUD SIZE	PARTITION	UL DESIGN	INSULATION	REMARKS
		THICKNESS			
Α	3-1/2"	4-3/4"	1 HOUR: U419 OR U465	ACOUST/3"	
В	3-1/2"	4-3/4"	1 HOUR: U419 OR U465	NONE	

ASSEMBLY TYPE:

REFERS TO PARTITION TYPE NOTED IN PLAN AND FINISH SCHEDULE FOR COMPLETE ASSEMBLY

STUD SIZE:

MINIMUM ACCEPTABLE WOOD STUD SIZE.

PARTITION THICKNESS:

OVERALL DIMENSION OF PARTITION FROM FACE OF DRYWALL

UL DESIGN NO.

REFERS TO UL FIRE RESISTANCE DESIGNS FOR THE FIRE RATING INDICATED BY THE FIRST DIGIT OF THE PARTITION DETAIL TAG

MULTIPLE UL DESIGN NUMBERS INDICATE

INSULATION:

OTHER ASSEMBLIES THAT VARY DEPENDING ON THE MATERILAS SELECTED. IT IS THE CONTRACTORS RESPENSIBILITY TO SELECT THE CORRECT UL DESIGN FROM AVAILABLE ASSEMBLIES THAT MEET PARTITION CRITERIA.

MINIMUM THICKNESS OF INSULATION REQUIRED. REFER TO ENERGY CALCULATIONS FOR INSULATION TYPES.

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OWNER


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PROJECT ADDRESS: **926 E DRYDEN STREET** GLENDALE, CALIFORNIA 91207

ADDITION AND REMODEL

4" x 5.5" BOUNDARY RESERVED FOR AHJ APPROVAL STAMP

PARTITION NOTES

PERMIT #: BSFD-018869-2024

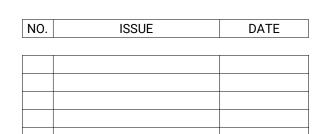PLANNING #: PMPA-003557-2024


ORIGINAL SHEET SIZE: 24" x 36"

PROJECT: 2024-008 SCALE:

DRAWN BY:

10/23/2024



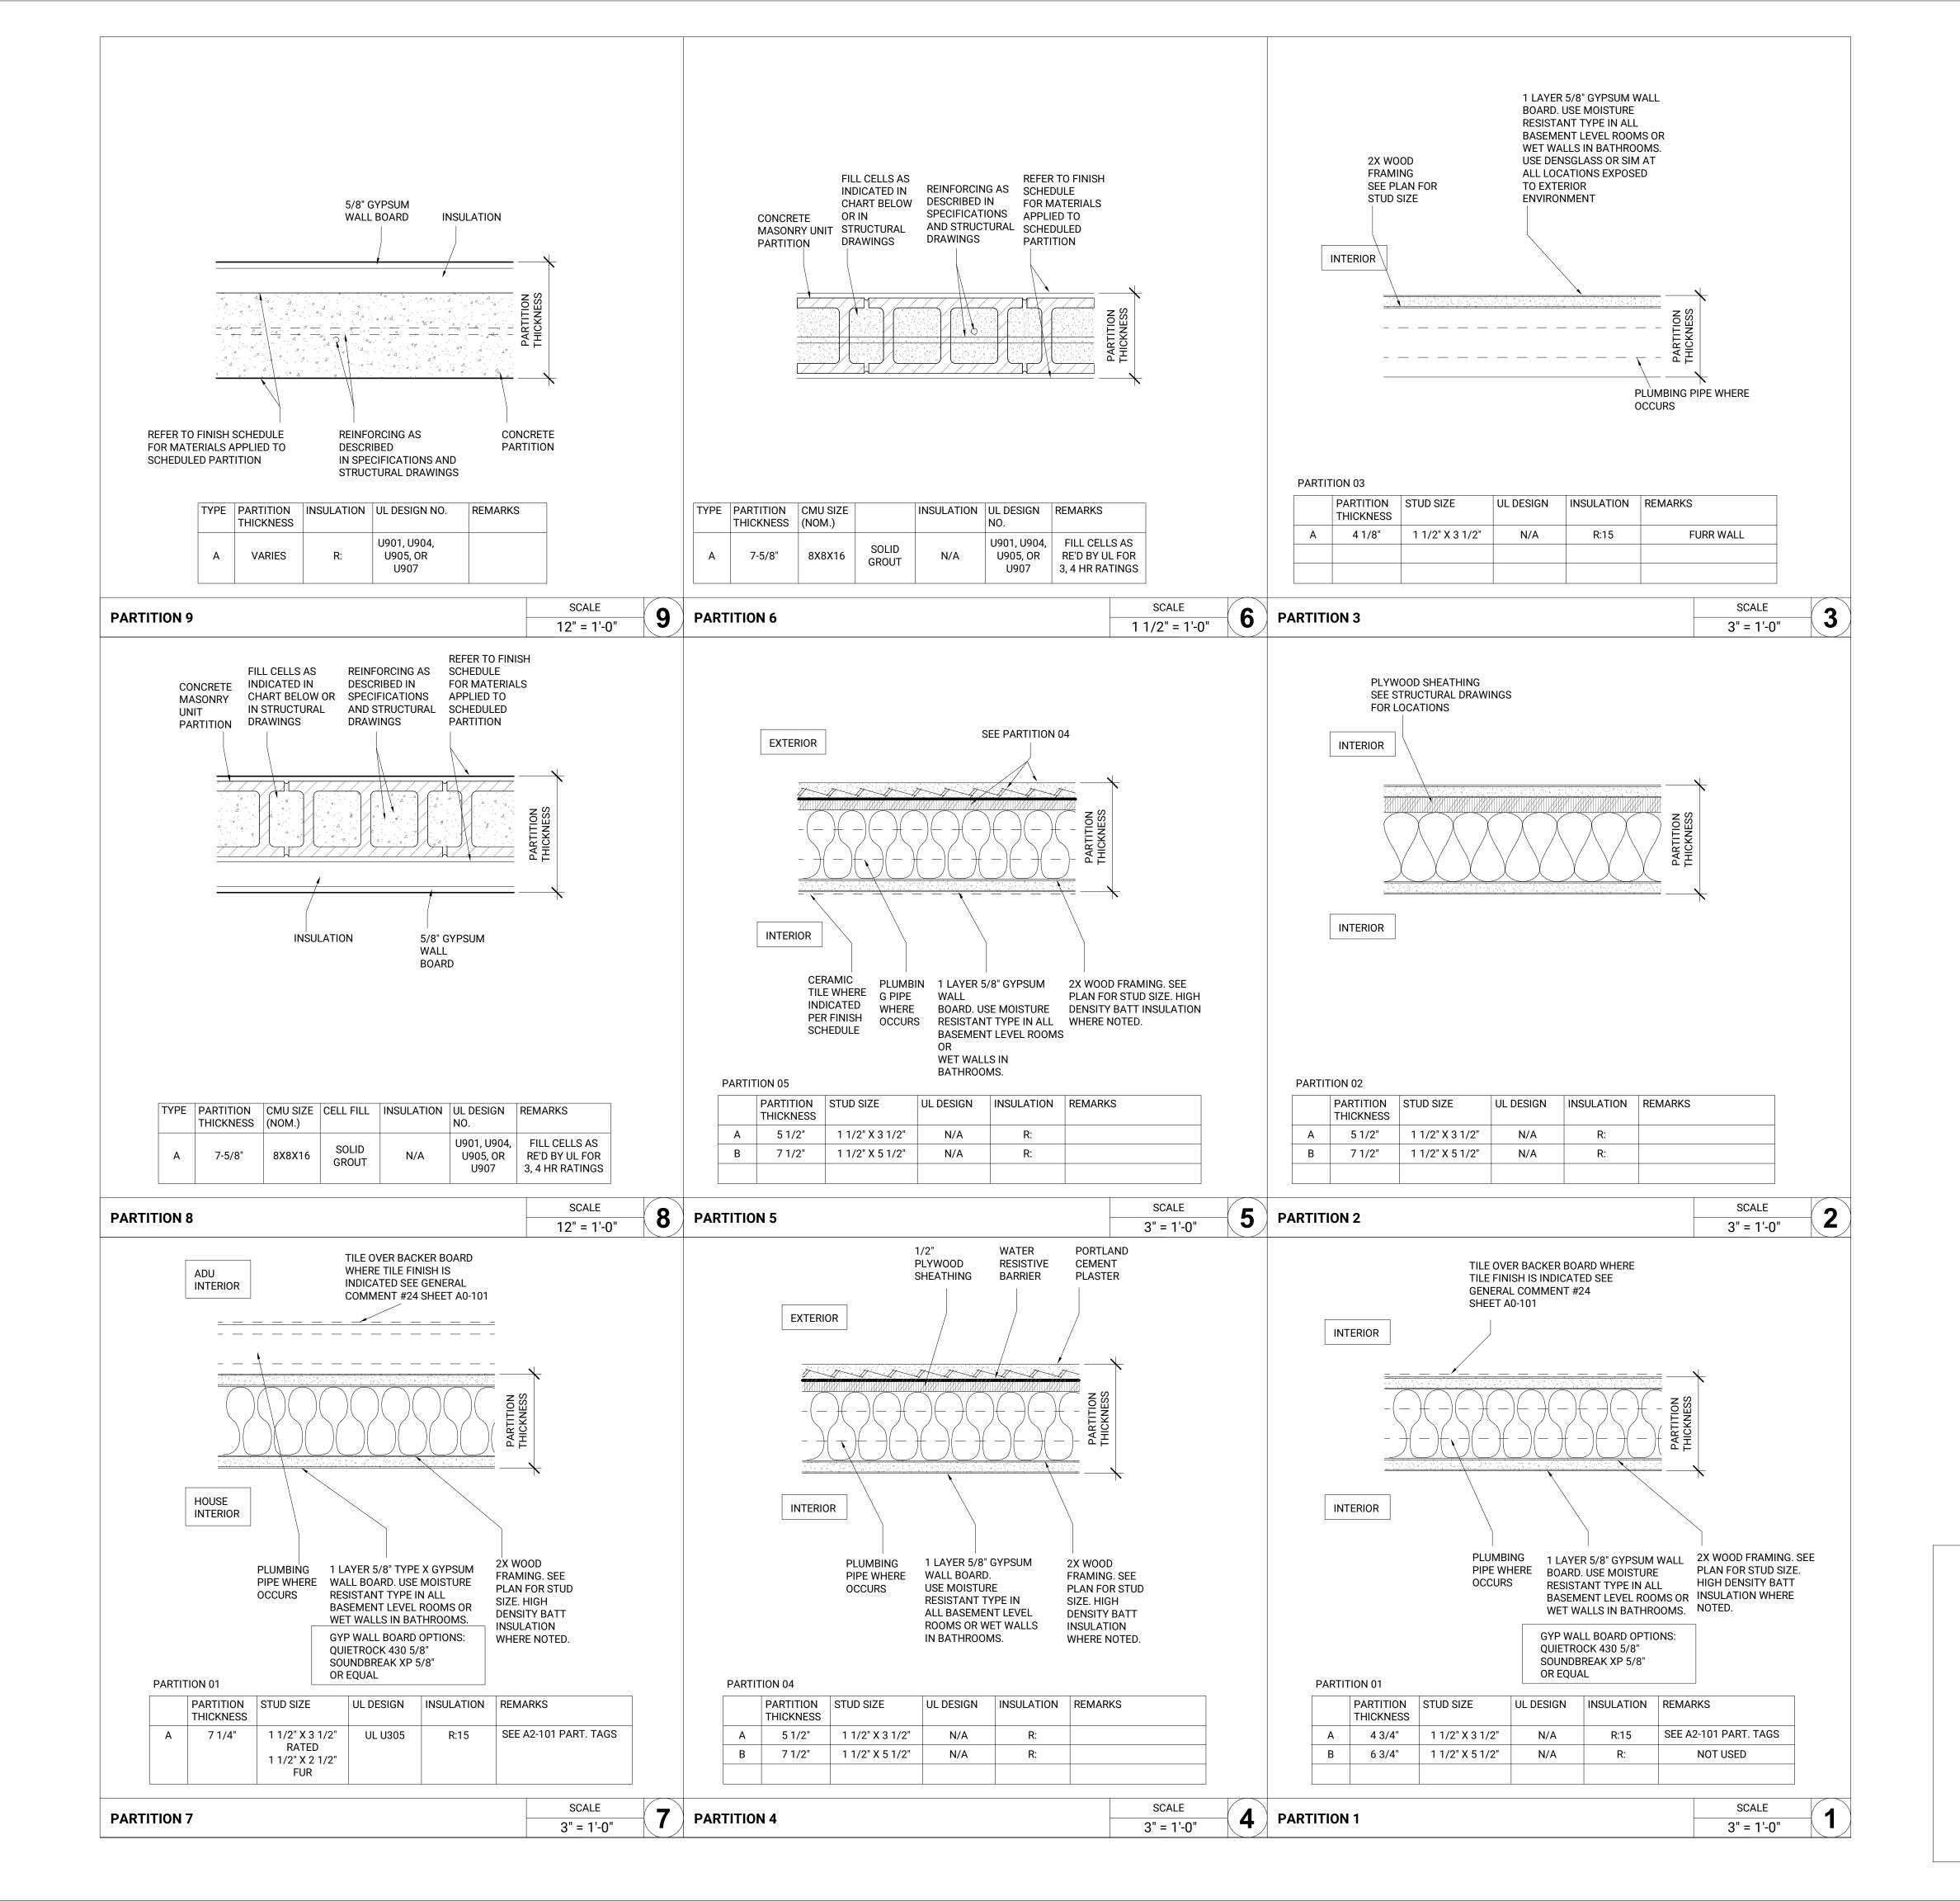



ARCHITECT

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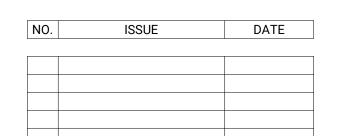
OWNER

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PROJECT ADDRESS: **926 E DRYDEN STREET** GLENDALE, CALIFORNIA 91207

ADDITION AND REMODEL

PARTITION TYPE/DETAILS

PERMIT #: BSFD-018869-2024

4" x 5.5" BOUNDARY RESERVED FOR AHJ APPROVAL STAMP

PLANNING #: PMPA-003557-2024

ORIGINAL SHEET SIZE: 24" x 36"


PROJECT:

2024-008 SCALE:

As indicated

10/23/2024



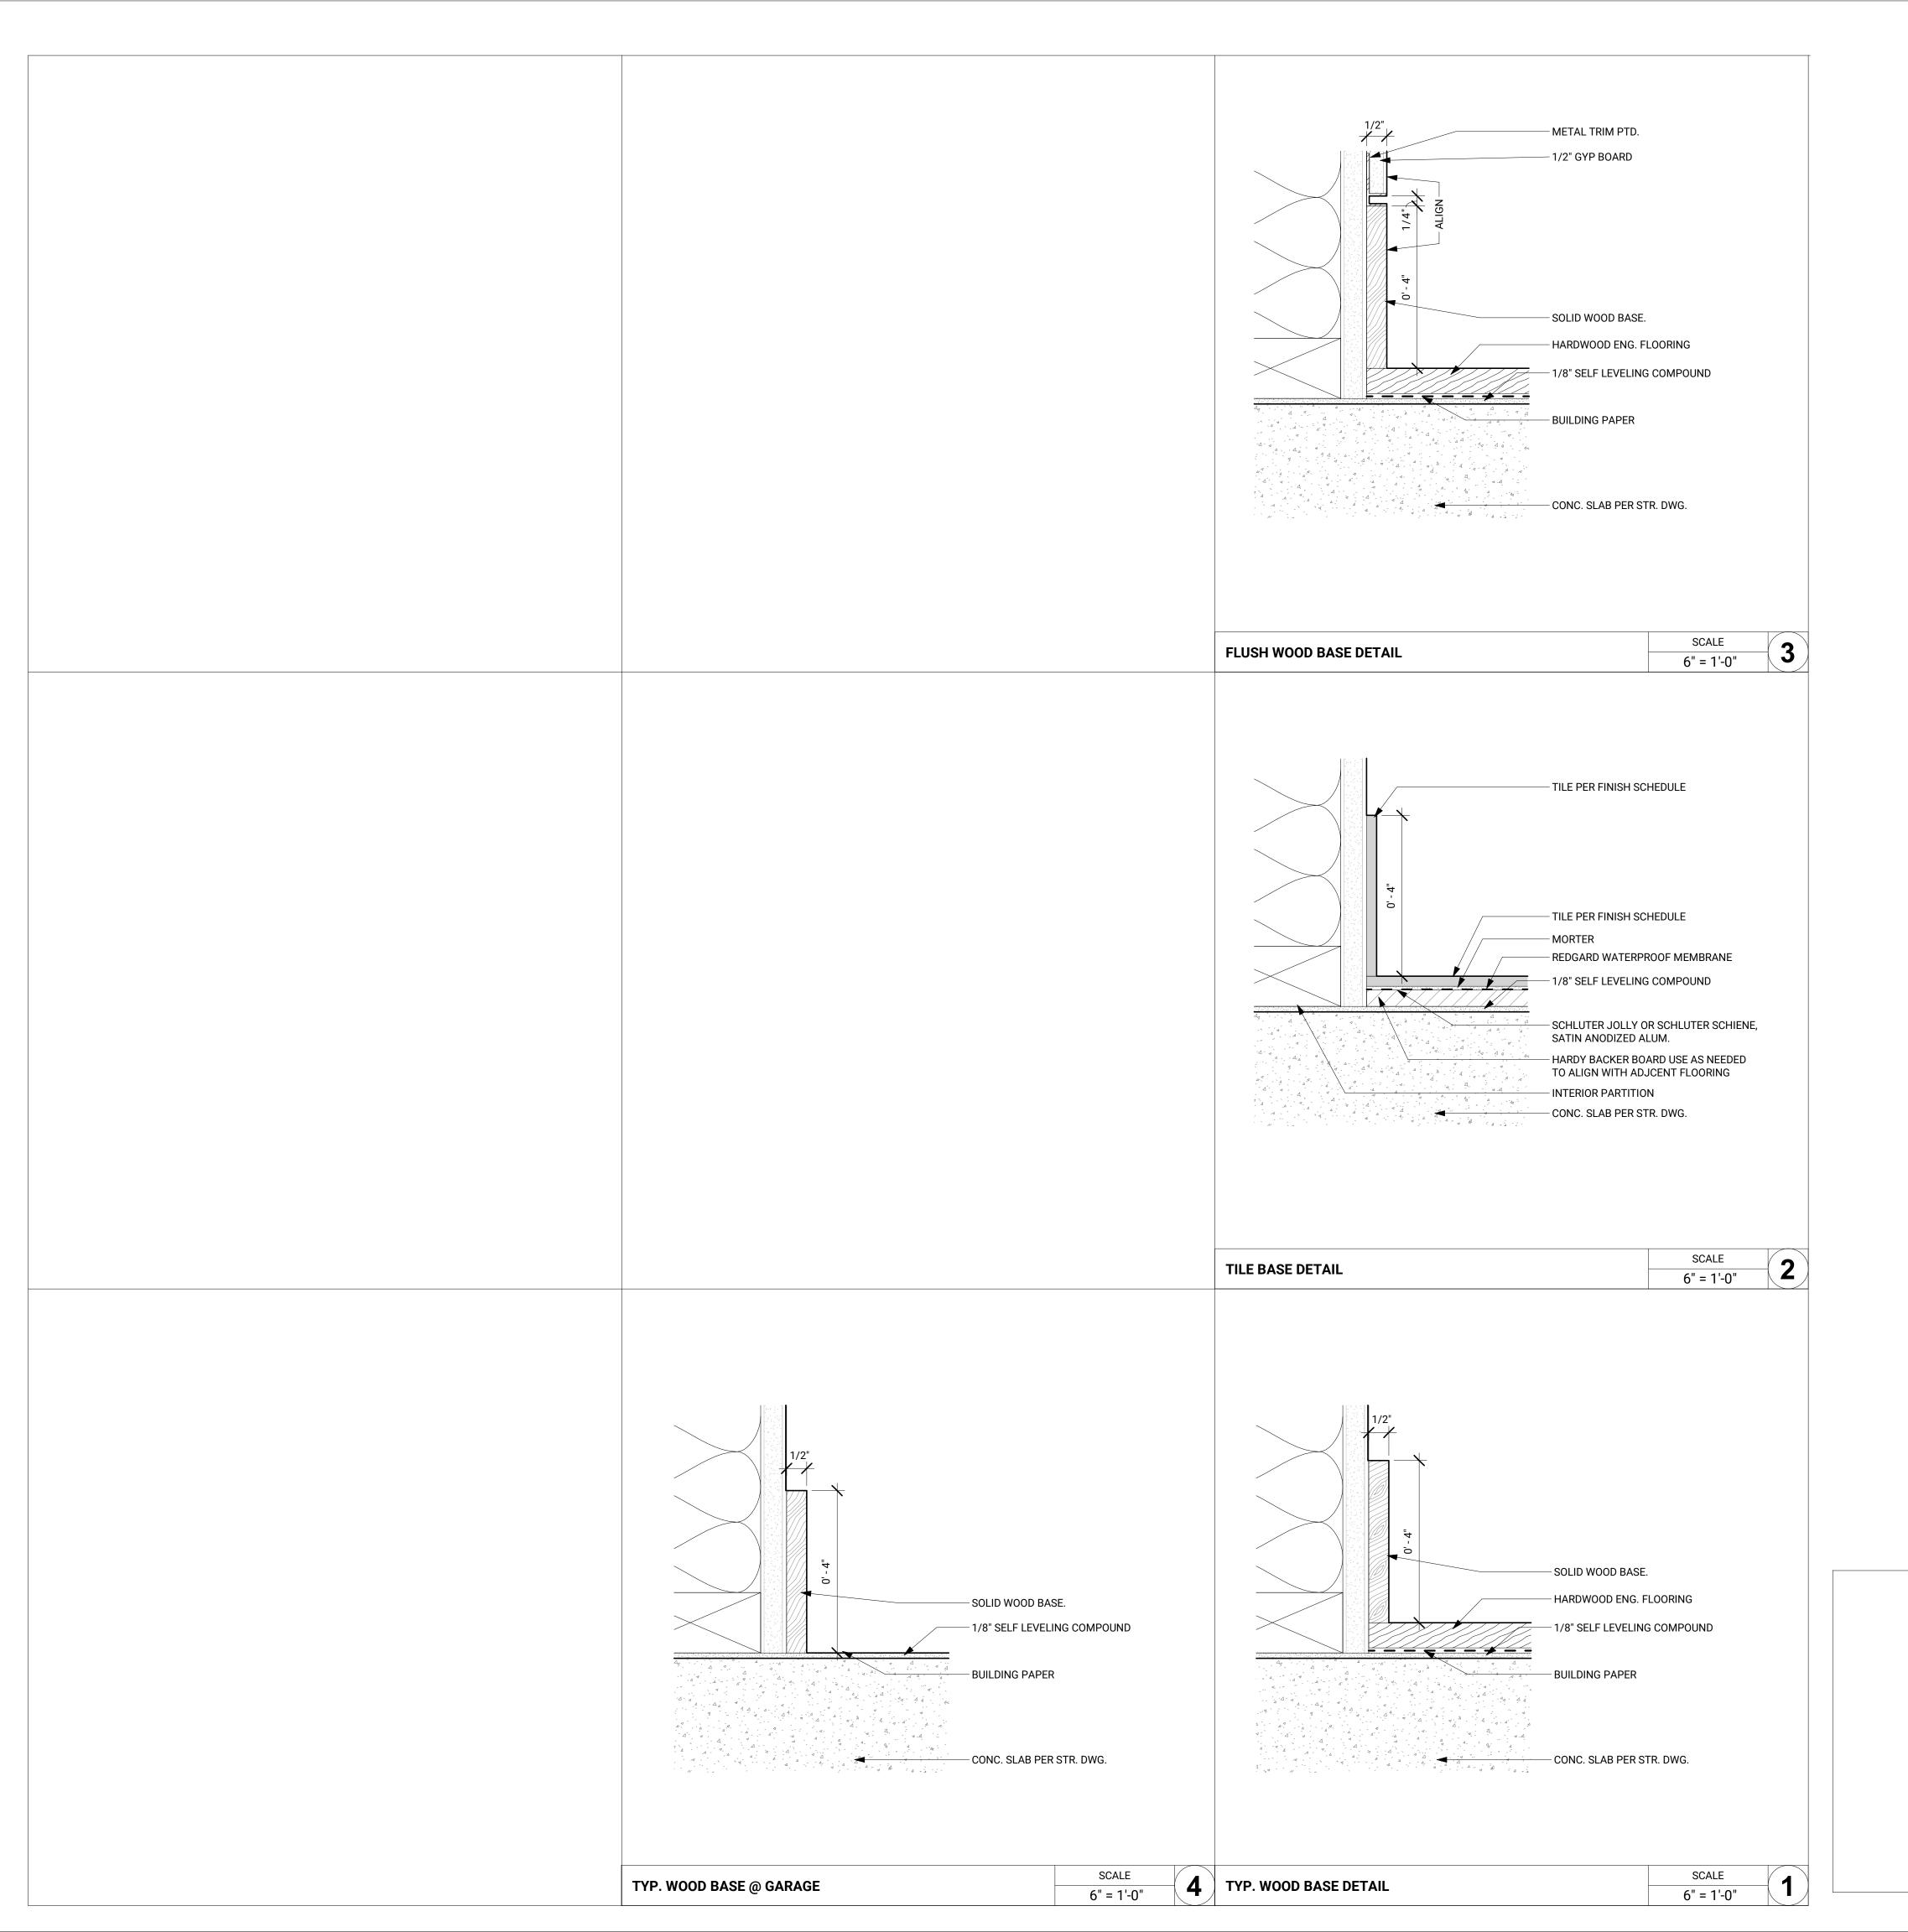



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9154 TUJUNGA CANYON BLVD TUJUNGA, CA 91042 M: 818-281-0470 PATRICNOV@PATSMECH.COM

NO. ISSUE DATE



PROJECT ADDRESS:

926 E DRYDEN STREET
GLENDALE, CALIFORNIA 91207

ADDITION AND REMODEL

TITLE:

PARTITION BASE DETAILS

PERMIT #:BSFD-018869-2024

4" x 5.5" BOUNDARY RESERVED FOR AHJ APPROVAL STAMP

PLANNING #: PMPA-003557-2024

ORIGINAL SHEET SIZE: 24" x 36"

PROJECT: 2024-008

SCALE:
6" = 1'-0"
DRAWN BY:

DATE: 10/23/2024

SHEET NUMBER:

A6_202

303



E: MATTHEWISLAM17@GMAIL.COM

ARCHITECT

OWNER

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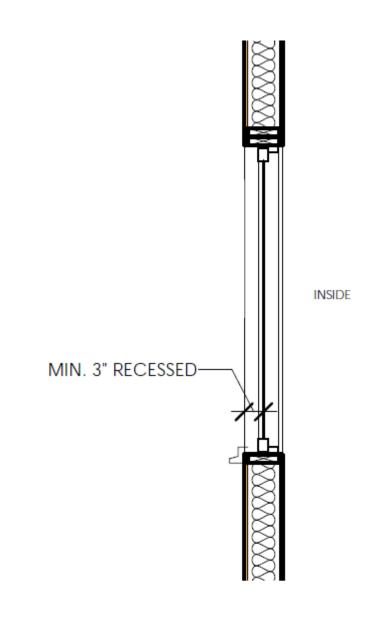
PAT'S MECHANICAL ENG. GROUP

9154 TUJUNGA CANYON BLVD

PATRICNOV@PATSMECH.COM


SEVAK KARABACHIAN, RA 3234 1/2 FOOTHILL BLVD GLENDALE, CALIFORNIA 91214

OFFICE: 818-330-9093 ADMIN@KARABACHIAN.COM WWW.KARABACHIAN.COM CA LICENSE: C-38632



1) WINDOW SECTION 1/2" = 1'-0"

										WINDOW SCI	HEDULE										
		(N) DIM	ENSIONS	(E) DIMI	ENSIONS																WINDOW WITHIN 18" OF
WINDOW NUMBER	QUANTITY	WIDTH	HEIGHT	WIDTH	HEIGHT	(E) MATERIAL	(N) MATERIAL	VISIBLE FROM STREET	(E) OPERATION	NEW OPERATION	NEW FRAME TYPE		KEEP EXISTING SILL & FRAME	_	EXISTING EDGE DETAIL	NEW EDGE DETAIL	BEDROOM	ENERGY EFFICIENT	TEMPERED GLASS	FIRED HAZARD ZONE	
C4	1	6' - 0"	3' - 4"	6' - 0"	3' - 0"	MTL.	ALUM./WD	YES	SLIDING	CSMT-FIXED-CSMT	BLOCK	YES	YES	NO	NO TRIM	NO TRIM	YES	YES	NO	NO	NO
C5	1	6' - 0"	3' - 0"	N/A	N/A	N/A	ALUM./WD	YES	N/A	CSMT-FIXED-CSMT	RECESSED NAIL-IN	YES	N/A	YES	N/A	NO TRIM	NO	YES	NO	NO	NO
C6	1	5' - 0"	3' - 0"	5' - 0"	3' - 0"	MTL.	ALUM./WD	NO	SLIDING	CASEMENT	BLOCK	YES	YES	NO	NO TRIM	NO TRIM	YES	YES	NO	NO	NO
C8	1	2' - 6"	3' - 4"	N/A	N/A	N/A	ALUM./WD	NO	SWING DOOR	CASEMENT	RECESSED NAIL-IN	YES	NO	YES	NO TRIM	NO TRIM	YES	YES	NO	NO	NO
C9	1	3' - 0"	3' - 0"	3 '- 0"'	3' - 0"	MTL.	ALUM./WD	NO	LOUVER	CASEMENT	BLOCK	YES	YES	NO	NO TRIM	NO TRIM	NO	YES	NO	NO	NO
C10	1	3' - 0"	5' - 1"	3 '- 0"'	6' - 0"	MTL.	ALUM./WD	YES	LOUVER	CASEMENT	BLOCK	YES	NO	YES	NO TRIM	NO TRIM	YES	YES	NO	NO	NO

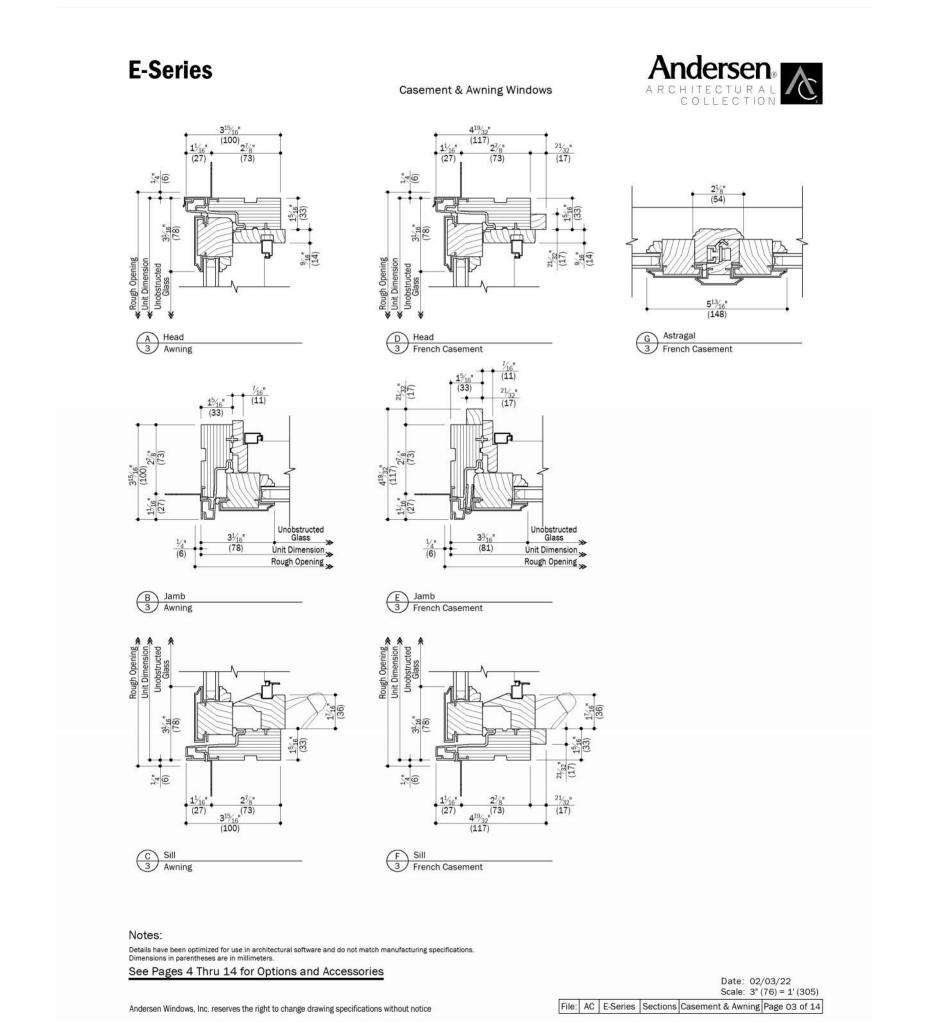







SIMULATED DIVIDED LIGHT


exterior grilles without grille spacer bars.

An economical solution featuring permanent interior and

ANDERSON

E-SERIES FRENCH CASEMENT

ACTIVE LEFT - PASSIVE RIGHT OPERATION

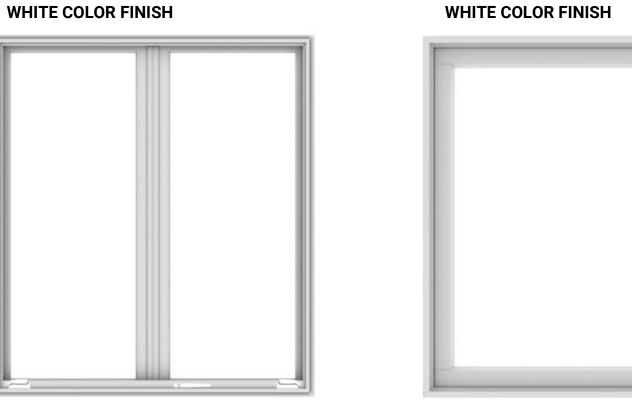

ANDERSON

AWNING

E-SERIES WINDOW

ARCHITECTURALLY AUTHENTIC GRILLES

We offer a variety of grille styles and patterns to choose from, or design your own with varying lines, curves and shapes.

FULL DIVIDED LIGHT

Features permanent interior and exterior grilles with grille spacer bars between two panes of insulating glass. A traditional divided light look with modern energy efficiency.









Chamfer -

Ovolo (colonial)

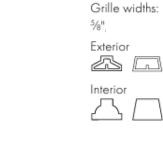


THE FOLLOWING WINDOW SIZES WILL BE

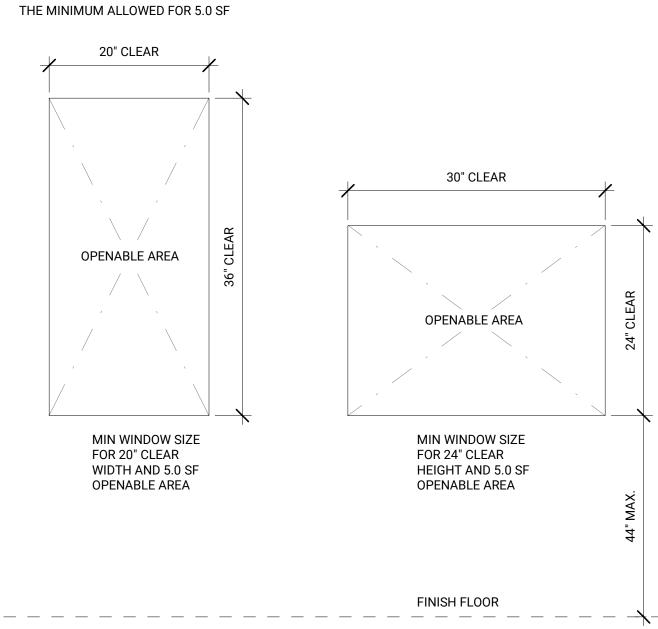



1. 20" MIN CLEAR WIDTH

2. 24" MIN CLEAR HEIGHT

3. 5.0 SF MIN. OPENABLE AREA AT GRADE FLOOR ONLY, 5.7 SF MIN ELSEWHERE.

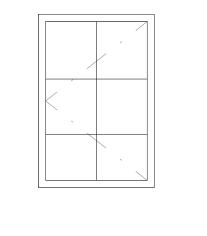

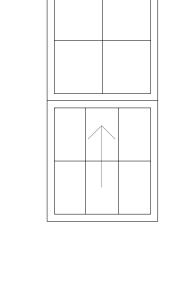

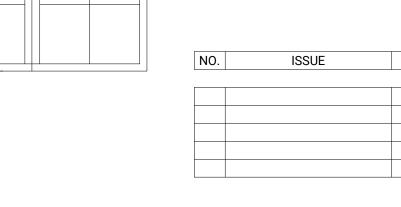

SINGLE / DOUBLE HUNG: 3'-0"X5'-0" SLIDER: SINGLE CASEMENT: 4'-0"X4'-0" 2'-4"X4'-0" 3'-0"X5'-6" 5'-0"X3'-6" 2'-6"X3'-6" 3'-4"X5'-0" 6'-0"X3'-0" DOUBLE CASEMENT: 3'-8"X5'-0" 4'-8"X 4'-0" 4'-0"X5'-0" CASEMENT/FIXED SLIDER / FIXED COMBO 8'-0"X4'-0" COMBO: 7'-0"X4'-0" SINGLE / FIXED COMBO: 10'-0"X4'-0" OTHER WINDOW TYPES: NONE W/O MANUF DATA. 12'-0"X3'-0" AWNING & BAY W/ FIXED CENTER: NONE W/O

GENERAL NOTES:

MANUF. DATA.

- 1. ALL MANUFACTURED DOORS AND WINDOWS SHALL BE LABELED AND CERTIFIED BY THE CALIFORNIA ENERGY COMMISSION AND UL LABELED FOR RATED DOORS AND/OR WINDOWS.
- 2. GLASS PANES WITHIN 18" AFF OR LESS SHALL BE TEMPERED.
- 3. WHERE DOORS ARE LOCATED NEXT TO A WALL, THERE SHALL BE 2-1/2" MINIMUM CLEARANCE BETWEEN WALL FINISH SURFACE AND FACE OF DOOR IN A 30 DEGREE POSITION, UNLESS DETAILED OR DIMENSIONED OTHERWISE.
- 4. EGRESS DOORS SHALL BE READILY OPENABLE FROM INSIDE WITHOUT THE USE OF A KEY OR SPECIAL KNOWLEDGE

4" x 5.5" BOUNDARY RESERVED FOR AHJ APPROVAL STAMP



DATE

PROJECT ADDRESS: **926 E DRYDEN STREET** GLENDALE, CALIFORNIA 91207

ADDITION AND REMODEL

WINDOW SCHEDULES

PERMIT #:BSFD-018869-2024

PLANNING #: PMPA-003557-2024


ORIGINAL SHEET SIZE: 24" x 36"

PROJECT: 2024-008

1" = 1'-0" DRAWN BY:


10/23/2024



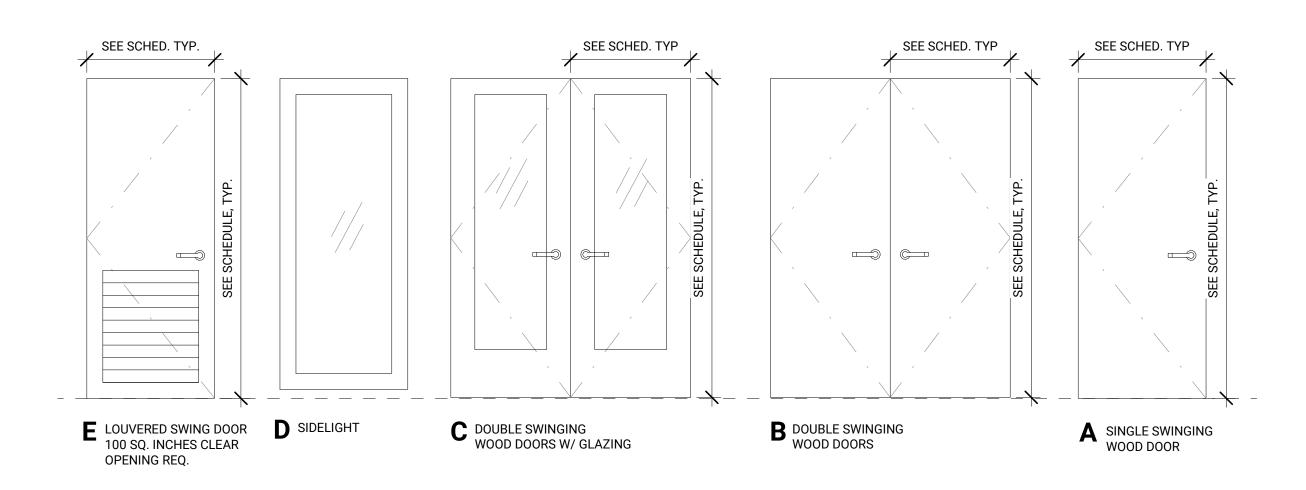

	DOOR SCHEDULE																			
	QUANTITY	(N) DOOR SIZE		(E) DOOR SIZE																WINDOW
DOOR NUMBER		(E) WIDTH	(E) HIGHT	(N) WIDTH	(N) HEIGHT	MATERIAL	VISIBLE FROM STREET	(E) OPERATION	NEW OPERATION	NEW FRAME TYPE	EXTERNAL GRID (SDL)	KEEP EXISTING SILL & FRAME			NEW EDGE DETAIL	BEDROOM	ENERGY EFFICIENT	TEMPERED GLASS	FIRED HAZARD ZONE	WITHIN 18" OI FLOOR OR 40 OF DOOR
801	1	2' - 8"	7' - 0"					Swing												
802	1	2' - 6"	6' - 8"					Swing												
1001	1	2' - 6"	6' - 8"					Swing												
1101	1	2' - 6"	6' - 8"					Swing												
1201	1	7' - 10"	7' - 0"	N/A	N/A	ALUM. WOOD	YES	N/A	SLIDING	NAIL-IN	NO	N/A	YES	N/A	NO TRIM	NO	YES	YES	NO	NO
1701	1	2' - 6"	6' - 8"					Swing												

ANDERSON E-SERIES INSWING DOOR 2 PANEL FRENCH PASSIVE LEFT - ACTIVE RIGHT OPERATION WHITE COLOR FINISH

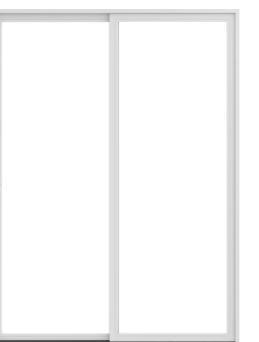

RESIDENTIAL SECURITY NOTES:

- ALL OPENINGS MARKED * ARE SECURITY OPENINGS AND THE FOLLOWING NOTES SHALL APPLY:
- EACH UNIT IN A RESIDENTIAL DEVELOPMENT SHALL BE KEYED DIFFERENTLY THAN ANY OTHER UNITS UNDER THE SAME GENERAL PLAN. A CERTIFICATE FROM THE LOCK SUPPLIER DECLARING THAT ALL LOCKS SUPPLIED TO THE PROJECT ARE KEYED SEPARATELY SHALL BE ACCEPTABLE AS COMPLYING WITH THE ABOVE REQUIREMENTS.
- DOOR JAMBS SHALL HAVE A SOLID BACKING WITH NO VOIDS EXIST BETWEEN THE STRIKE SIDE OF THE JAMB AND THE FRAME OPENING FOR A VERTICAL DISTANCE OF SIX (6) INCHES (153MM) EACH SIDE OF THE STRIKE.
- IN WOOD FRAMING, HORIZONTAL BLOCKING SHALL BE PLACED BETWEEN STUDS AT DOOR LOCK HEIGHT FOR THREE (3) STUD SPACES EACH SIDE OF THE DOOR OPENINGS. JAMBS SHALL HAVE SOLID BACKING AGAINST SOLE PLATES.
- 4. IRON OR STEEL SCREENS SHALL BE 1/8" THICK WITH 2" MESH SECURELY FASTENED.
- IRON BARS SHALL BE 1/2" DIAMETER BARS OR 1" X 1/4" FLAT STEEL SPACED AT 5" MAX. SECURELY FASTENED.
- CYLINDER GUARDS SHALL BE ATTACHED WITH 1/2" CONNECTING SCREWS, AND SHALL BE INSTALLED WHENEVER THE CYLINDER PROJECTS BEYOND THE FACE OF THE DOOR, OR IS OTHERWISE ACCESSIBLE TO GRIPPING TOOLS.
- 7. DOOR STOPS FOR IN-SWINGING DOORS SHALL BE INTEGRATED (RABETTED) WITH THE JAMB. JAMBS FOR ALL DOORS SHALL BE CONSTRUCTED OR PROTECTED SO AS TO PREVENT VIOLATION OF THE STRIKE.
- 8. THE STRIKE PLATE FOR DEADBOLTS ON ALL WOOD FRAME DOORS SHALL BE CONSTRUCTED OF AT LEAST SIXTEEN (16) U.S. GAUGE STEEL, BRONZE, OR BRASS AND SECURED TO THE JAMB BY A MINIMUM OF TWO SCREWS.
- HINGES FOR OUT-SWINGING DOORS SHALL BE EQUIPPED WITH NON-REMOVABLE HINGE PINS OR A MECHANICAL INTERLOCK TO PRECLUDE REMOVAL OF THE DOOR FROM THE EXTERIOR BY REMOVING THE HINGE PINS.
- 10. LOUVERED WINDOWS SHALL NOT BE USED WHEN ANY PORTION OF THE WINDOW IS LESS THAN 12 FEET (3658MM) VERTICALLY OR 6 FEET (1829MM) HORIZONTALLY FROM AN ACCESSIBLE SURFACE OR ANY ADJOINING ROOF, BALCONY, LANDING, STAIR TREAD, PLATFORM, OR SIMILAR STRUCTURE.

GENERAL NOTES:

- 1. ALL MANUFACTURED DOORS AND WINDOWS SHALL BE LABELED AND CERTIFIED BY THE CALIFORNIA ENERGY COMMISSION AND UL LABELED FOR RATED DOORS AND/OR WINDOWS.
- 2. GLASS PANES WITHIN 18" AFF OR LESS SHALL BE TEMPERED.
- WHERE DOORS ARE LOCATED NEXT TO A WALL, THERE SHALL BE 2-1/2" MINIMUM CLEARANCE BETWEEN WALL FINISH SURFACE AND FACE OF DOOR IN A 30 DEGREE POSITION, UNLESS DETAILED OR DIMENSIONED OTHERWISE.
- EGRESS DOORS SHALL BE READILY OPENABLE FROM INSIDE WITHOUT THE USE OF A KEY OR SPECIAL KNOWLEDGE OR EFFORT.



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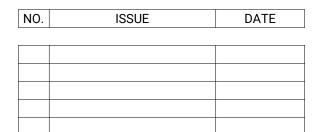
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PROJECT ADDRESS:

926 E DRYDEN STREET GLENDALE, CALIFORNIA 91207

ADDITION AND REMODEL

DOOR SCHEDULES

PERMIT #:BSFD-018869-2024

4" x 5.5" BOUNDARY RESERVED FOR AHJ APPROVAL STAMP PLANNING #: PMPA-003557-2024

ORIGINAL SHEET SIZE: 24" x 36"

PROJECT: 2024-008

1/2" = 1'-0"

DRAWN BY:

10/23/2024

ARCHITECT

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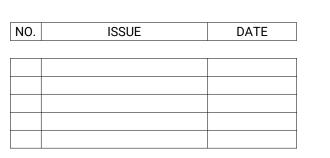
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PROJECT ADDRESS: **926 E DRYDEN STREET** GLENDALE, CALIFORNIA 91207

ADDITION AND REMODEL

4" x 5.5" BOUNDARY RESERVED FOR AHJ APPROVAL STAMP

INTERIOR ELEVATIONS

PERMIT #:BSFD-018869-2024

PLANNING #: PMPA-003557-2024


ORIGINAL SHEET SIZE: 24" x 36"

PROJECT: 2024-008


1/2" = 1'-0"

10/23/2024




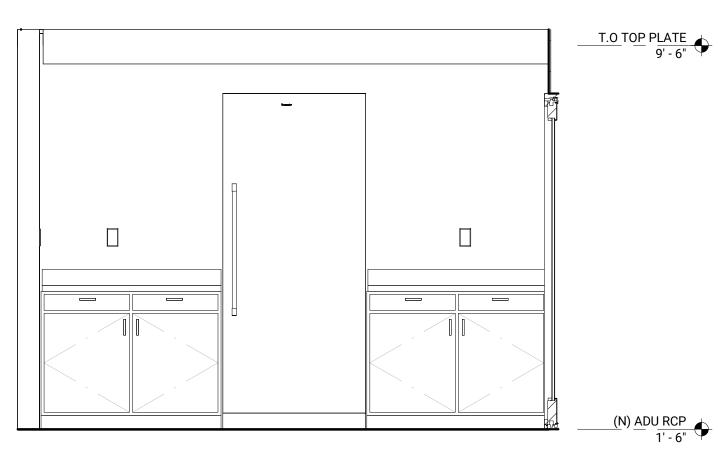


3 KITCHEN INTERIOR ELEVATION 3
1/2" = 1'-0"

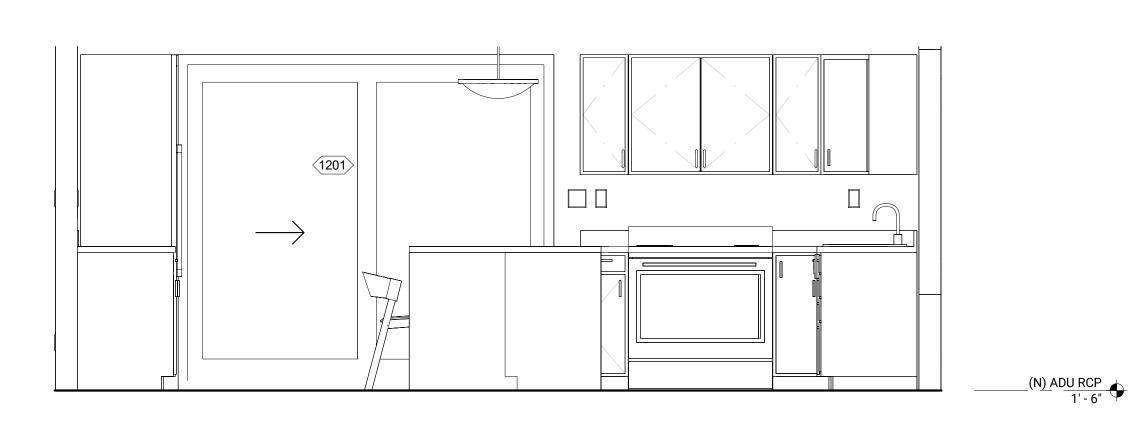

2 KITCHEN INTERIOR ELEVATION 2
1/2" = 1'-0"

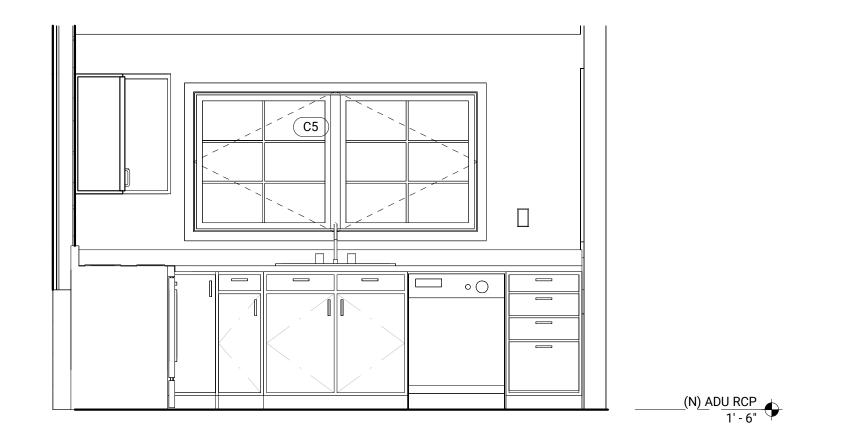

1 KITCHEN INTERIROR ELEVATION 1
1/2" = 1'-0"

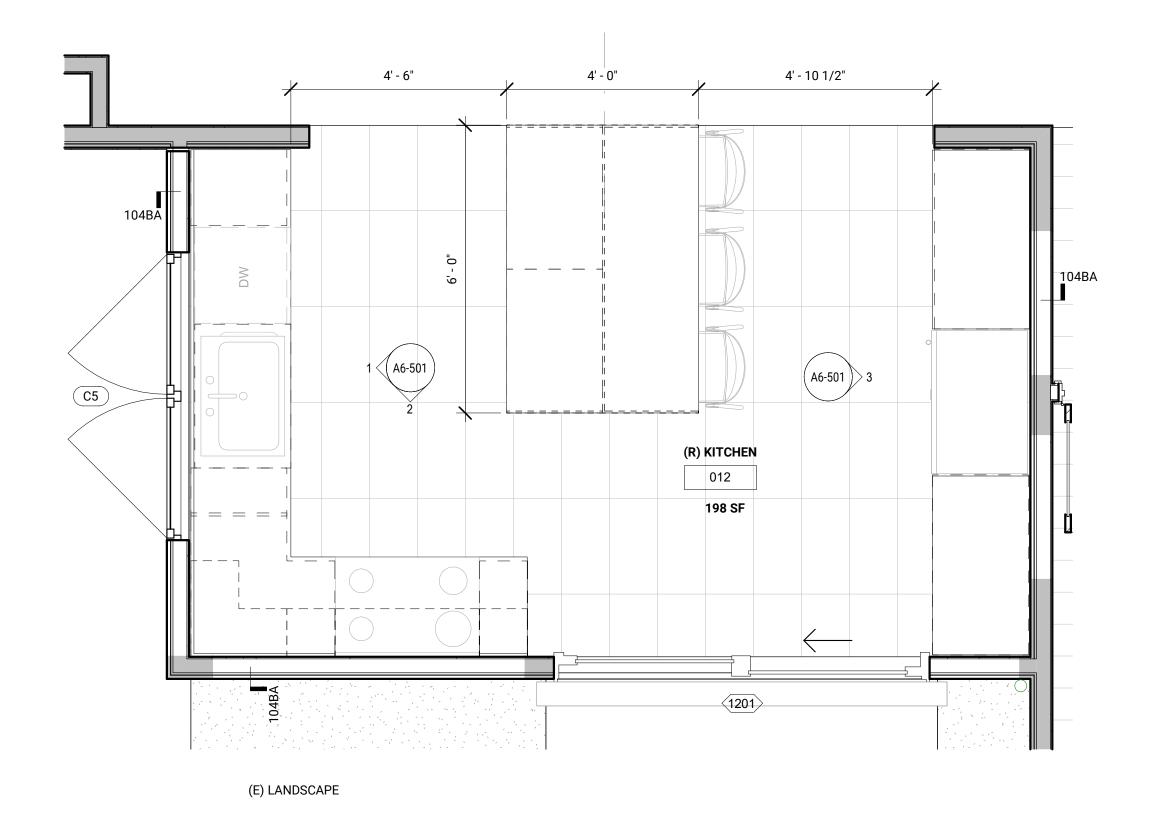

4 (N) ENLARGE MAIN HOUSE KITCHEN
1/2" = 1'-0"

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ARCHITECT

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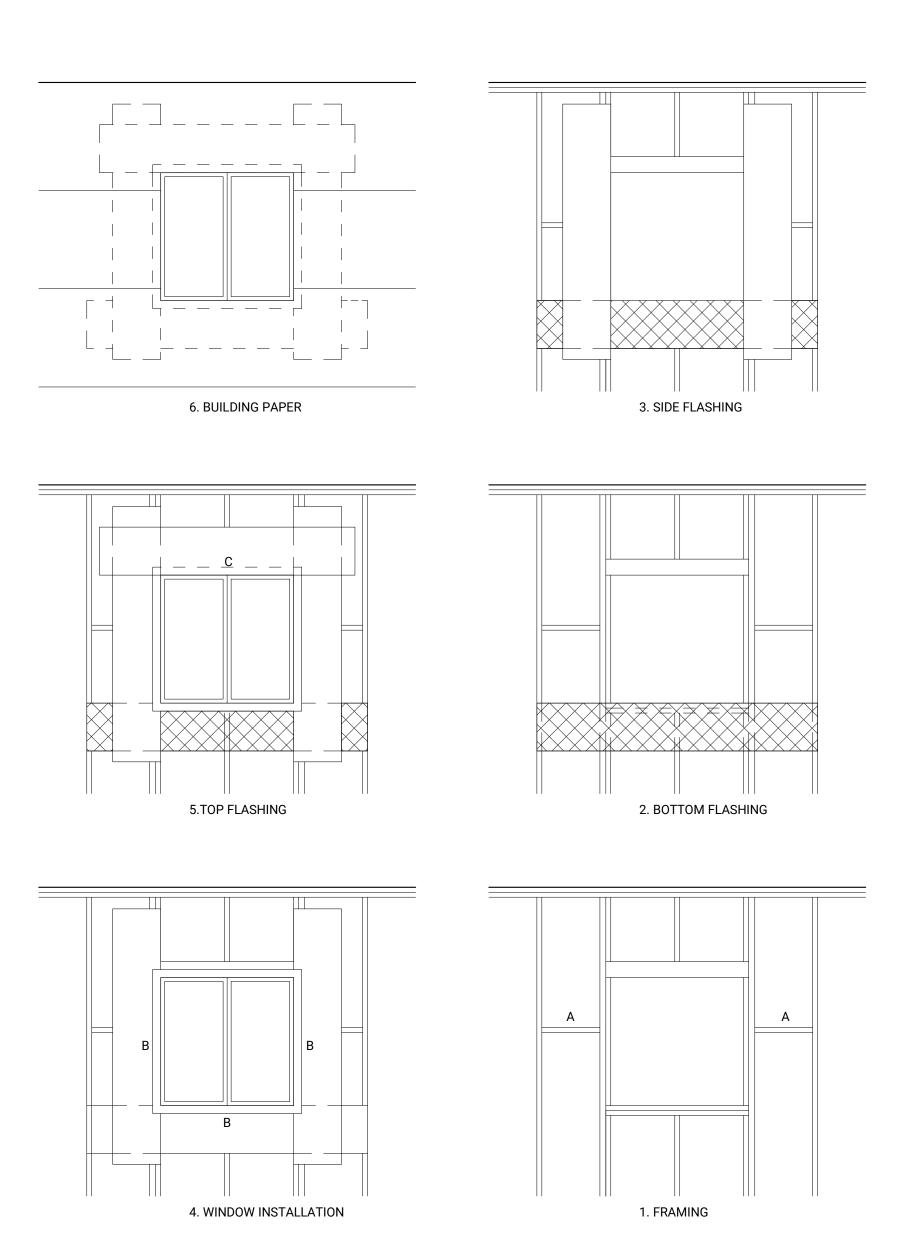
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WINDOW FLASHING DIAGRAM

WINDOW FLASHING NOTES:

- 1. FRAMING WHERE THE OPENING OCCURS IN A WALL WITHOUT EXTERIOR PLYWOOD SHEATHING, THE BLOCKING MEMBERS (A) SHOULD BE INSTALLED AS NECESSARY TO SUPPORT THE OUTSIDE EDGES OF SIDE FLASHING. INSTALL APPROX 16" OC. BLOCKING MAY BE OMITTED WHEN A STUD IS INSTALLED TO SUPPORT THE OUTSIDE EDGE OF SIDE FLASHING.
- 4. INSTALL THE WINDOW BY FIRMLY PRESSING THE NAIL FLANGE ONTO A WINDOW CAN BE TRUED AND NAILED INTO PLACE PER MANUFACTURERS INSTRUCTIONS.
- 5. INSTALL THE TOP FLASHING STRIP HORIZONTAL, OVER THE TOP NAILING FLANGE. PRESS THE BOTTOM EDGE OF THE FLASHING STRIP INTO A CONTINUOUS, FULL CONTACT BED OF SEALANT (C) ON THE FULL HEIGHT OF THE OUTSIDE FACE OF THE NAILING FLANGE FOR A WATER TIGHT INSTALLATION. EXTEND THE ENDS OF THE TOP FLASHING STRIP SO THAT IT AS LEAST OVERLAPS THE OUTER EDGES OF THE SIDE FLASHING STRIPS.
- 6. STARTING AT THE BOTTOM OF THE WALL, INSTALL THE WATERPROOF BUILDING PAPER IN "SHINGLE" FASHION UP THE WALL. THE LAYER WHICH FALLS AT THE BOTTOM OF THE WINDOW OPENING SHOULD BE LAPPED UNDER THE BOTTOM FLASHING, SUCCESSIVE LAYERS OF BUILDING PAPER SHOULD LAP OVER THE SIDE NAILING FLANGES.


PENETRATION NOTES:

- 1. PENETRATING ITEM (BOLTS, BRACKET, BASE PLATES ETC.) INSTALLED OVER SELF-SEALING, SELF-HEALING, ADHESIVE-BACKED RUBBERIZED ASPHALTIC WALL FLASHING (BITUTHANE, PERM-A-BARRIER).
- 2. WHEN ADHERING THE MEMBRANE TO SUBSTRATE, DO NOT REMOVE THE ADHESIVE RELEASE SHEET FROM THE BOTTOM 3" OF THE SHEET SO THAT IT CAN BE LAPPED OVER BUILDING PAPER.
- 4. PLACE THE SIDE SHEETS OF BUILDING PAPER TO WITHIN + 1" OF THE PENETRATING ITEM. SHINGLE OVER THE BOTTOM FLASHING/ BUILDING PAPER JOINT.
- 5. PLACE THE TOP SHEET OF BUILDING PAPER TO WITHIN + 1" OF THE PENETRATING ITEM. SHINGLE OVER THE PREVIOUS LAYERS OF BUILDING PAPER. ENTIRE ASSEMBLY SHOULD BE SHINGLED INTO THE OVERALL BUILDING PAPER SKIN OF THE BUILDING.

4" x 5.5" BOUNDARY RESERVED FOR AHJ APPROVAL STAMP

- 2. BOTTOM FLASHING APPLY THE FIRST STRIP OF FLASHING HORIZONTAL, TIGHT TO THE BOTTOM OF THE WINDOW OPENING. EXTEND FLASHING GREATER THAN 12" PAST THE SIDES OF THE OPENING AND ATTACH TO THE NEXT AVAILABLE STUD. Fasten ONLY THE TOP EDGE SO THAT SUBSEQUENT LAYERS OF BUILDING PAPER MAY BE LAPPED UNDER, (SHINGLED).
- 3. INSTALL THE TWO SIDE FLASHING STRIPS VERTICAL, TIGHT TO THE SIDES OF THE WINDOW OPENING. EXTEND FLASHING ABOVE THE TOP AND BELOW THE BOTTOM OF THE OPENING FOR A DISTANCE EQUAL TO AT LEAST THE WIDTH OF THE FLASHING STRIP. THE BOTTOMS OF THE VERTICAL SIDE STRIPS SHOULD LAP OVER THE BOTTOM HORIZONTAL STRIP AND SHOULD NOT BE NAILED SO THAT SUBSEQUENT LAYERS OF BUILDING PAPER MAY BE LAPPED UNDER, (SHINGLED).
- CONTINUOUS, FULL CONTACT BEAD OF COMPATIBLE SEALANT (B) EXTENDING AROUND THE BOTTOM AND SIDES OF THE OPENING, BUT NOT AT THE TOP. THE

- 3. PLACE BUILDING PAPER UNDER THE BOTTOM 3" FLAP. REMOVE THE REMAINING RELEASE SHEET FROM THE FLASHING SHEET AND ADHERE TO THE BUILDING

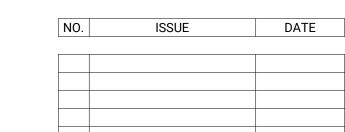



PROJECT ADDRESS: **926 E DRYDEN STREET** GLENDALE, CALIFORNIA 91207

ADDITION AND REMODEL

WATERPROOFING **DETAILS**

PERMIT #: BSFD-018869-2024

PLANNING #: PMPA-003557-2024

ORIGINAL SHEET SIZE: 24" x 36"

PROJECT: 2024-008

DRAWN BY:

SCALE:

10/23/2024



ARCHITECT

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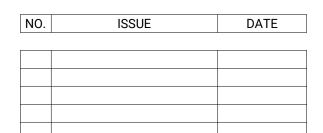
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PROJECT ADDRESS:

926 E DRYDEN STREET
GLENDALE, CALIFORNIA 91207

ADDITION AND REMODEL

TITLE

EXTERIOR DOOR DETAILS

PERMIT #:BSFD-018869-2024

4" x 5.5" BOUNDARY RESERVED FOR AHJ APPROVAL STAMP

PLANNING #: PMPA-003557-2024

ORIGINAL SHEET SIZE: 24" x 36"

PROJECT:

2024-008 SCALE:

As indicated DRAWN BY:

10/23/2024

SHEET NUMBER:

6_001




GLENDALE SECURITY LIGHTING NOTES:

LIGHTING; MULTIPLE FAMILY DWELLING. LIGHTING IN MULTIPLE FAMILY DWELLINGS

- 14.1 AISLES, PASSAGEWAYS AND RECESSES: AISLES, PASSAGEWAYS AND RECESSES RELATED TO AND WITHIN THE BUILDING COMPLEX SHALL BE ILLUMINATED WITH AN INTENSITY OF AT LEAST TWENTY-FIVE HUNDREDTHS (.25) OF A FOOTCANDLE (2.7 LUX) AT THE GROUND LEVEL DURING THE HOURS OF DARLNESS. LIGHTING DEVICES SHALL BE PROTECTED BY WEATHER AND VANDALISM-RESISTANT COVERS.
- 14.2 PARKING STRUCTURE, PARKING LOTS AND CARPORTS: PARKING STRUCTURES, PARKING LOTS AND CARPORTS SHALL BE PROVIDED WITH A MINIMUM OF TWO (2) FOOTCANDLES (21.5 LUX) OF LIGHT ON THE PARKING SURFACE DURING THE HOURS OF DARKNESS. LIGHTING DEVICES SHALL BE PROTECTED BY WEATHER AND VANDALISM-RESISTANT COVERS.
- NOTE: THESE NOTES ARE INTENDED AS A GUIDE ONLY. CONTRACTOR AND SUPPLIER SHALL REFER TO THE GLENDALE BUILDING AND SAFETY CODE, VOLUME VII FOR MORE COMPLETE AND SPECIFIC

CARBON MONOXIDE ALARMS:

- AN APPROVED CARBON MONOXIDE ALARM SHALL BE INSTALLED FOR EXISTING BUILDINGS AND NEW CONSTRUCTION WHEN THE DWELLING UNIT CONTAINS A FUEL-FIRED APPLIANCE, FIREPLACE, AND/OR AN ATTACHED GARAGE WITH AN OPENING THAT COMMUNICATES WITH THE DWELLING. (CRC 315.2.1, CBC 915.1.1, CBC 915.1.5)
- CO ALARMS SHALL BE "HARD WIRED" AND SHALL BE EQUIPPED WITH BATTERY BACKUP. (CRC R315.5, CBC 915.4.1)
- CO ALARMS SHALL BE LISTED FOR COMPLIANCE WITH UL 2034, UL 217, UL 2075, AND MAINTAINED PER NFPA 720. (CRC R315.1.1, R315.7.2, CBC 915.4.2, CBC 915.4.4, CBC 915.5.2)
- CO ALARMS SHALL BE INSTALLED OUTSIDE OF EACH SLEEPING AREA IN THE IMMEDIATE VICINITY OF THE BEDROOMS AND ON EVERY LEVEL OF A DWELLING UNIT INCLUDING BASEMENT. (CRC R315.3, CBC 915.2)
- CO ALARMS SHALL BE INTERCONNECTED SUCH THAT THE ACTIVATION OF ONE ALARM WILL ACTIVATE ALL ALARMS IN THE INDIVIDUAL DWELLING UNIT. (CRC R315.5, CBC 915.4.5)
- IN EXISTING DWELLING UNIT, A CO ALARM IS PERMITTED TO BE BATTERY OPERATED WHERE REPAIR OR ALTERATION DO NOT RESULT IN THE REMOVAL OF WALL OR CEILING FINISHES. (CRC R315.5 EXCEPTION 4, CBC 915.4.1 EXCEPTION 3)

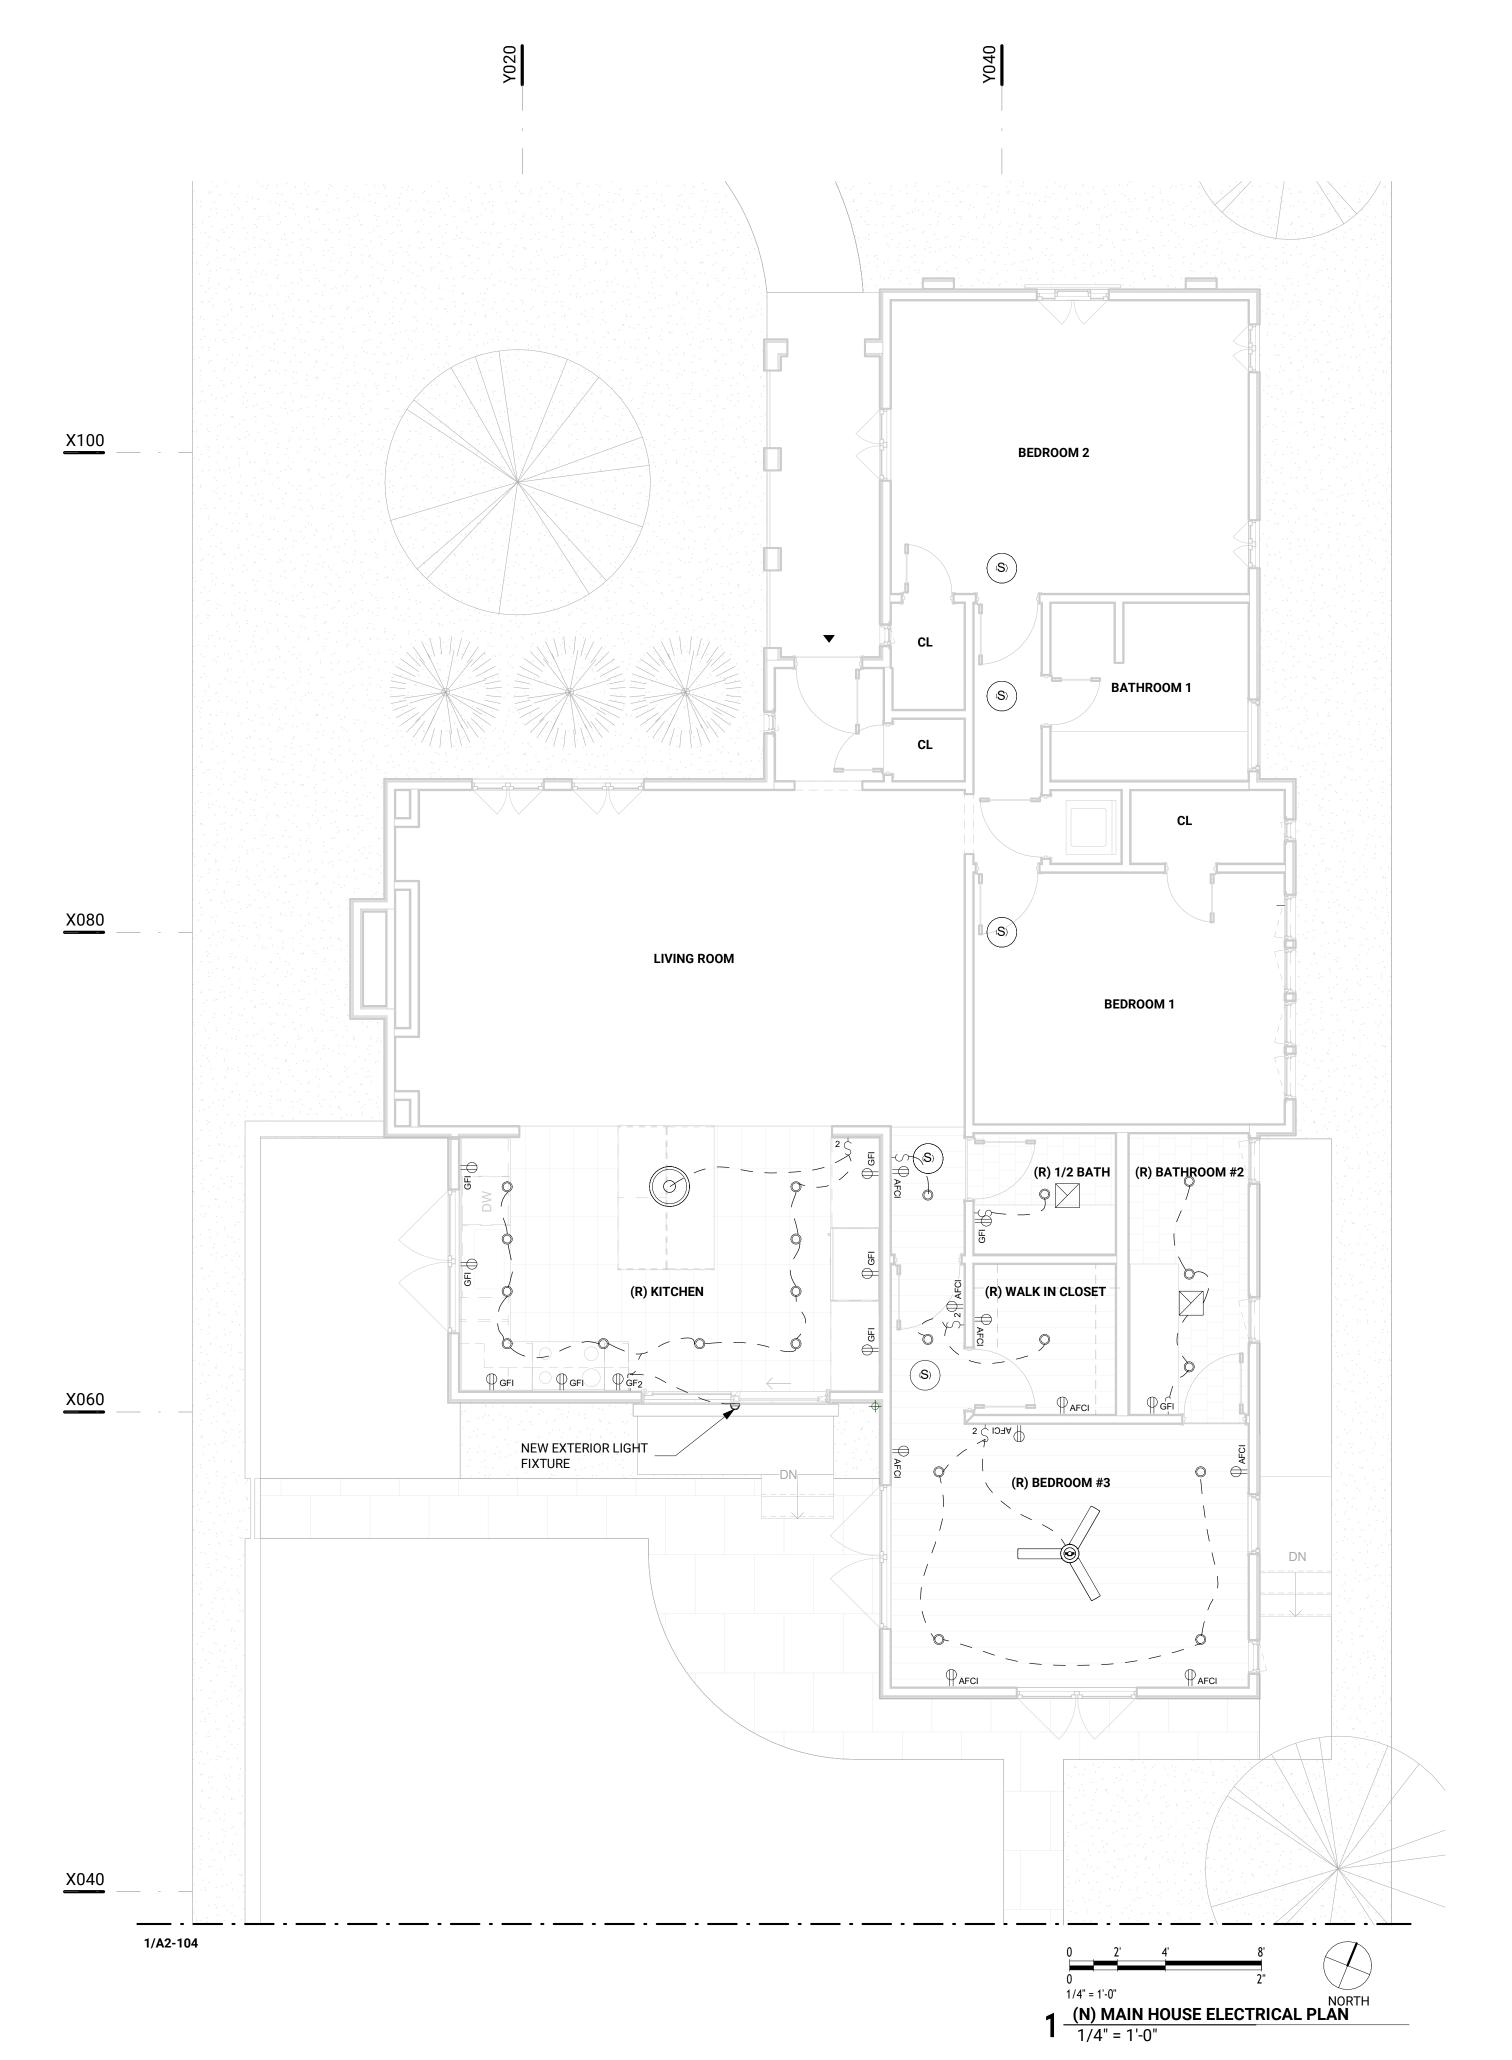



KARABACHIAN ARCHITECTS, INC. − − − EXISTING WALL TO BE DEMOLISHED

ARCHITECT

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CONTROL.

LEGEND:

_____ NEW WALL

— - - — PROPERTY LINE

- - ROOF OVERHEAD

— — — SETBACK LINE

EXISTING WALL TO REMAIN

RECESSED DOWN LIGHT

CUSTOM LIGHT

WALL SCONE LIGHT

LINEAR AND/OR BUILT-IN FIXTURE

MONOXIDE ALARM

CEILING MATERIAL

CEILING HEIGHT

RECESSED SPRINKLER HEAD

WALL MOUNTED SPRINKLER HEAD

COMBINATION SMOKE AND CARBON

EXHAUST FAN 50CFM INTERMITTENT

AT ALL BATHROOM LOCATIONS FANS SHALL

BE ENERGY STAR COMPLIANT AND DUCTED

TO TERMINATE OUTSIDE OF THE BUILDING.


FANS MUST BE CONTROLLED BY A HUMIDITY


WALL MOUNTED LIGHT FIXTURE

SYMBOL	DESCRIPTION	MOUNTING HEIGHT, UNC
\$ ^{x,x}	LIGHT WALL SWITCH, D=DIMMER,#=#-WAY (EX. 3-WAY), DA=DOOR ACTIVATED, MA=MOTION ACTIVATED	44" AFF
\$ ^{S,#}	SHADE WALL SWITCH, #=NUMBER OF PROGRAMMABLE SWITCH MODULES REQUIRED	44" AFF
фxx	DUPLEX WALL OUTLET, GFCI=GROUND FAULT CIRCUIT INTERRUPTER 39"AFF, WP=WATERPROOF 15"AFF, AFCI=ARC FAULT PROTECTED	9" AFF TYP 15" AFF WP 39" AFF GFC
(TV)	CABLE/ DATA WALL OUTLET	9" AFF
M	DUAL MOTORS (BLACK OUT, SHADE), INDEPENDENTLY CONTROLLED	NA
TX	OPERATIVE TEMPERATURE SENSOR, H=WTIH HUMIDITY SENSOR	36" AFF
xx	CONTROL PANEL/SENSOR, T=THERMOSTAT, S=SECURITY, AQ=AIR QUALITY, DS=DAYLIGHT SENSOR	54" AFF

ELECTRICAL NOTES:

- 1. ALL INSTALLED LUMINARIES SHALL BE HIGH EFFICIENCY FIXTURES (CEnC 150.0(K)1.A). HIGH EFFICIENCY LUMINARIES MUST BE PIN BASED.
- 2. KITCHEN AND BATHROOM RECEPTACLES SHALL BE ON SEPARATE CIRCUITS. NO OTHER OUTLETS MAY BE ON THE CIRCUIT.
- 3. SMOKE ALARMS SHALL BE INTERCONNECTED HARD-WIRED WITH A BATTERY BACKUP AND SHALL BE INSTALLED IN ACCORDANCE WITH NFPA 72. THEY SHALL BE LOCATED OUTSIDE OF EACH SEPARATE SLEEPING AREA IN THE IMMEDIATE VICINITY OF THE BEDROOMS. ON EACH ADDITIONAL STORY OF THE DWELLING, INCLUDING BASEMENTS AND HABITABLE ATTICS, BUT NOT INCLUDING CRAWL SPACES AND UNINHABITABLE ATTICS. BATTERY SMOKE ALARM PERMITTED IN EXISTING BUILDINGS WHERE NO CONSTRUCTION IS TAKING PLACE. SMOKE ALARMS SHALL BE TESTED AND MAINTAINED IN ACCORDANCE WITH MANUFACTURER INSTRUCTIONS. SMOKE ALARM SHALL BE REPLACED AFTER 10 YEARS FROM THE DATE OF MANUFACTURED MARKED ON THE UNIT. CONVENTIONAL IONIZATION SMOKE ALARMS THAT ARE SOLELY BATTERY POWERED SHALL BE EQUIPPED WITH A 10 YEAR BATTERY AND HAVE A SILENCE FEATURE.
- 4. CARBON MONOXIDE ALARMS SHALL BE INTERCONNECTED HARD-WIRED WITH A BATTERY BACKUP. LOCATED OUTSIDE OF EACH SEPARATE SLEEPING AREA IN THE IMMEDIATE VICINITY OF THE BEDROOMS. ON EVERY LEVEL OF A DWELLING UNIT INCLUDING BASEMENTS. BATTERY CARBON MONOXIDE ALARM IS PERMITTED IN EXISTING DWELLING UNITS WHERE NO CONSTRUCTION IS TAKING PLACE.
- 5. GROUND-FAULT CIRCUIT-INTERRUPTION (GFCI) FOR PERSONNEL SHALL BE PROVIDED AND INSTALLED IN READILY ACCESSIBLE LOCATIONS.
- 6. ALL 120-VOLT, SINGLE-PHASE, 15 AND 20 AMP BRANCH CIRCUITS SUPPLYING OUTLETS (INCLUDING CLOSETS AND HALLWAYS) SHALL BE PROTECTED BY A LISTED ARC-FAULT CIRCUIT INTERRUPTER, COMBINATION TYPE, INSTALLED TO PROVIDE PROTECTION OF THE BRANCH CIRCUIT.
- 7. TAMPER-RESISTANT RECEPTACLES SHALL BE INSTALLED IN ALL AREAS SPECIFIED IN 210.52. ALL NON-LOCKING TYPE 12-VOLT: 15- AND 20- AMPERE RECEPTACLES SHALL BE LISTED TAMPER- RESISTANT RECEPTACLES.
- 8. DIMMERS OR VACANCY SENSORS SHALL CONTROL ALL LUMINARIES REQUIRED TO HAVE LIGHT SOURCES COMPLIANT WITH REFERENCE JOINT APPENDIX JA8 (CEnC 150.0(KI)

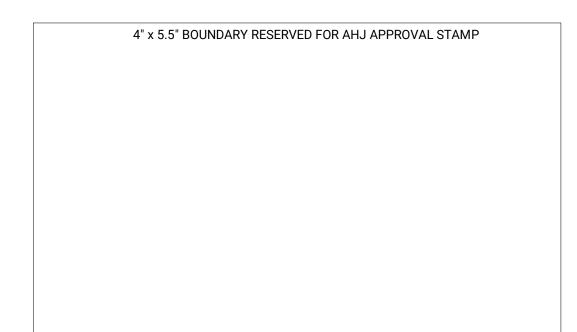

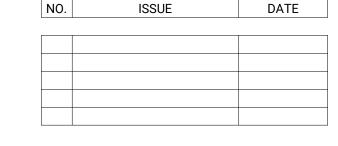



PROJECT ADDRESS: **926 E DRYDEN STREET**

GLENDALE, CALIFORNIA 91207

ADDITION AND REMODEL

MAIN HOUSE **ELECTRICAL PLAN**

PERMIT #:BSFD-018869-2024

PLANNING #: PMPA-003557-2024

ORIGINAL SHEET SIZE: 24" x 36"

PROJECT:


2024-008

As indicated

10/23/2024

SHEET NUMBER:



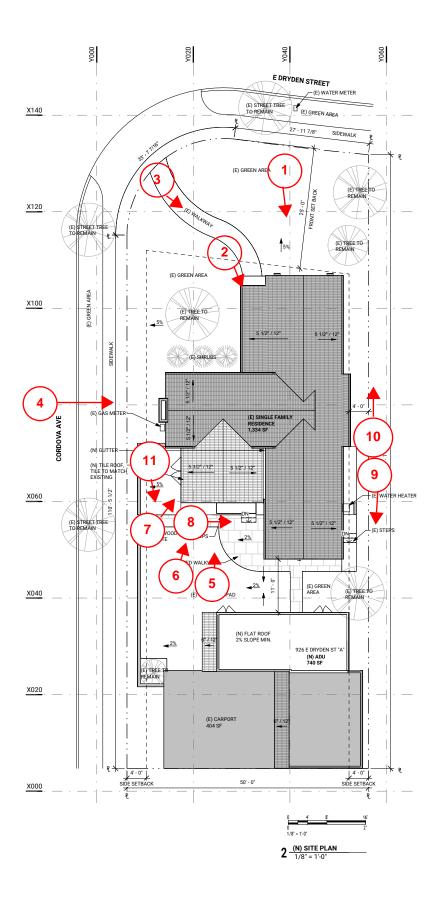

926 DRYDEN ST















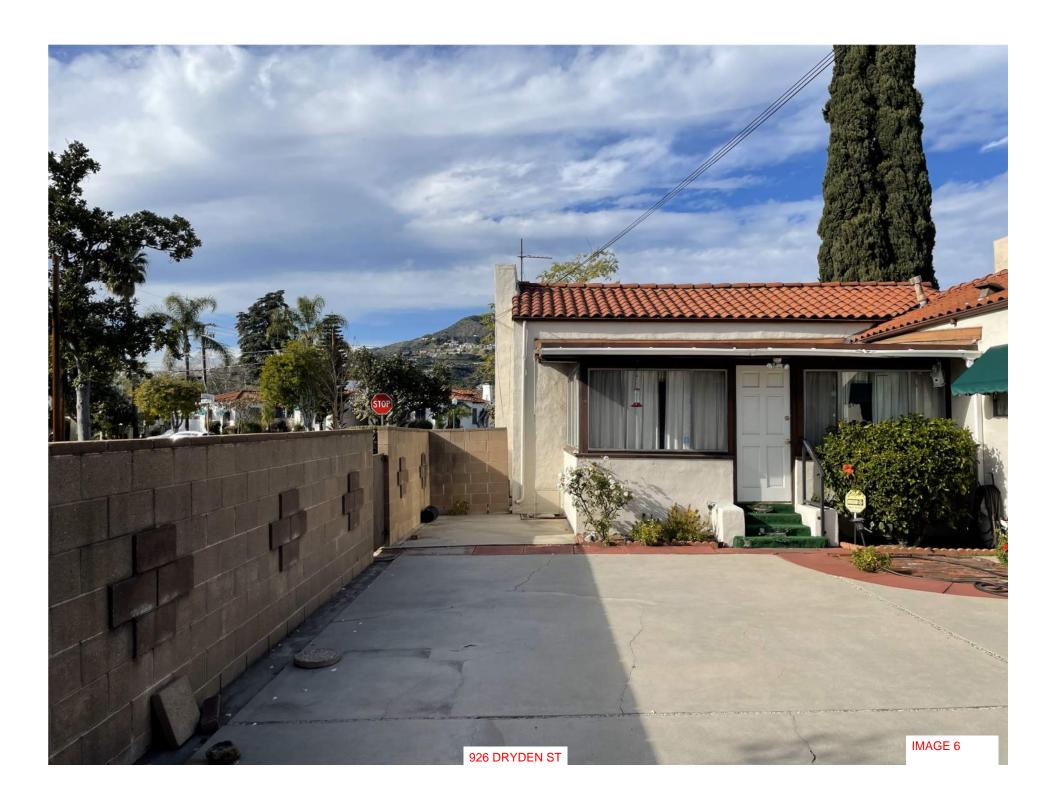

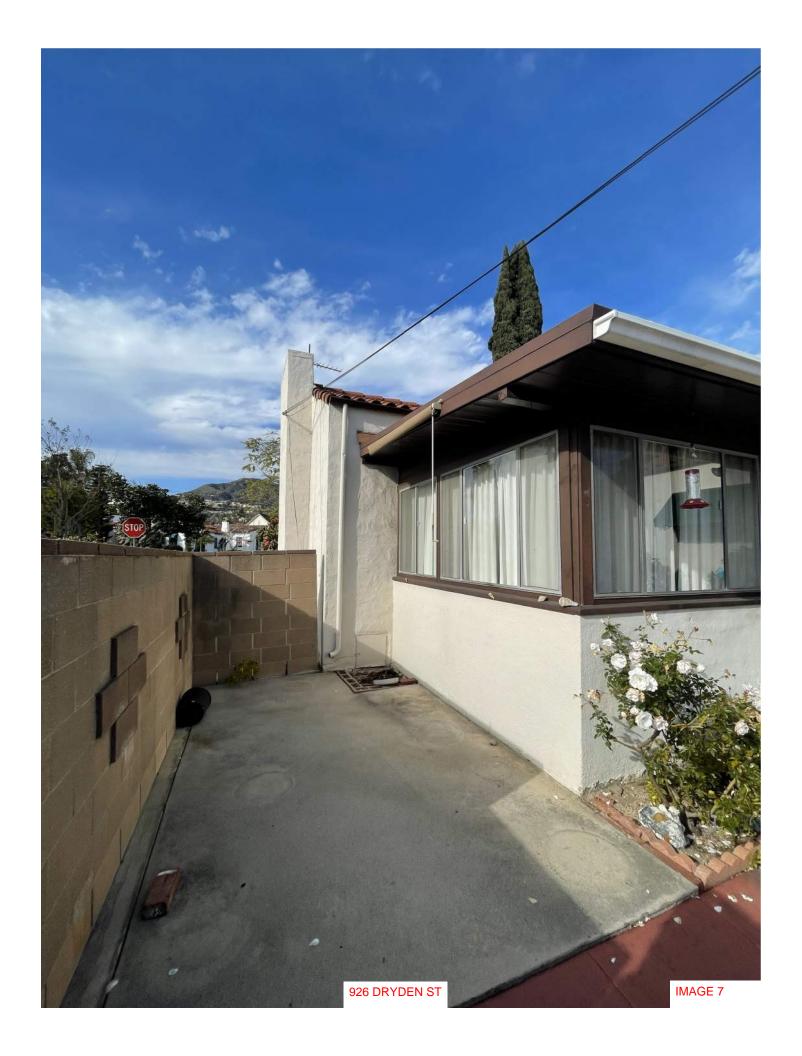



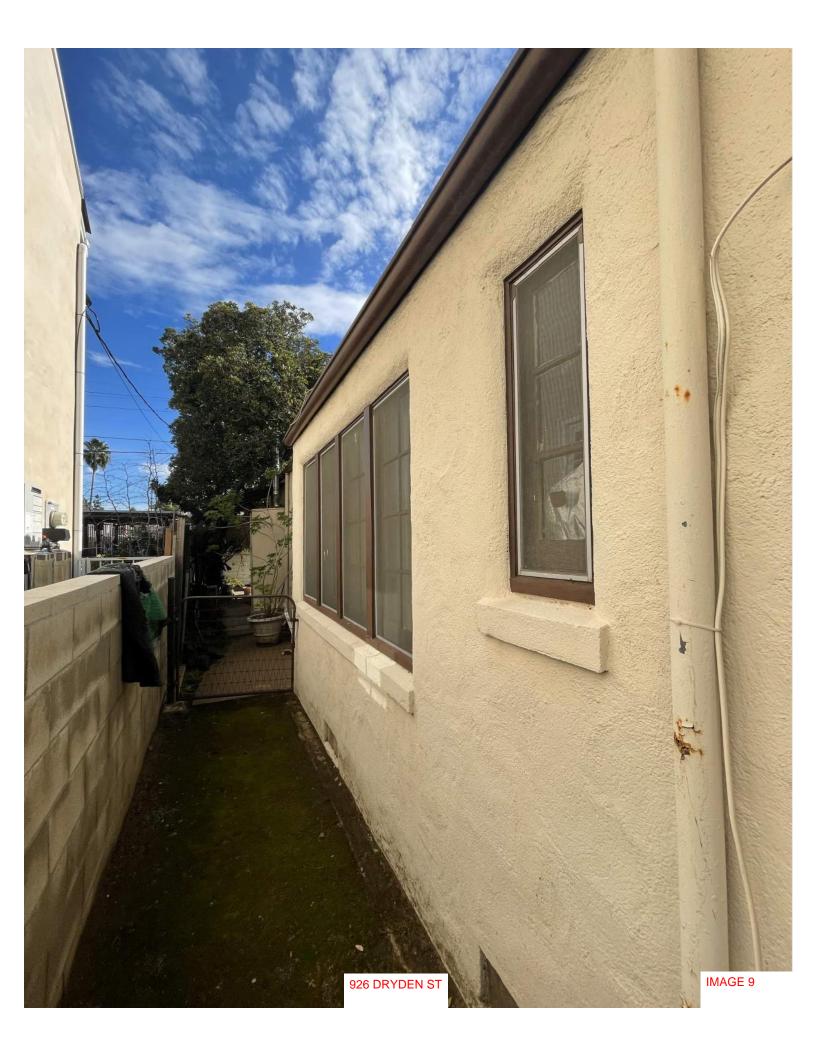

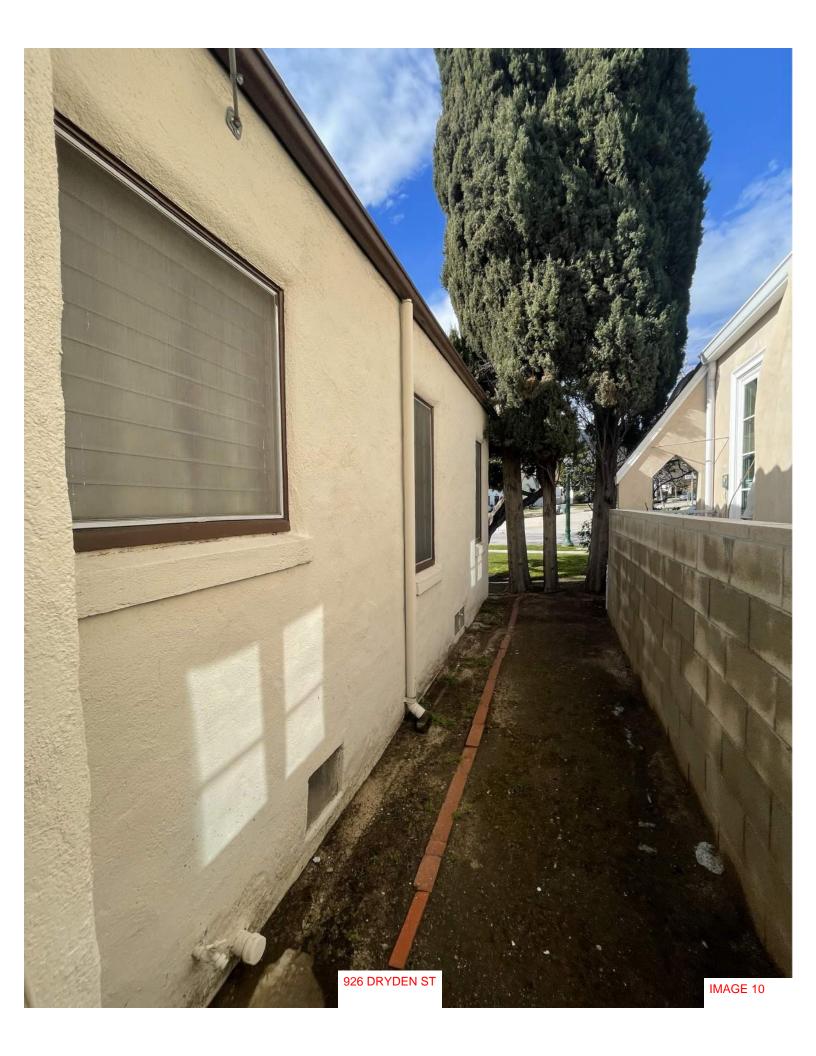



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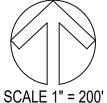
OWNERSHIP / OCCUPANTS LIST RADIUS MAPS - LAND USE - PLANS MUNICIPAL COMPLIANCE CONSULTING


926 DRYDEN ST.

GLENDALE, CA. 24-285

PROJECT INFORMATION

ZONING MAP



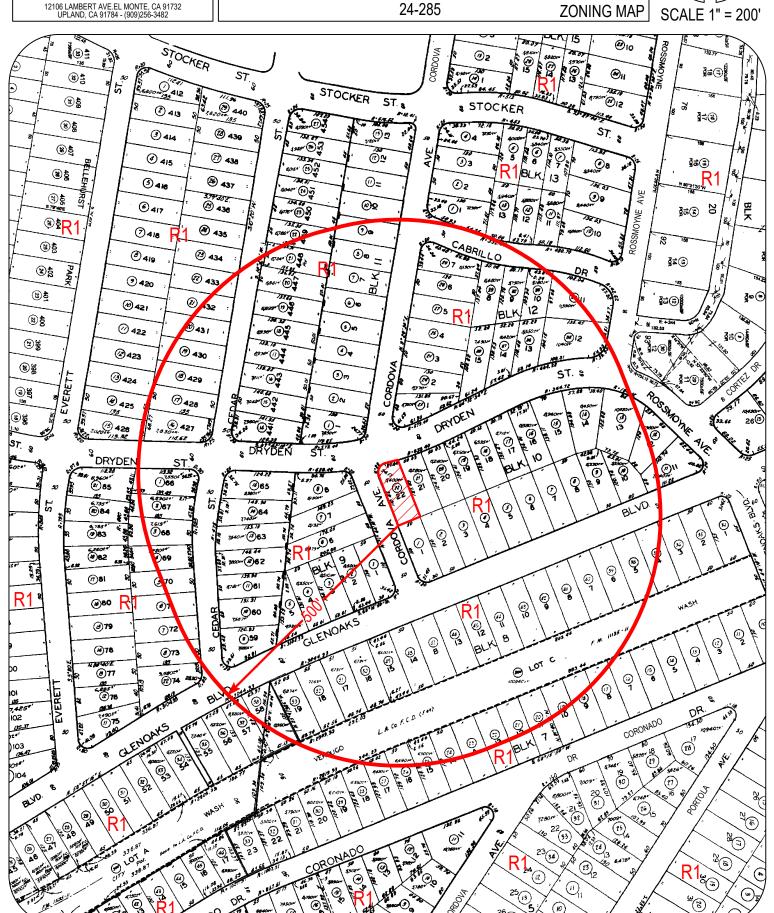

Services

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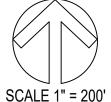
OWNERSHIP / OCCUPANTS LIST RADIUS MAPS - LAND USE - PLANS MUNICIPAL COMPLIANCE CONSULTING

12106 LAMBERT AVE.EL MONTE, CA 91732 UPLAND, CA 91784 - (909)256-3482

PROJECT INFORMATION

926 DRYDEN ST. GLENDALE, CA. 24-285

LOCATION MAP





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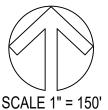
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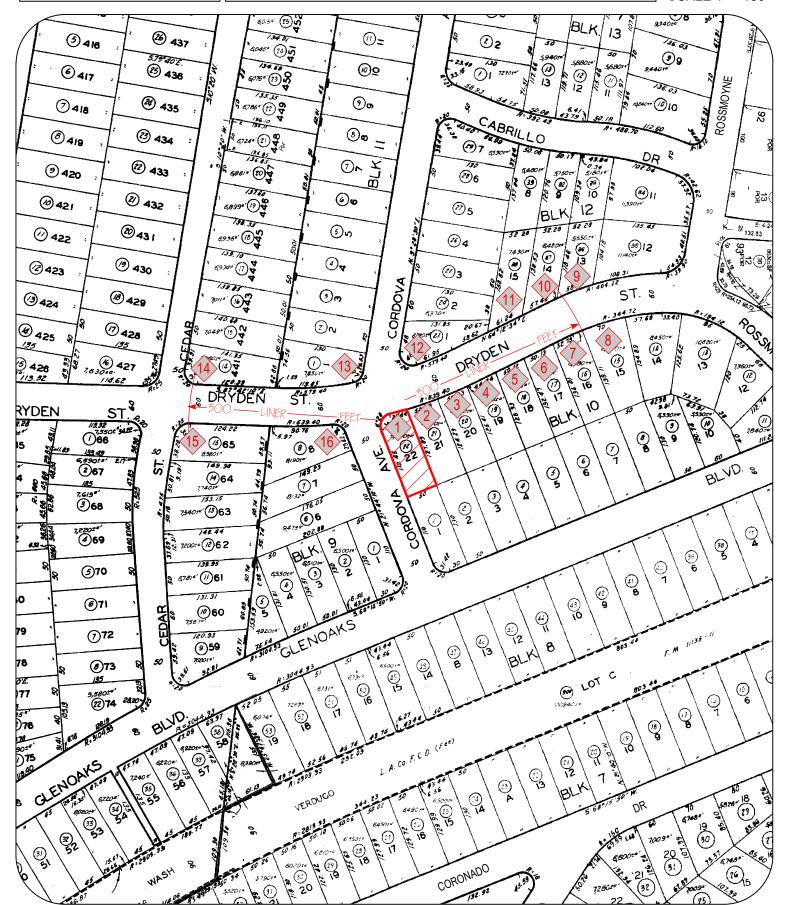
12106 LAMBERT AVE.EL MONTE, CA 91732 UPLAND, CA 91784 - (909)256-3482

PROJECT INFORMATION

926 DRYDEN ST. GLENDALE, CA. 24-285

SURVEY MAP





Mo	re Bervices	NEIGHBORHOOD ANALYSIS FOR 926 DRYDEN ST. GLENDALE											
PHOTO #	ASSESSOR PARCEL NUMBER	OWNER	SITE ADDRESS	CITY	STATE	ZIP	LOT SQ.FT.	BLDG AREA	FLOOR AREA RATIO	BLDG HEIGHT FT.*	# OF STORIES	SET BACK FT.	YEAR BUILT
1	5646-006-022	PITTS THERESA D CO TR	926 E DRYDEN ST	GLENDALE	CA	91207	6,416	1,334	20.79%	12	1	20'	1924
2	5646-006-021	NAHAS EDWARD O CO TR	930 E DRYDEN ST	GLENDALE	CA	91207	6,265	1,891	30.18%	16	2	20'	1926
3	5646-006-020	KARAGHOUSIAN CHANT	934 E DRYDEN ST	GLENDALE	CA	91207	6,532	1,700	26.03%	18	1	20'	1927
4	5646-006-019	MOLINO LINDA M TR ET AL	938 E DRYDEN ST	GLENDALE	CA	91207	6,144	2,146	34.93%	12	1	20'	1926
5	5646-006-018	ARTINIAN KEVORK & HAMESD	942 E DRYDEN ST	GLENDALE	CA	91207	6,556	1,687	25.73%	16	2	20'	1928
6	5646-006-017	CAMPOS JOSE A CO TR	944 E DRYDEN ST	GLENDALE	CA	91207	6,618	1,514	22.88%	12	1	20'	1927
7	5646-006-016	AKHOYAN MARY	950 E DRYDEN ST	GLENDALE	CA	91207	6,829	1,708	25.01%	11	1	20'	1925
8	5646-006-015	BLUMSTEIN BRETT E & TIFFANY A	954 E DRYDEN ST	GLENDALE	CA	91207	8,369	2,034	24.30%	18	1	20'	1926
9	5646-006-036	VILLALON MARIUS A CO TR	951 E DRYDEN ST	GLENDALE	CA	91207	5,467	2,348	42.95%	20	2	20'	1926
10	5646-006-037	YEPREMAIN VATCHE N	947 E DRYDEN ST	GLENDALE	CA	91207	6,270	1,088	17.35%	17	1	20'	1924
11	5646-006-038	BADALYAN HENRY	941 E DRYDEN ST	GLENDALE	CA	91207	7,391	2,153	29.13%	18	1	20'	1927
12	5646-006-023	GILPIN TIMOTHY	1100 CORDOVA AVE	GLENDALE	CA	91207	6,522	1,743	26.72%	11	1	20'	1930
13	5646-004-001	MALAKIAN DARON	917 E DRYDEN ST	GLENDALE	CA	91207	8,028	2,477	30.85%	20	2	20'	1928
14	5646-004-014	GREGG RONALD E II & CAITLIN E	1102 N CEDAR ST	GLENDALE	CA	91207	7,475	2,294	30.69%	24	2	20	1928
15	5646-005-015	CHAPMAN STEVEN E CO TR	1014 N CEDAR ST	GLENDALE	CA	91207	8,425	2,232	26.49%	26'	2	20	1928
16	5646-005-008	SHELDON MILA T	1017 CORDOVA AVE	GLENDALE	CA	91207	7,998	2,495	31.20%	24	2	20	1937
NOTES													
* INCLUD	* INCLUDES GRADE DIFFERENTIAL AT ENTRIES.												

State of California - The Resources Agency DEPARTMENT OF PARKS AND RECREATION	Primary # HRI #						
PRIMARY RECORD	Trinomial						
Other Listings	NRHP Status Code 5D1 Rossmoyne Historic District Contributor						
Review Code	Reviewer Date						
	e or #: (Assigned by recorder) 926 E DRYDEN ST						
· — —							
P1. Other Identifier: *P2. Location: Not for Publication X Unrest	ricted *a. County Los Angeles and (P2b and P2c or P2d.)						
*b. USGS 7.5' Quad: Pasadena							
c. Address: 926 E DRYDEN ST	City: GLENDALE Zip: 91207						
d. UTM: (Give more than one for large and/or linear							
e. Other Locational Data: (e.g., parcel #, directions	to resource, elevation, etc., as appropriate): APN:5646006022						
*P3a. Description: (Describe resource and its major element	nts. Include design, materials, condition, alterations, size, setting, and boundaries)						
Architectural Style: Spanish Colonial Revival Siding/Sheathing: stucco: smooth, all visible sides Roof: cross-gable, low, red tile Fenestration: wood, divided-light casement Primary Entrance: single door, recessed Other notable features: elaborate Spanish porch columns	Plan: irregular No. Stories: 1 Porches: partial width, front Retains integrity: high						
*P3b. Resource Attributes: (List attributes and codes) *P4. Resources Present: X Building Structure P5a. Photo or Drawing (Photo required for buildings, s	HP02 Object Site District X Element of District Other (Isolates, etc. structures, and objects.) P5b. Description of photo: (View, data, accession #) 03/07/11 *P6. Date Constructed/Age and Sources: X Historic Prehistoric Both 1924 Assessor *P7. Owner and Address:						
	MARTIN, PEPPER AND GEORGINA E TR: 926 DRYDEN ST GLENDALE CA 912070000 *P8. Recorded by: Tanya Sorrell LSA Associates 1500 Iowa Ave., Suite 200 Riverside, CA 92507 *P9. Date Recorded: 03/07/2011						
	*P10. Survey Type: (Describe)						
*D44 Panert Citation (Cita survey report and other source	Historic District Survey						
*P11. Report Citation: (Cite survey report and other source Sorrell, Tanya. Rossmoyne Historic Resources Survey. Pro							
Zonon, ranga resomogno motorie resources burvey. Th	epined of Dorrior the only of Olemano, 2011.						
*Attachments:NoneLocation MapSketch Archeological RecordX District R Rock Art RecordArtifact Record							

DPR 523A (1/95) *Required Information